

**SETBACK**

FRONT 25'-0"  
SIDE 10'-0" ( FIRST STORY)  
SIDE 17'-6" ( SECOND STORY)  
REAR 25'-0"

1 SITE PLAN  
1/8" = 1'-0"



SITE PLAN  
AHMED RENOVATION  
ALINA AHMED  
LOT 15  
1081 NOTTINGHAM WAY  
LOS ALTOS, CA 94024

No.	DATE:	DELTA DESCRIPTION:
1	22/09/17	CITY SUBMITTAL
2		
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DATE: 22/09/17  
SCALE: 1/8" = 1'-0"  
DRAWN BY :  
CKD BY:  
PROJECT : 202107199





**2019 CALGREEN RESIDENTIAL CHECKLIST**  
**MANDATORY ITEMS - Version 1.01.20**  
COMMUNITY DEVELOPMENT DEPARTMENT – BUILDING DIVISION  
KIRK BALLARD, BUILDING OFFICIAL  
ONE NORTH SAN ANTONIO ROAD • LOS ALTOS, CA 94022-3088  
(650) 947-2752 • FAX/EMAIL- BUILDING@LOSALTOSCA.GOV • WWW.LOSALTOSCA.GOV

**PURPOSE:**

The 2019 CALGreen Code applies to all newly constructed hotels, motels, lodging houses, dwellings, dormitories, condominiums, shelters, congregate residences, employee housing, factory-built housing and other types of dwellings with sleeping accommodations and new accessory buildings associated with such uses. This section also applies to additions and alterations where there is an increase in conditioned space and specifies that these requirements only apply to the specific area of the addition or alteration. Existing site and landscaping improvements that are not otherwise disturbed are not subject to the requirements of CALGreen.

Project Name: Alina Ahmed Remodel and addition

Project Address: 1081 Nottingham Way Los Altos CA 94204

Project Description: INTERIOR REMODEL, 1263 SF KITCHEN, DINING ROOM, LIVING ROOM AND FAMILY ROOM. NEW 50 SF READING ROOM ADDITION AND 218 SF BATHROOM AT LEVEL 2 ADDITION.

**Instructions (for projects of 300 sq. ft. or more):**

- The owner or owner's agent shall employ a licensed qualified green-point rater ([www.builditgreen.org](http://www.builditgreen.org)) experienced with the 2019 California Green Building Standards Codes to verify and assure that all required work described herein is properly planned and implemented in the project.
- The green-point rater, in collaboration with the design professional shall review **Column 2** of this checklist, and initial all applicable measures, sign and date **Section 1 –Design Verification** at the end of this checklist., prior to submittal. Applicant to include these pages into the construction plans as well as provide (2) separate 8-1/2" x 11" signed copies.
- PRIOR TO FINAL INSPECTION BY THE BUILDING DEPARTMENT,** the Green-Point Rater shall complete Column 3 and sign and Date **Section 2 – Implementation Verification** at the end of this checklist and submit the completed form to the Building Department.

MANDATORY FEATURE OR MEASURE	COLUMN 2 Project Requirements Rater to initial applicable measures prior to submitting forms	COLUMN 3 Verification Rater to verify during construction as applicable to project
<b>Planning and Design – Site Development</b>		
4.106.2 A plan is developed and implemented to manage storm water drainage during construction	PK	
4.106.3 Construction plans shall indicate how site grading or a drainage system will manage all surface water flows to keep water from entering buildings.	PK	
4.106.4 Provide capability for electric vehicle charging for one- and two-family dwellings; townhouses with attached private garages; multifamily dwellings; and hotels/motels in accordance with Section 4.106.4.1, 4.106.4.2 or 4.106.4.3 as applicable.	NOT APPLICABLE  THIS IS REMODEL/MINOR ADDITION	

<b>Energy Efficiency – General</b>		
4.201.1 Building meets or exceeds the requirements of the <i>California Building Energy Efficiency Standards</i> <sup>3</sup> .	PK	
<b>Water Efficiency and Conservation – Indoor Water Use</b>		
4.303.1 Plumbing fixtures (water closets and urinals) and fittings (faucets and showerheads) installed in residential buildings shall comply with the prescriptive requirements of Sections 4.303.1.1 through 4.303.1.4.4.	PK	
4.303.2 Plumbing fixtures and fittings required in Section 4.303.1 shall be installed in accordance with the <i>California Plumbing Code</i> , and shall meet the applicable referenced standards.	PK	
4.303.1.4.3 Metering faucets in residential buildings shall not deliver more than 0.2 gallons per cycle.	PK	
<b>Outdoor Water Use</b>		
4.304.1 Residential developments shall comply with a local water efficient landscape ordinance or the current California Department of Water Resources' Model Water Efficient Landscape Ordinance (MWEL0), whichever is more stringent.	PK	
<b>Material Conservation and Resource Efficiency – Enhanced Durability and Reduced Maintenance</b>		
4.406.1 Annular spaces around pipes, electric cables, conduits or other openings in plates at exterior walls shall be protected against the passage of rodents by closing such openings with cement mortar, concrete masonry or similar method acceptable to the enforcing agency.	PK	
<b>Construction Waste Reduction, Disposal and Recycling</b>		
4.408.1 Recycle and/or salvage for reuse a minimum of 65 percent of the nonhazardous construction and demolition waste in accordance with one of the following: 1. Comply with a more stringent local construction and demolition waste management ordinance; or 2. A construction waste management plan per Section 4.408.2; or 3. A waste management company per Section 4.408.3; or 4. The waste stream reduction alternative per Section 4.408.4.	PK	
<b>Building Maintenance and Operation</b>		
4.410.1 An operation and maintenance manual shall be provided to the building occupant or owner.	PK	
4.410.2 Where 5 or more multifamily dwelling units are constructed on a building site, provide readily accessible areas that serve the entire building and are identified for the depositing, storage and collection of non-hazardous materials for recycling, including (at a minimum) paper, corrugated cardboard, glass, plastics, organic waste, and metals or meet a lawfully enacted local recycling ordinance, if more restrictive. See exception for rural jurisdictions	NOT APPLICABLE	

<b>ENVIRONMENTAL QUALITY</b>		
<b>Fireplaces</b>		
4.503.1 Any installed gas fireplace shall be a direct-vent sealed-combustion type. Any installed woodstove or pellet stove shall comply with US EPA New Source Performance Standards (NSPS) emission limits as applicable, and shall have a permanent label indicating they are certified to meet the emission limits. Woodstoves, pellet stoves and fireplaces shall also comply with applicable local ordinances.	PK	
<b>Pollutant Control</b>		
4.504.1 Duct openings and other related air distribution component openings shall be covered during construction.	PK	
4.504.2.1 Adhesives, sealants and caulks shall be compliant with VOC and other toxic compound limits.	PK	
4.504.2.2 Paints, stains and other coatings shall be compliant with VOC limits.	PK	
4.504.2.3 Aerosol paints and coatings shall be compliant with product weighted MIR limits for ROC and other toxic compounds.	PK	
4.504.2.4 Documentation shall be provided to verify that compliant VOC limit finish materials have been used.	PK	
4.504.3 Carpet and carpet systems shall be compliant with VOC limits.	PK	
4.504.4 80 percent of floor area receiving resilient flooring shall comply with specified VOC criteria.	PK	
4.504.5 Particleboard, medium density fiberboard (MDF) and hardwood plywood used in interior finish systems shall comply with low formaldehyde emission standards.	PK	
<b>Interior Moisture Control</b>		
4.505.2 Vapor retarder and capillary break is installed at slab-on-grade foundations.	PK	
4.505.3 Moisture content of building materials used in wall and floor framing is checked before enclosure.	PK	
<b>Indoor Air Quality and Exhaust</b>		
4506.1 Each bathroom shall be provided with the following: 1. ENERGY STAR fans ducted to terminate outside of the building. 2. Fans must be controlled by a humidity control (separate or built-in); OR functioning as a component of a whole-house ventilation system. 3. Humidity controls with manual or automatic means of adjustment, capable of adjustment between a relative humidity range of ≤ 50 percent to a maximum of 80 percent	PK	



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<b>Environmental Comfort</b>		
4.507.2 Duct systems are sized, designed, and equipment is selected using the following methods: 1. Establish heat loss and heat gain values according to ANSI/ACCA 2 Manual J-2016 or equivalent. 2. Size duct systems according to ANSI/ACCA 1 Manual D-2016 or equivalent. 3. Select heating and cooling equipment according to ANSI/ACCA 3 Manual S-2014 or equivalent.	PK	
<b>Installer and Special Inspector Qualifications</b>		
<b>Qualifications</b>		
702.1 HVAC system installers are trained and certified in the proper installation of HVAC systems.	PK	
702.2 Special inspectors employed by the enforcing agency must be qualified and able to demonstrate competence in the discipline they are inspecting.	PK	
<b>Verifications</b>		
703.1 Verification of compliance with this code may include construction documents, plans, specifications builder or installer certification, inspection reports, or other methods acceptable to the enforcing agency which show substantial conformance.	PK	
1. Green building measures listed in this table may be mandatory if adopted by a city, county, or city and county as specified in Section 101.7 2. Required prerequisite for this Tier. 3. These measures are currently required elsewhere in statute or in regulation		



CALGREEN SIGNATURE DECLARATIONS

Project Name: Alina Ahmed Remodel and addition

Project Address: 1081 Nottingham Way Los Altos CA 94204

Project Description: INTERIOR REMODEL, 1263 SF KITCHEN, DINING ROOM, LIVING ROOM AND FAMILY ROOM. NEW 50 SF READING ROOM ADDITION AND 218 SF BATHROOM AT LEVEL 2 ADDITION.

**SECTION 1 – DESIGN VERIFICATION**

Complete all lines of Section 1 – "Design Verification" and **SUBMIT THE ENTIRE CHECKLIST (COLUMNS 2 AND 3) WITH THE PLANS AND BUILDING PERMIT APPLICATION TO THE BUILDING DEPARTMENT.**

The design professional responsible for compliance with CalGreen Standards has reviewed the plans and certifies that the items checked above are hereby incorporated into the project plans and will be implemented into the project in accordance with the requirements set forth in the **2019 California Green Building Standards Code** as adopted by the City of Los Altos.

Design Professional's Signature	Date
Design Professional's Name (Please Print)	
Signature of Green Point Rater/Certified ICC CalGreen Special Inspector/Consulting Group	Date
Name of Green Point Rater/Inspector (Please Print)	Phone No.
Email Address	License No.

**SECTION 2 – IMPLEMENTATION VERIFICATION**

Complete, sign and submit the completed checklist, including column 3, together with all original signatures on Section 2 to the Building Department **PRIOR TO BUILDING DEPARTMENT FINAL INSPECTION.**

I have inspected the work and have received sufficient documentation to verify and certify that the project identified above was constructed in accordance with this Green Building Checklist and in accordance with the requirements of the **2019 California Green Building Standards Code** as adopted by the City of Los Altos.

Signature of Licensed Green Point Rater/Certified ICC CalGreen Special Inspector/ Consulting Group	Date
Name of Green Point Rater/Inspector (Please Print)	Phone No.
Email address	License No.



CALGREEN

AHMED RENOVATION

ALINA AHMED

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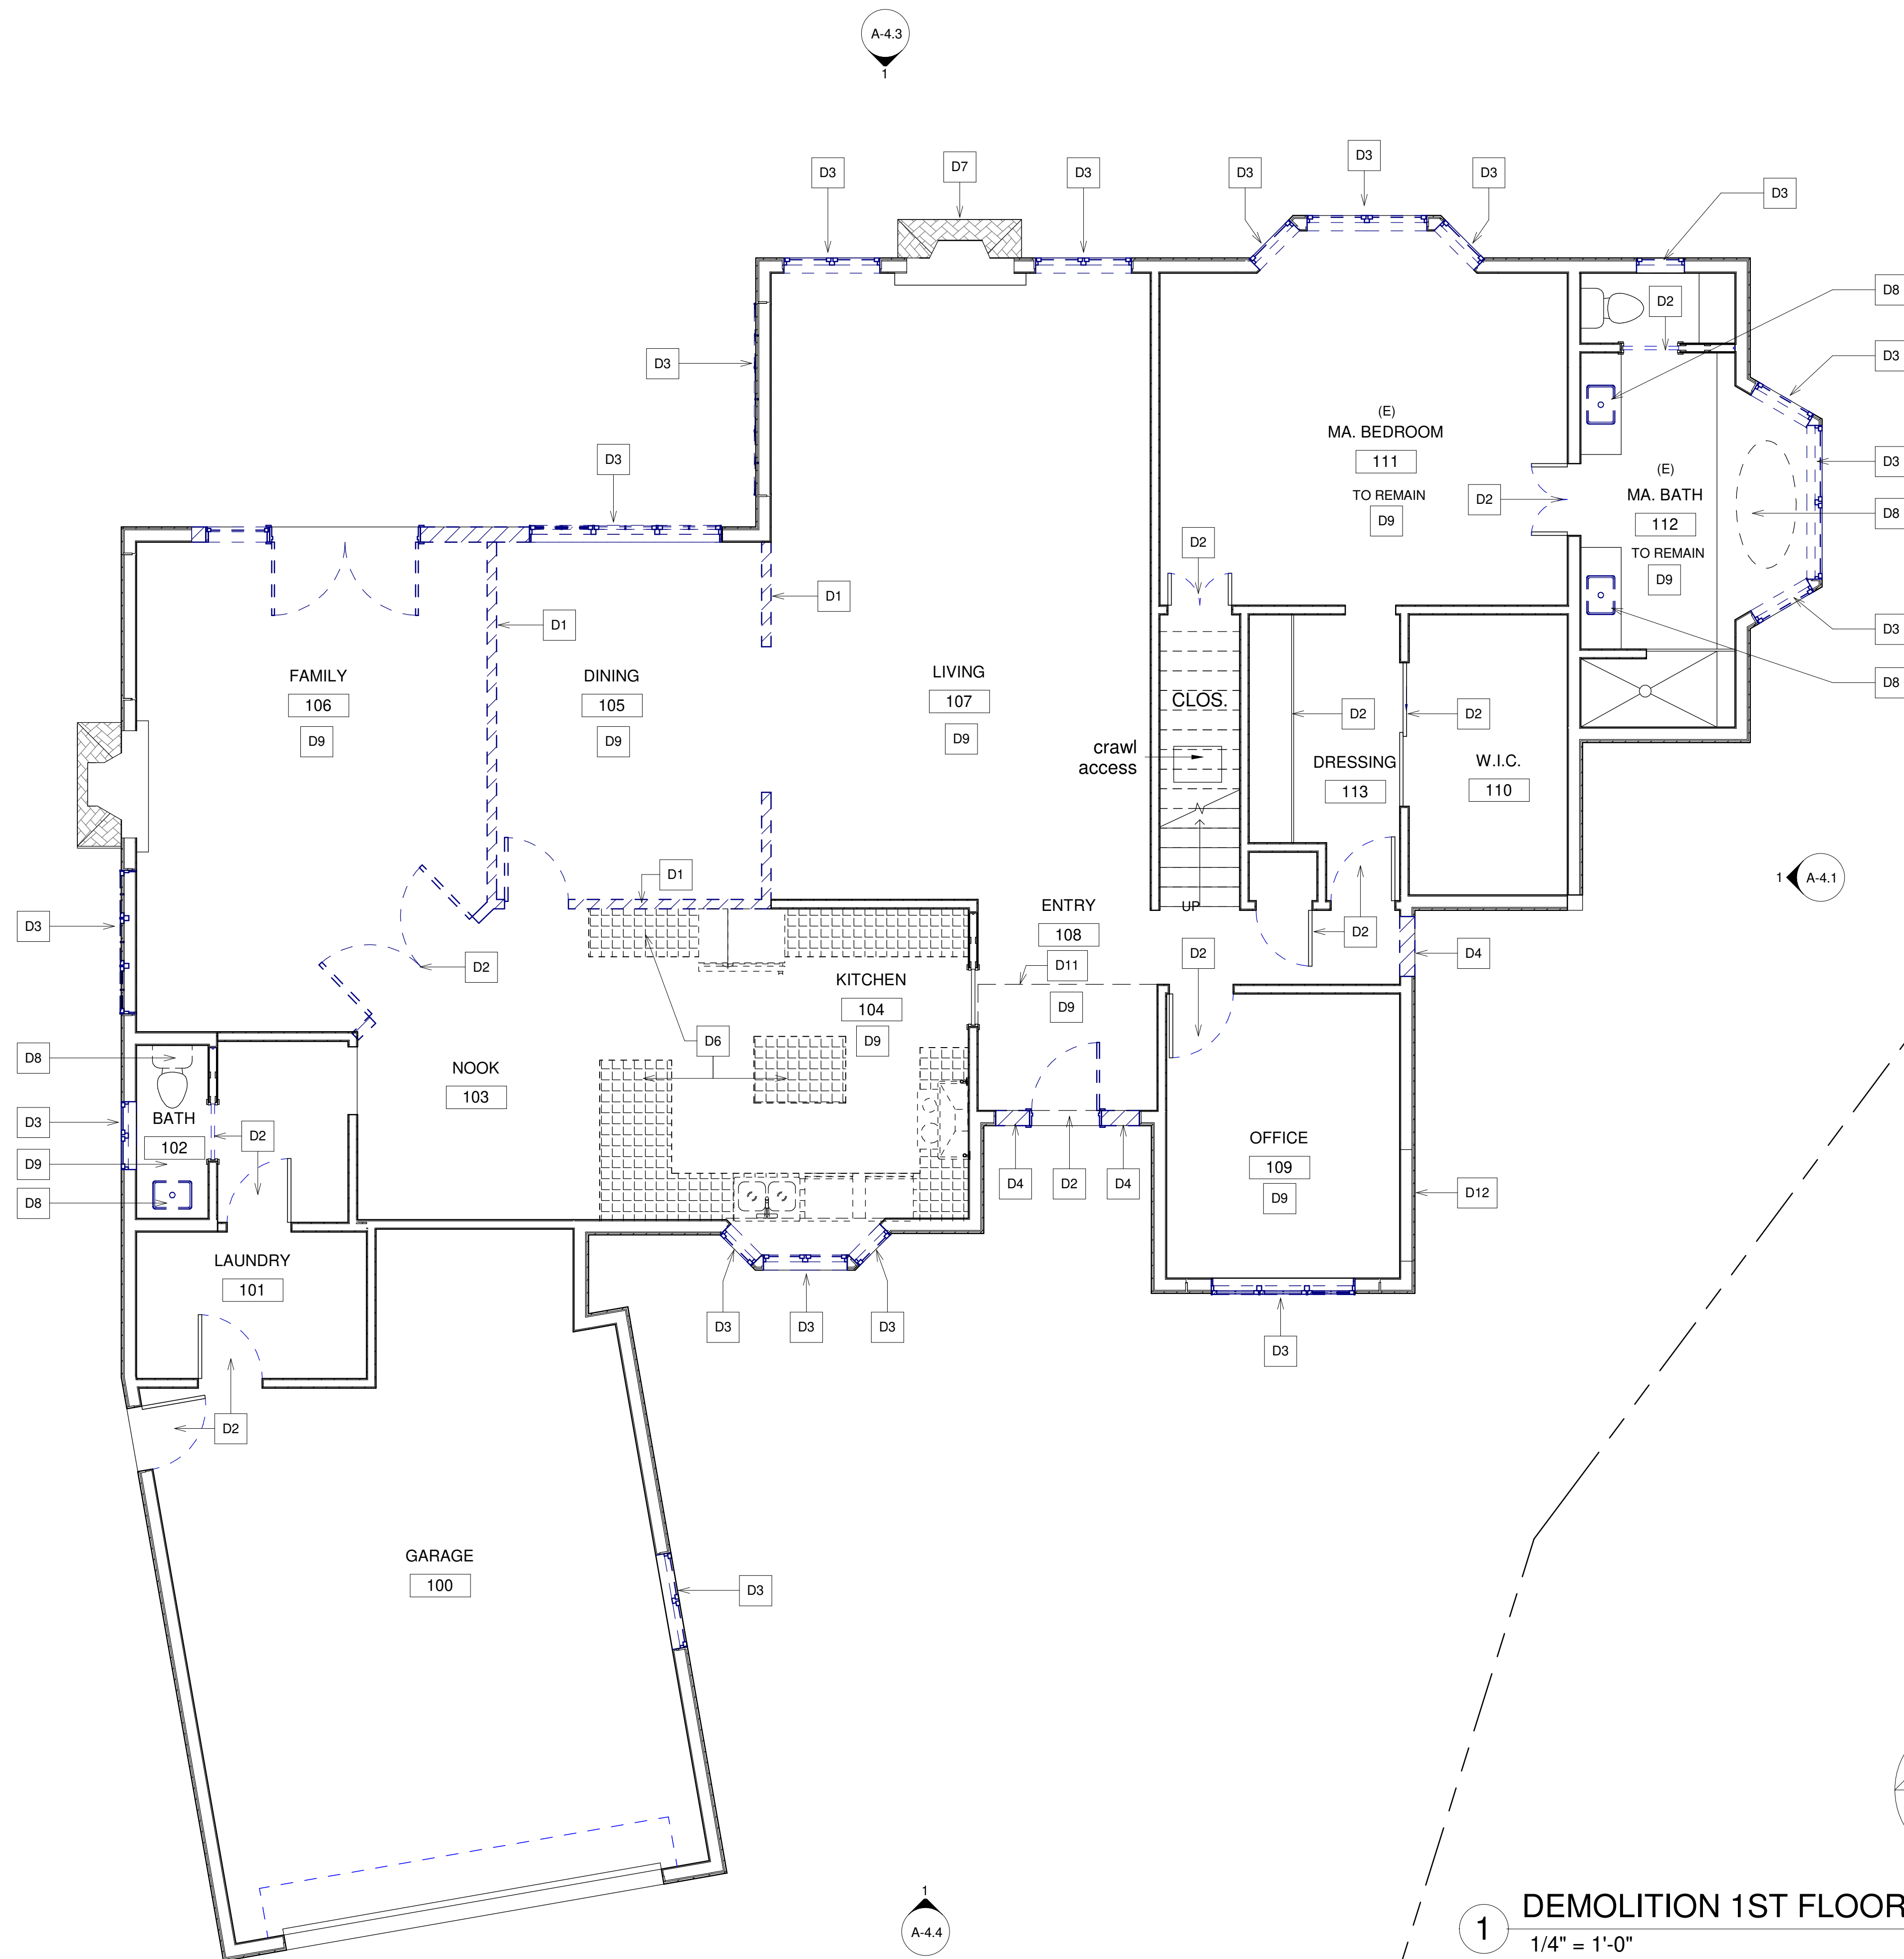
CKD BY:

PROJECT : 202107199

DRAWING NO.

A-1.2





DEMOLITION KEYNOTE

- D1 REMOVE WALL
- D2 REMOVE DOOR
- D3 REMOVE WINDOW
- D4 REMOVE PARTITION OF WALL, PREP FOR NEW OPENING
- D5 VERIFY WITH STRUCTURAL, REUSE / REFURBISH WALL, PREP FOR NEW OPENING AND 2 STORY HEIGHT WALL
- D6 DEMO KITCHEN COUNTERTOP, PREP FOR NEW WORK
- D7 DEMO FIRE PLACE, PREP FOR 2 SIDED FIRE PLACE
- D8 REMOVE PLUMBING FIXTURE
- D9 REMOVE FLOOR FINISH
- D10 DEMO ROOF, PREP FOR BATHROOM ADDITION
- D11 REMOVE FLAT CEILING
- D12 REMOVE WINDOW ENCLOSED WITH WALL
- E1 EXISTING SKYLIGHT TO REMAIN



DEMOLITION 1ST FLOOR PLAN  
AHMED RENOVATION  
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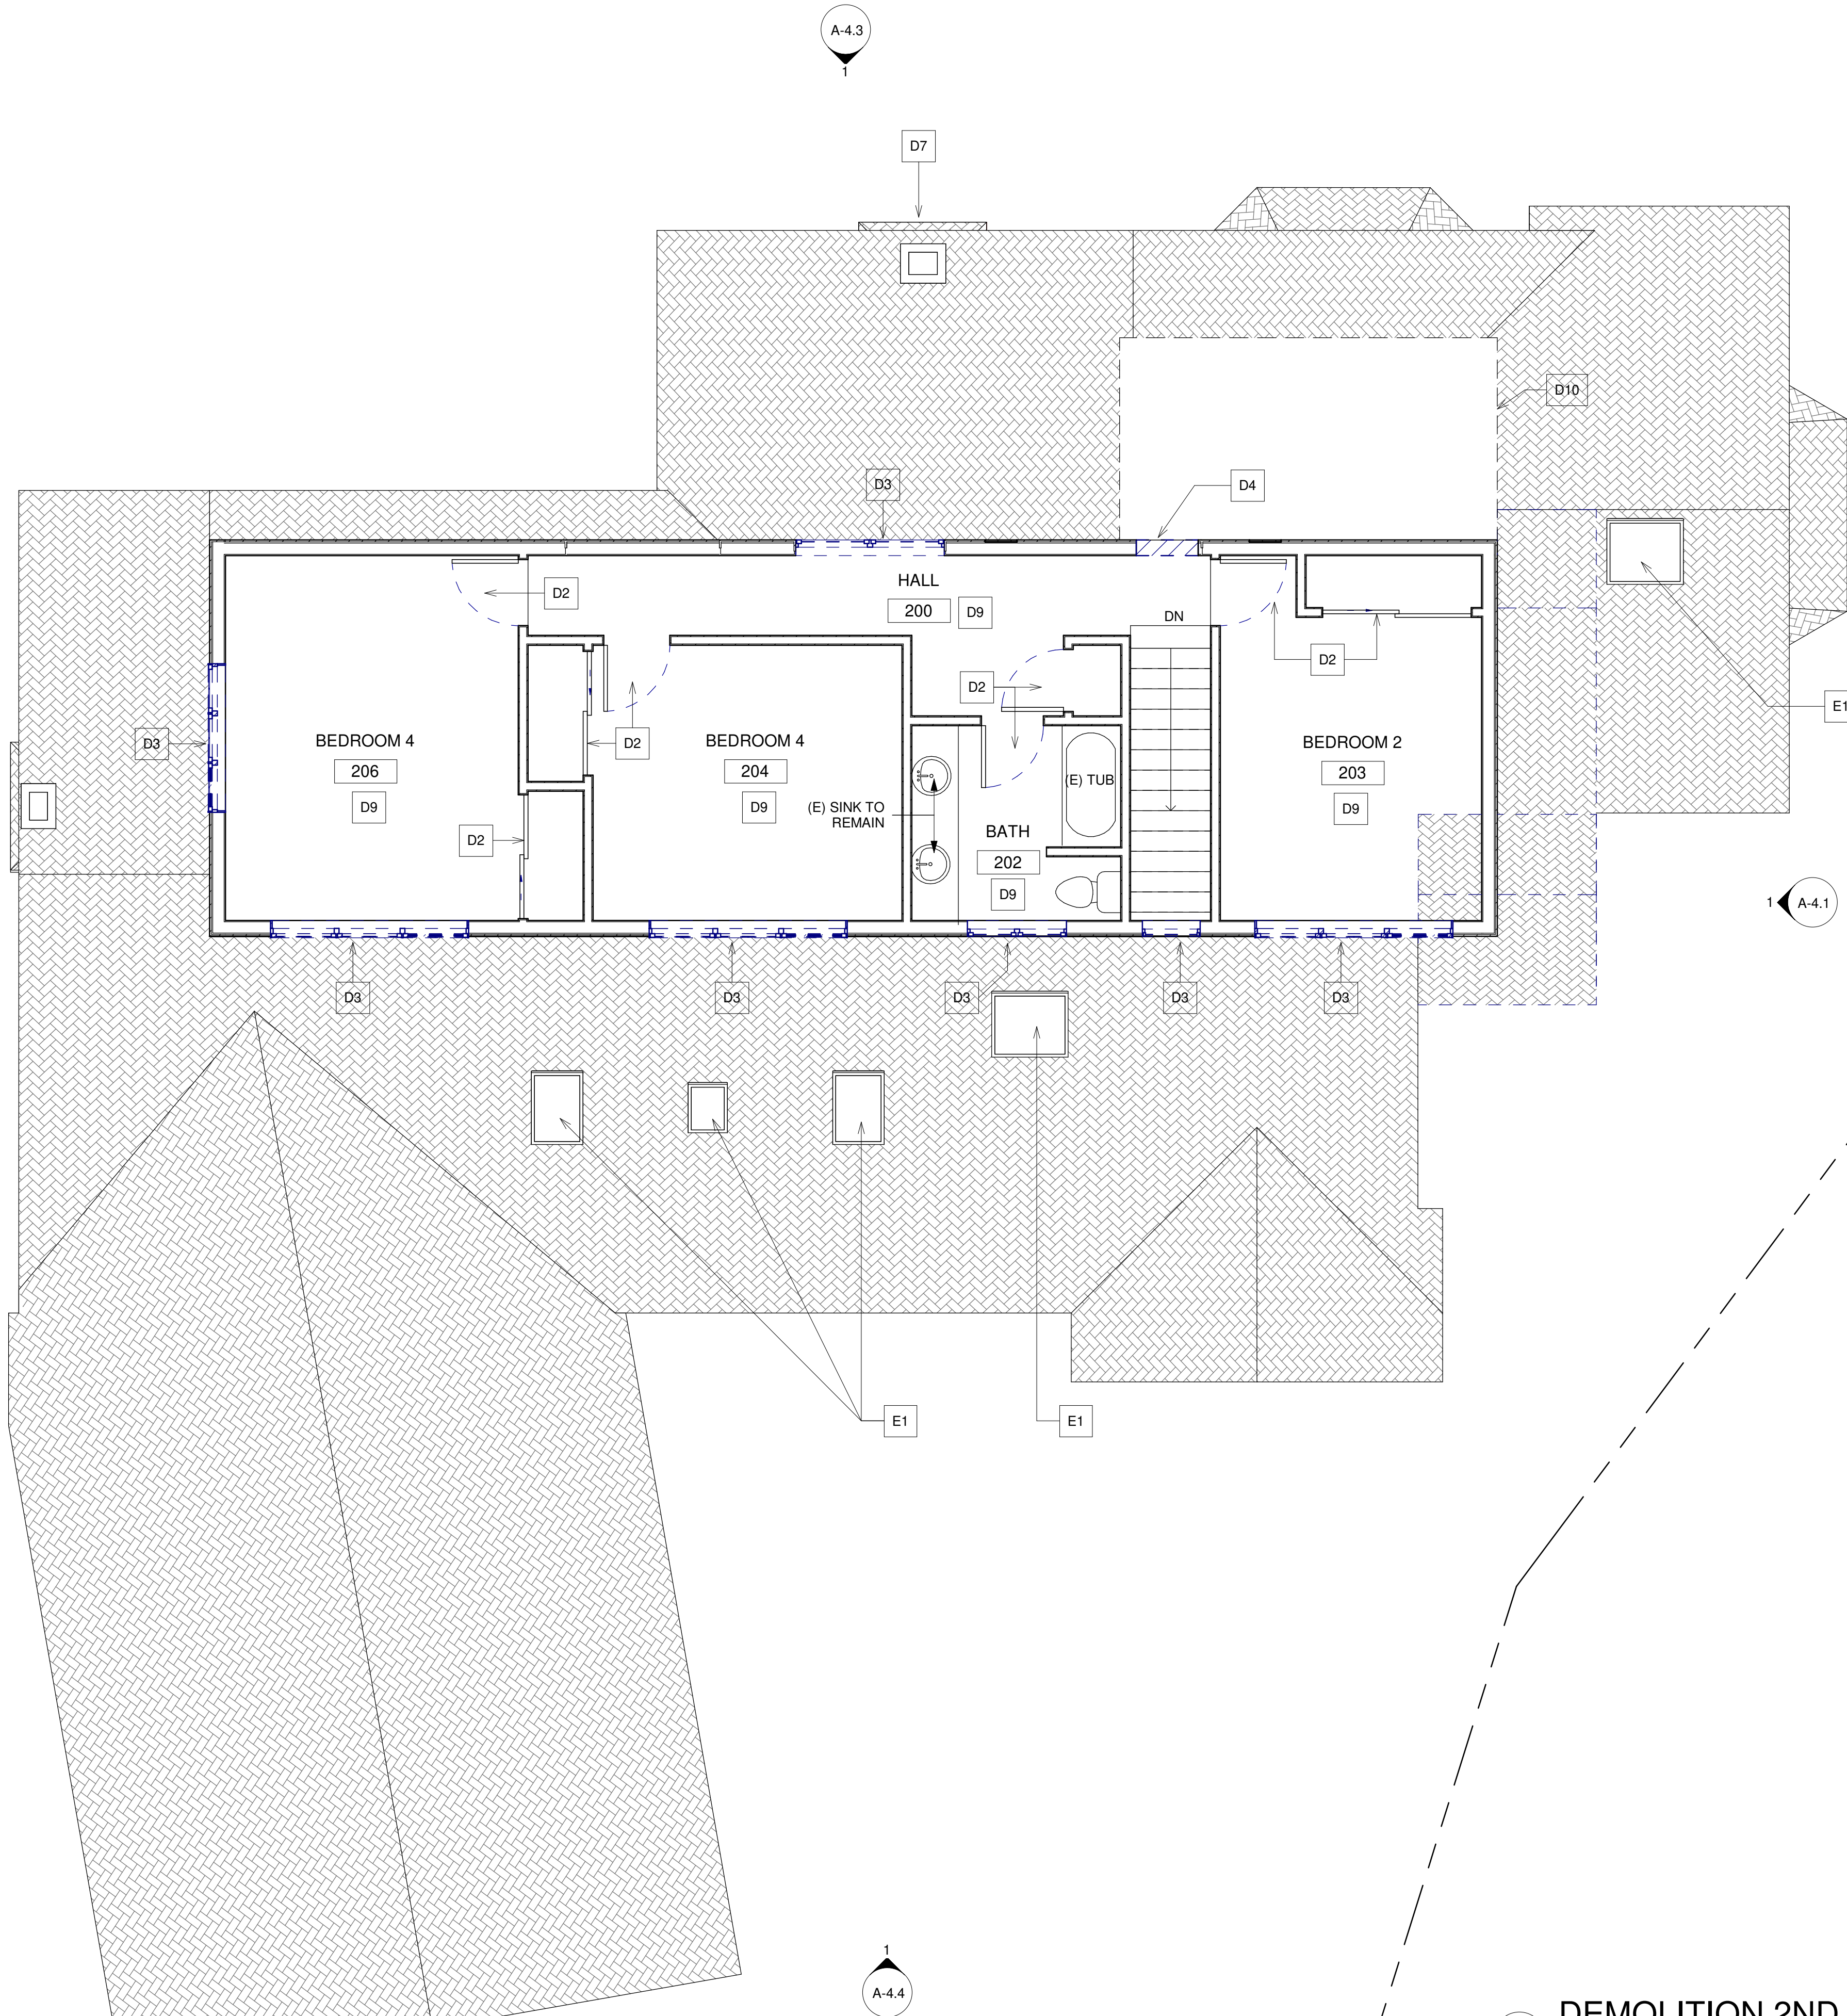
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A-2.1

1 DEMOLITION 1ST FLOOR PLAN  
1/4" = 1'-0"





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- E1 EXISTING SKYLIGHT TO REMAIN



DEMOLITION 2ND FLOOR PLAN  
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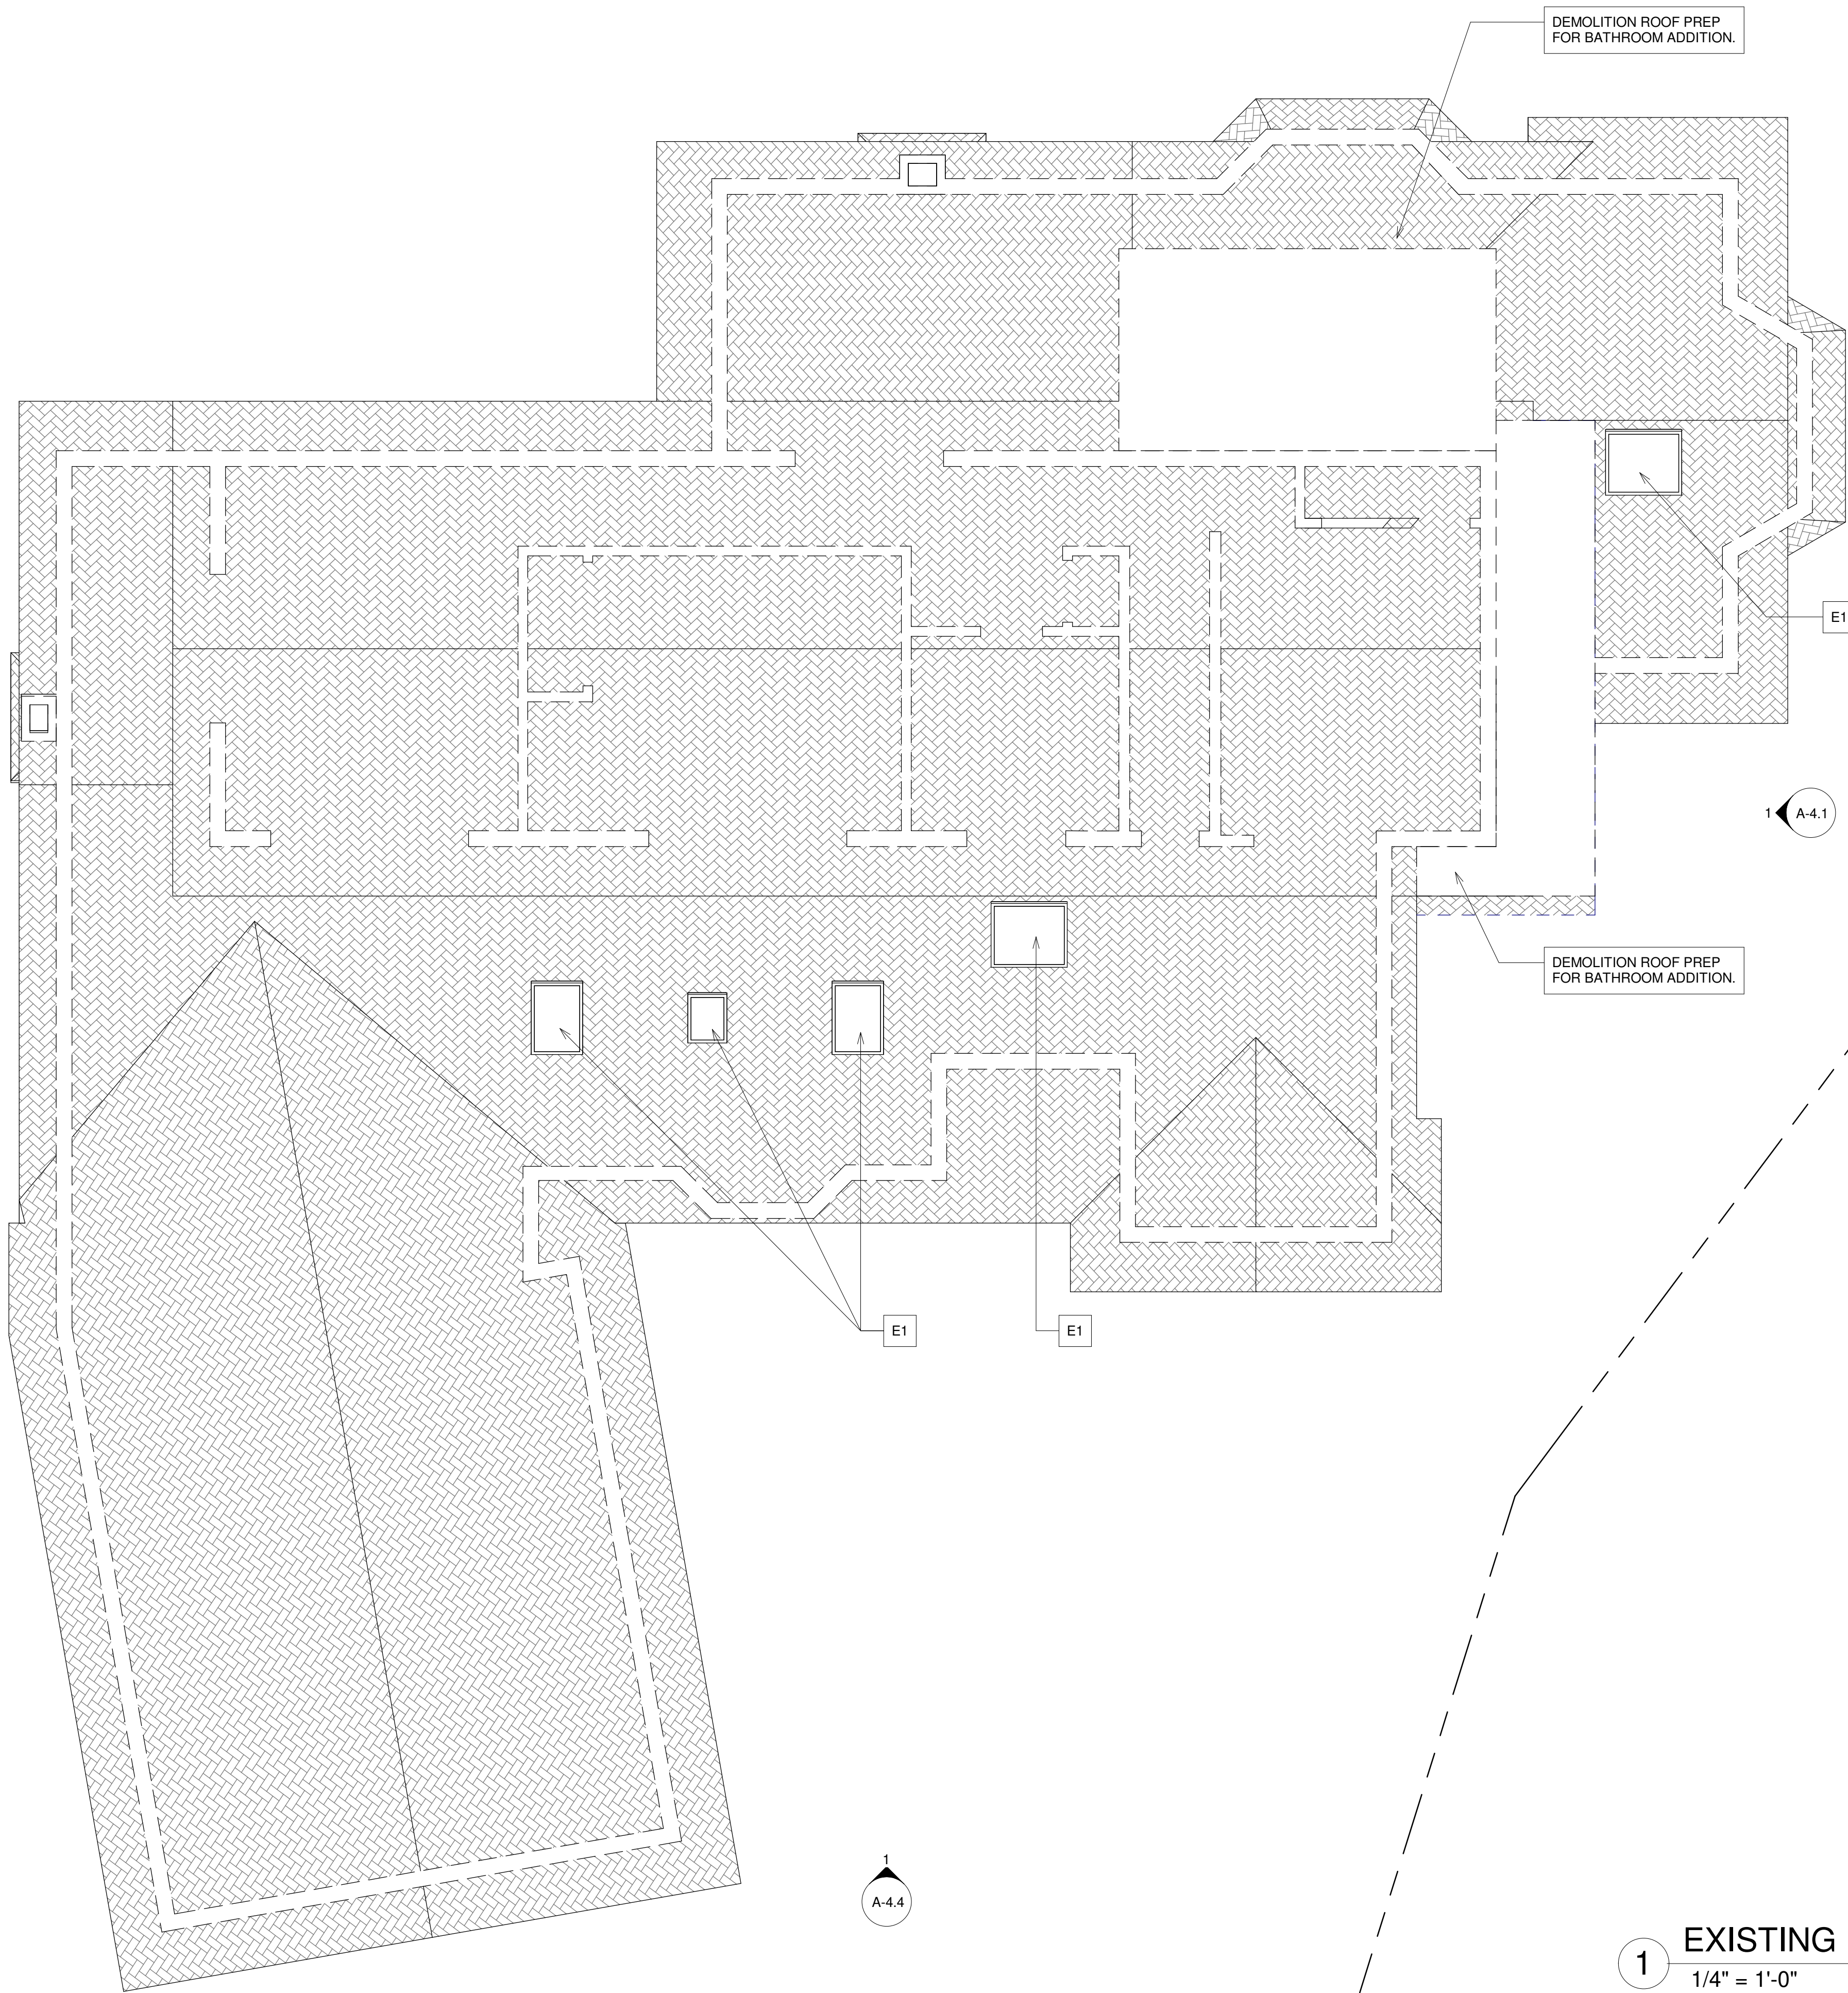
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DRAWING NO.  
A-2.2

1 DEMOLITION 2ND FLOOR PLAN  
1/4" = 1'-0"





- |     |  |
|-----|--|
| D1  | REMOVE WALL  |
| D2  | REMOVE DOOR  |
| D3  | REMOVE WINDOW  |
| D4  | REMOVE PARTITION OF WALL, PREP FOR NEW OPENING   |
| D5  | VERIFY WITH STRUCTURAL, REUSE / REFURBISH WALL, PREP FOR NEW OPENING AND 2 STORY HEIGHT WALL |
| D6  | DEMO KITCHEN COUNTERTOP, PREP FOR NEW WORK   |
| D7  | DEMO FIRE PLACE, PREP FOR 2 SIDED FIRE PLACE   |
| D8  | REMOVE PLUMBING FIXTURE  |
| D9  | REMOVE FLOOR FINISH  |
| D10 | DEMO ROOF, PREP FOR BATHROOM ADDITION  |
| D11 | REMOVE FLAT CEILING  |
| D12 | REMOVE WINDOW ENCLOSED WITH WALL   |
| E1  | EXISTING SKYLIGHT TO REMAIN  |




DEMOLITION ROOF PLAN  
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**A-2.3**





1 PROPOSED 1ST FLOOR PLAN  
1/4" = 1'-0"

DESIGN ALTERATION AT (N) BATH 114

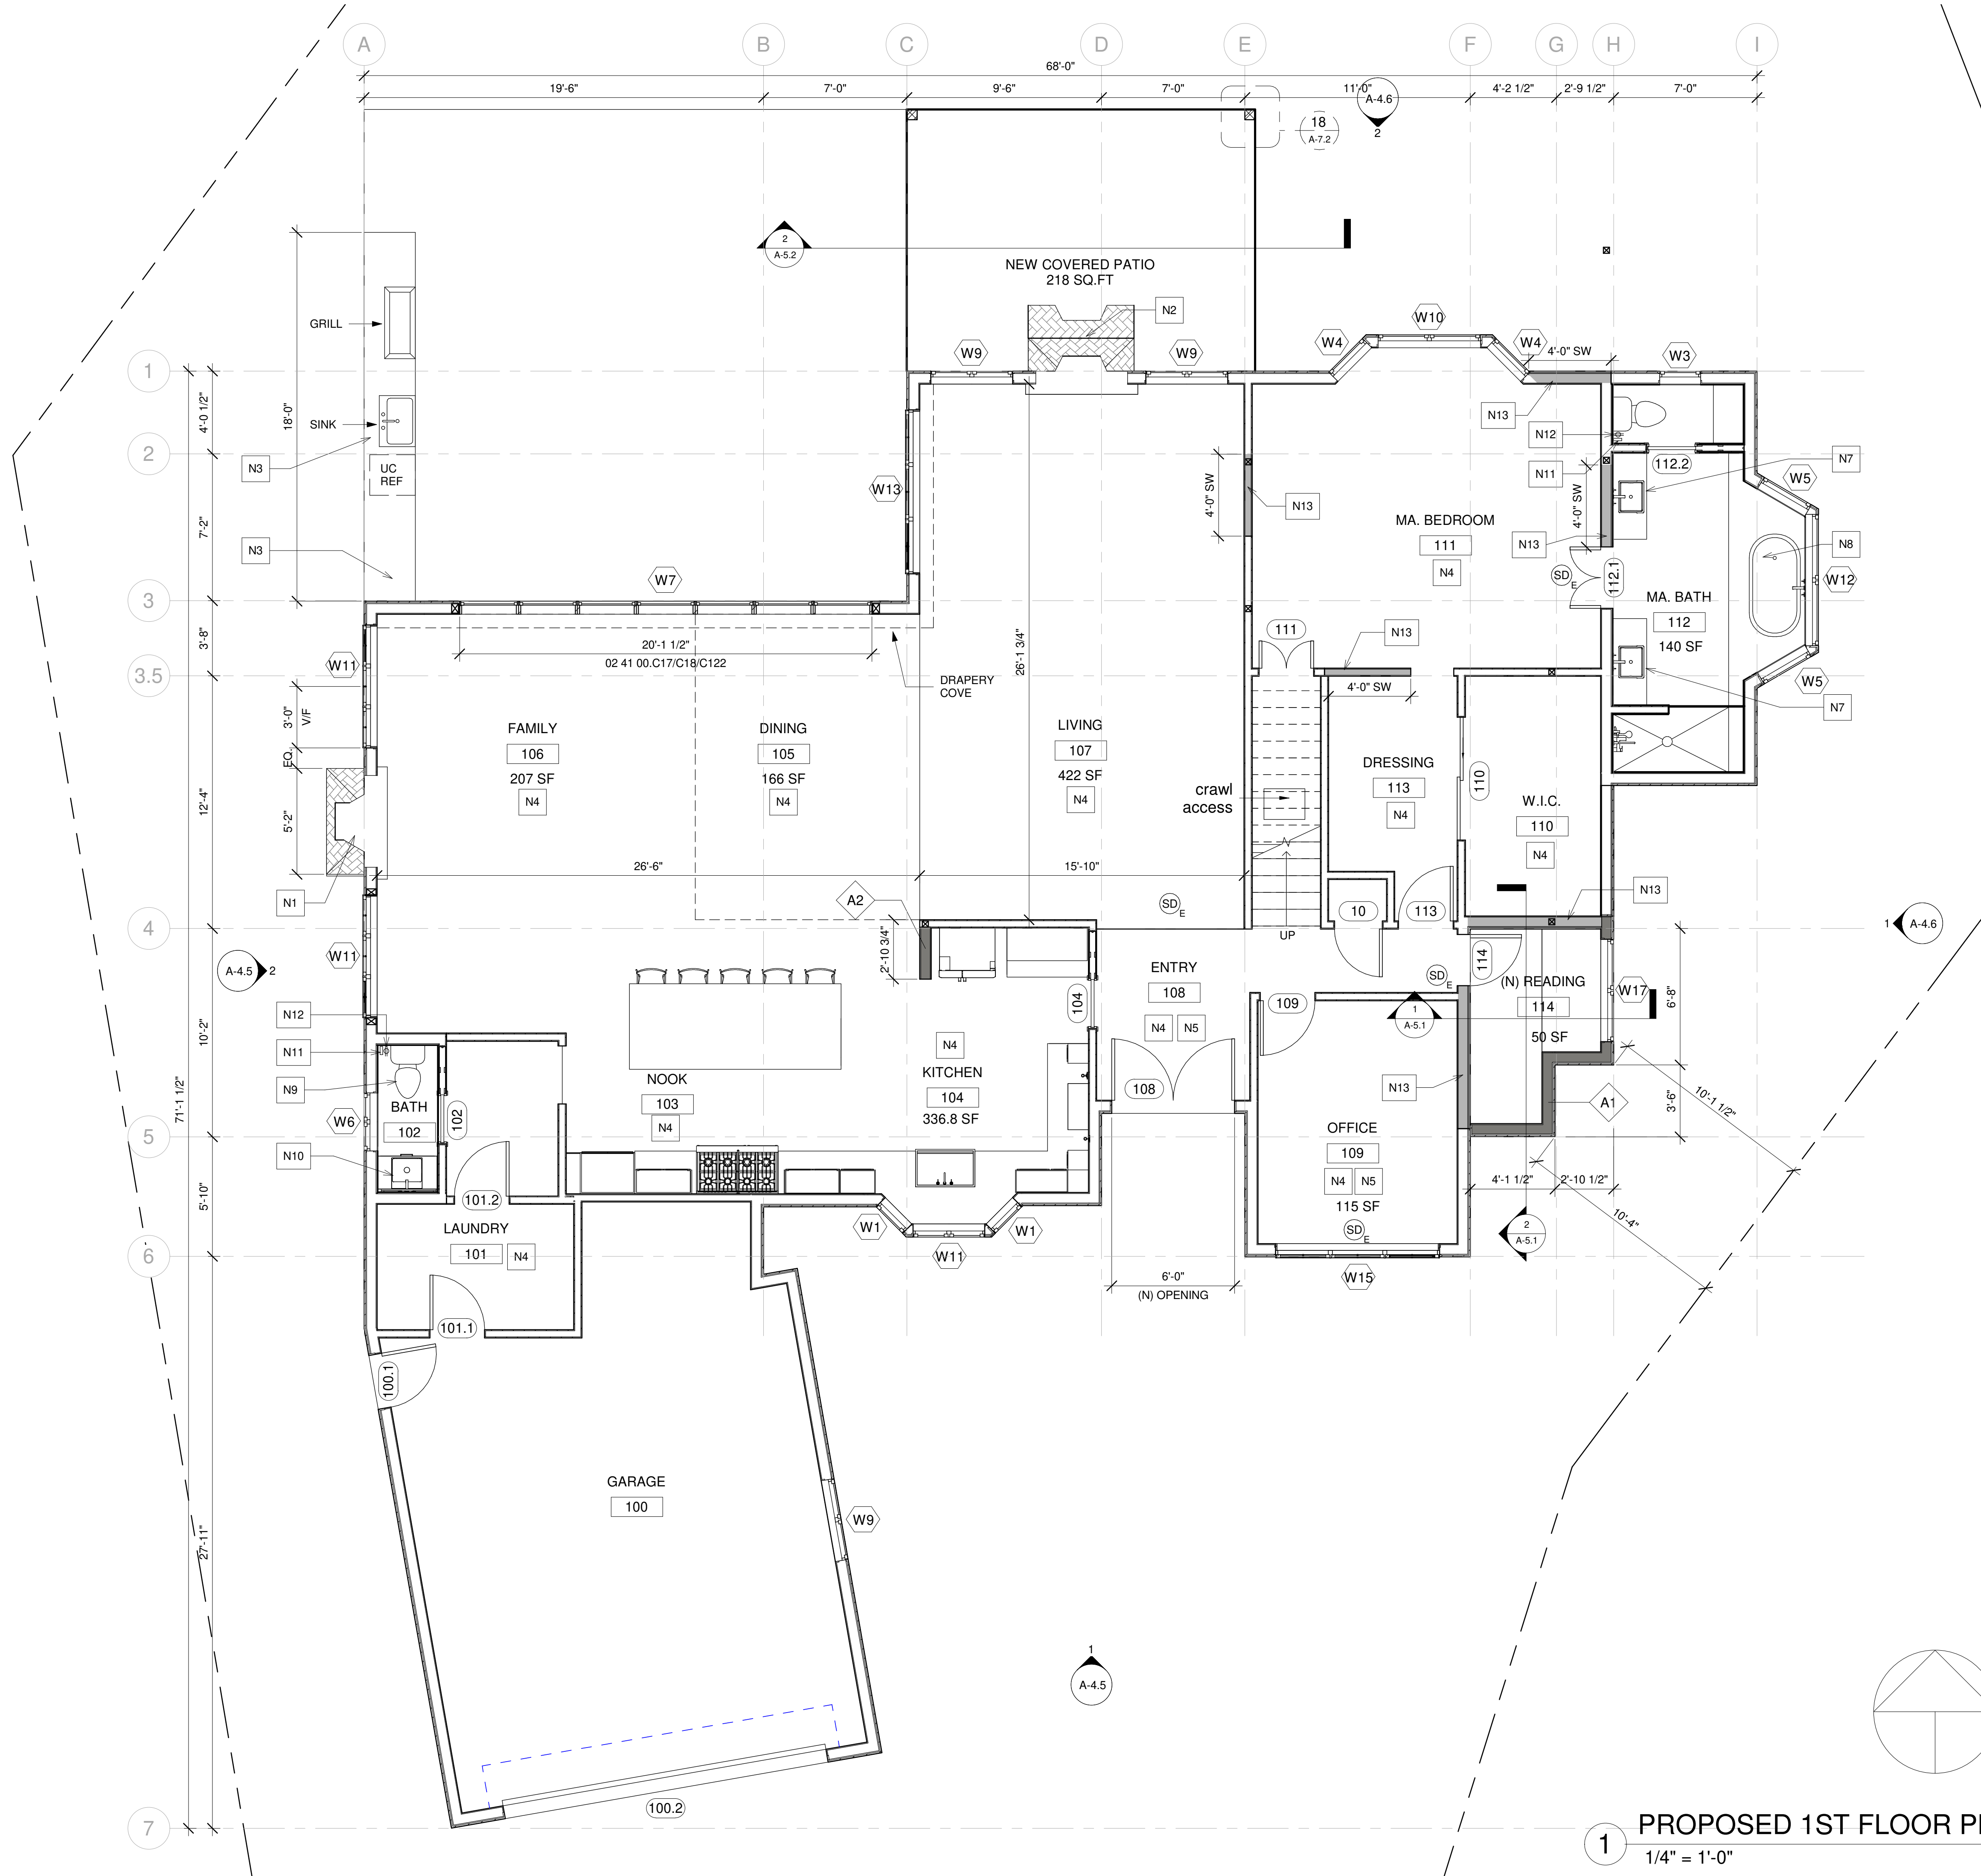1. NEW BATHROOM  
2. NEW STORAGE W/ PLUMBING STUD-OUTS  
3. NEW STORAGE ROOM W/O PLUMBING

DESIGN NOTES:-

1. WOOD FLOORS THROUGHOUT LEVELS 1& 2.  
2. REPLACE WOOD FIREPLACE W/ GAS INSERTS  
3. COFFEE BAR AT BREAKFAST NOOK AREA W/:  
a. HAND SINK  
b. UNDER-COUNTER REFRIGERATOR  
c. BULKHEAD TO ALIGN W/ UPPER KITCHEN CABINETS  
4. EXTERIOR KITCHEN W/  
a. BUILT-IN GRILL  
b. HAND SINK  
c. UNDER-COUNTER REFRIGERATOR  
5. NEW EXTERIOR FIREPLACE DETACHED FROM DWELLING  
6. FLOATING SINK & VANITY IN POWER 111  
7. NEW VANTIES, COUNTERTOPS & SINKS IN BATH 114.  
8. NEW OVERSIZED SOAKING TUB IN BATH 107  
9. STONE PATIO TO MATCH EXISTING  
10. ADD CATHEDRAL CEILING ABOVE FOYER

LEGEND

- A1 7/8" PLASTER  
0' WATERPROOFING  
0' SHEATHING  
0' 2X6 WOOD STUD  
0' GYP ON INTERIOR SIDE
- A2 5/8" GYPSUM BOARD  
0' 2X4 WOOD STUD  
5/8" GYPSUM BOARD
- SD E EXISTING SMOKE DETECTOR TO REMAIN

KEY NOTE

KEY NOTE

- N1 ADD GAS TO EXISTING FIRE PLACE  
N2 REFURBISH EXISTING FIRE PLACE INTO 2 SIDED FIRE PLACE  
N3 OUTDOOR BBQ  
N4 NEW FLOORING  
N5 REMOVE FLAT CEILING  
N6 PROVIDE SKYLIGHT  
N7 FLOATING SINK WITH VANITY  
N8 NEW TUB  
N9 NEW WATER CLOSET  
N10 NEW SINK  
N11 NEW BIDET  
N12 GFCI OUTLET  
N13 REFURBISH EXISTING WALL, PREP FOR NEW SHEAR WALL PER STRUCTURAL  
N14 18" X 24" ROOF VENT 72 SQ.INCH EACH  
E1 EXISTING SKYLIGHT TO REMAIN

LEGEND

- FIXTURE TAG REFER TO A8.9 & A8.10
- FINISH TAG REFER TO A8.9

DESIGN EVEREST  
CONSULTING ENGINEERS




PROPOSED 1ST FLOOR PLAN  
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DRAWING NO.  
A-3.1





1 PROPOSED 2ND FLOOR PLAN  
1/4" = 1'-0"

- DESIGN NOTES:-
1. WOOD FLOORS THROUGHOUT LEVELS 1&2
  2. REPLACE OCTAGON WINDOW IN STAIR WELL
  3. ADD (2) NEW SKYLIGHT ABOVE HOME OFFICE
  4. REFURBISH BATH 202
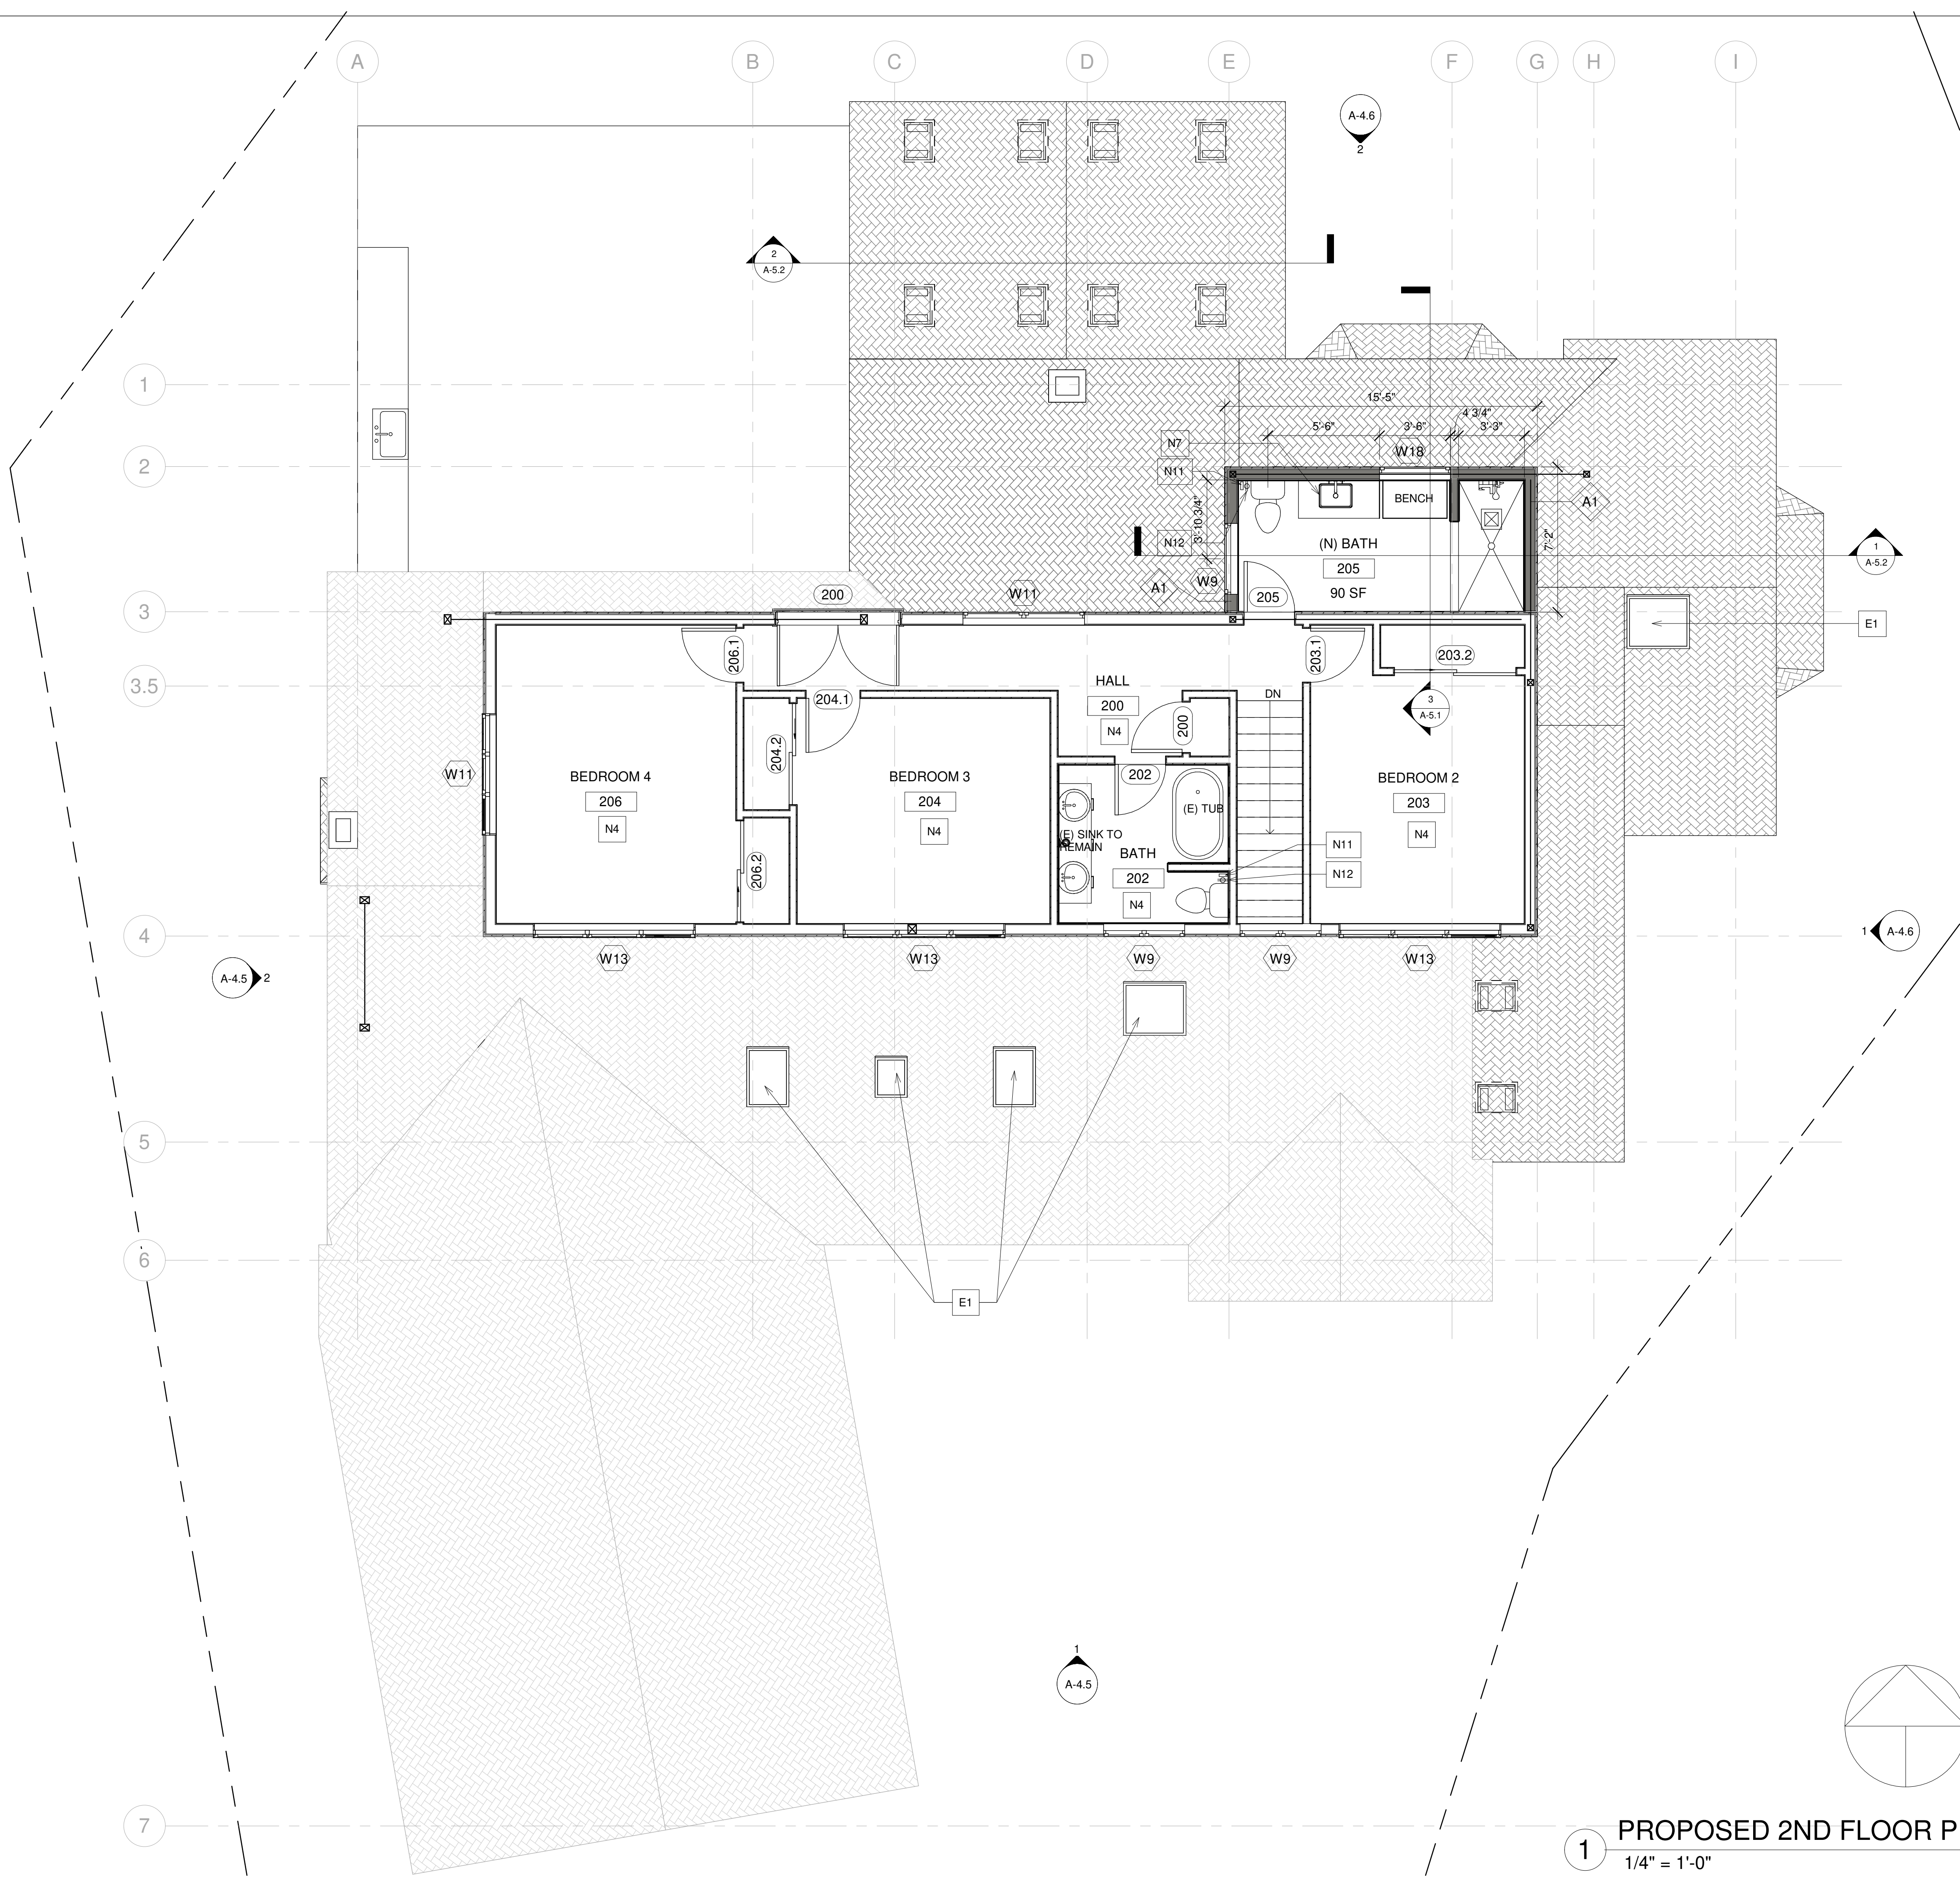
## LEGEND



- A1** 7/8" PLASTER  
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0/ SHEATHING  
0/ 2X6 WOOD STUD  
0/ GYP ON INTERIOR SIDE
- A2** 5/8" GYPSUM BOARD  
0/ 2X4 WOOD STUD  
5/8" GYPSUM BOARD
- SD** E EXISTING SMOKE DETECTOR TO REMAIN

## KEY NOTE

### KEY NOTE

- N1** ADD GAS TO EXISTING FIRE PLACE
- N2** REFURBISH EXISTING FIRE PLACE INTO 2 SIDED FIRE PLACE
- N3** OUTDOOR BBQ
- N4** NEW FLOORING
- N5** REMOVE FLAT CEILING
- N6** PROVIDE SKYLIGHT
- N7** FLOATING SINK WITH VANITY
- N8** NEW TUB
- N9** NEW WATER CLOSET
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- N12** GFCI OUTLET
- N13** REFURBISH EXISTING WALL, PREP FOR NEW SHEAR WALL PER STRUCTURAL
- N14** 18" X 24" ROOF VENT 72 SQ.INCH EACH
- E1** EXISTING SKYLIGHT TO REMAIN

## LEGEND

-  FIXTURE TAG REFER TO A8.9 & A8.10
-  FINISH TAG REFER TO A8.9

DESIGN EVEREST  
CONSULTING ENGINEERS




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A-3.2





1 PROPOSED ROOF PLAN  
1/4" = 1'-0"

VENTILATION SPECIFICATIONS
1. PROVIDE ATTIC VENTILATION, ETC., IN ACCORDANCE WITH THE 2019 CRC.
<b>ATTIC SPACES:</b> R806.2: MINIMUM AREA. THE TOTAL NET FREE VENTILATING AREA SHALL NOT BE LESS THAN 1/150 OF THE AREA OF THE SPACE VENTILATED EXCEPT THAT REDUCTION OF THE TOTAL AREA TO 1/300 IS PERMITTED PROVIDED THAT AT LEAST 50 PERCENT AND NOT MORE THAN 80 PERCENT OF THE REQUIRED VENTILATING AREA IS PROVIDED BY VENTILATORS LOCATED IN THE UPPER PORTION OF THE SPACE TO BE VENTILATED AT LEAST 3 FEET (914 MM) ABOVE THE EAVE OR CORNICE VENTS WITH THE BALANCE OF THE REQUIRED VENTILATION PROVIDED BY EAVE OR CORNICE VENTS. AS AN ALTERNATIVE, THE NET FREE CROSS-VENTILATION AREA MAY BE REDUCED TO 1/300 WHEN A CLASS I OR II VAPOR BARRIER IS INSTALLED ON THE WARM-IN-WINTER SIDE OF THE CEILING.
R806.3: VENT AND INSULATION CLEARANCE. WHERE EAVE OR CORNICE VENTS ARE INSTALLED, INSULATION SHALL NOT BLOCK THE FREE FLOW OF AIR. A MINIMUM OF A 1/2 INCH (25 MM) SPACE SHALL BE PROVIDED BETWEEN THE INSULATION AND THE ROOF SHEATHING AND AT THE LOCATION OF THE VENT.
<b>OPENINGS INTO ATTIC:</b> EXTERIOR OPENINGS INTO THE ATTIC SPACE OF ANY BUILDING INTENDED FOR HUMAN OCCUPANCY SHALL BE COVERED WITH CORROSION-RESISTANT WIRE CLOTH SCREENING, HARDWARE CLOTH, PERFORATED VINYL OR SIMILAR MATERIAL THAT WILL PREVENT THE ENTRY OF BIRDS, SQUIRRELS, RODENTS, SNAKES AND OTHER SIMILAR CREATURES. THE OPENINGS THEREIN SHALL BE A MINIMUM OF 1/16 INCH AND NOT EXCEED 1/4 INCH. OPENINGS FOR VENTILATION HAVING A LEAST DIMENSION LARGER THAN 1/4 INCH SHALL BE PROVIDED WITH CORROSION-RESISTANT WIRE CLOTH SCREENING, HARDWARE CLOTH, PERFORATED VINYL OR SIMILAR MATERIAL WITH OPENINGS HAVING A LEAST DIMENSION OF 1/16 INCH (1.6 MM) MINIMUM AND 1/4 INCH MAXIMUM WHERE COMBUSTION AIR IS OBTAINED FROM AN ATTIC AREA, IT SHALL BE IN ACCORDANCE WITH CHAPTER 7 OF THE CALIFORNIA MECHANICAL CODE.

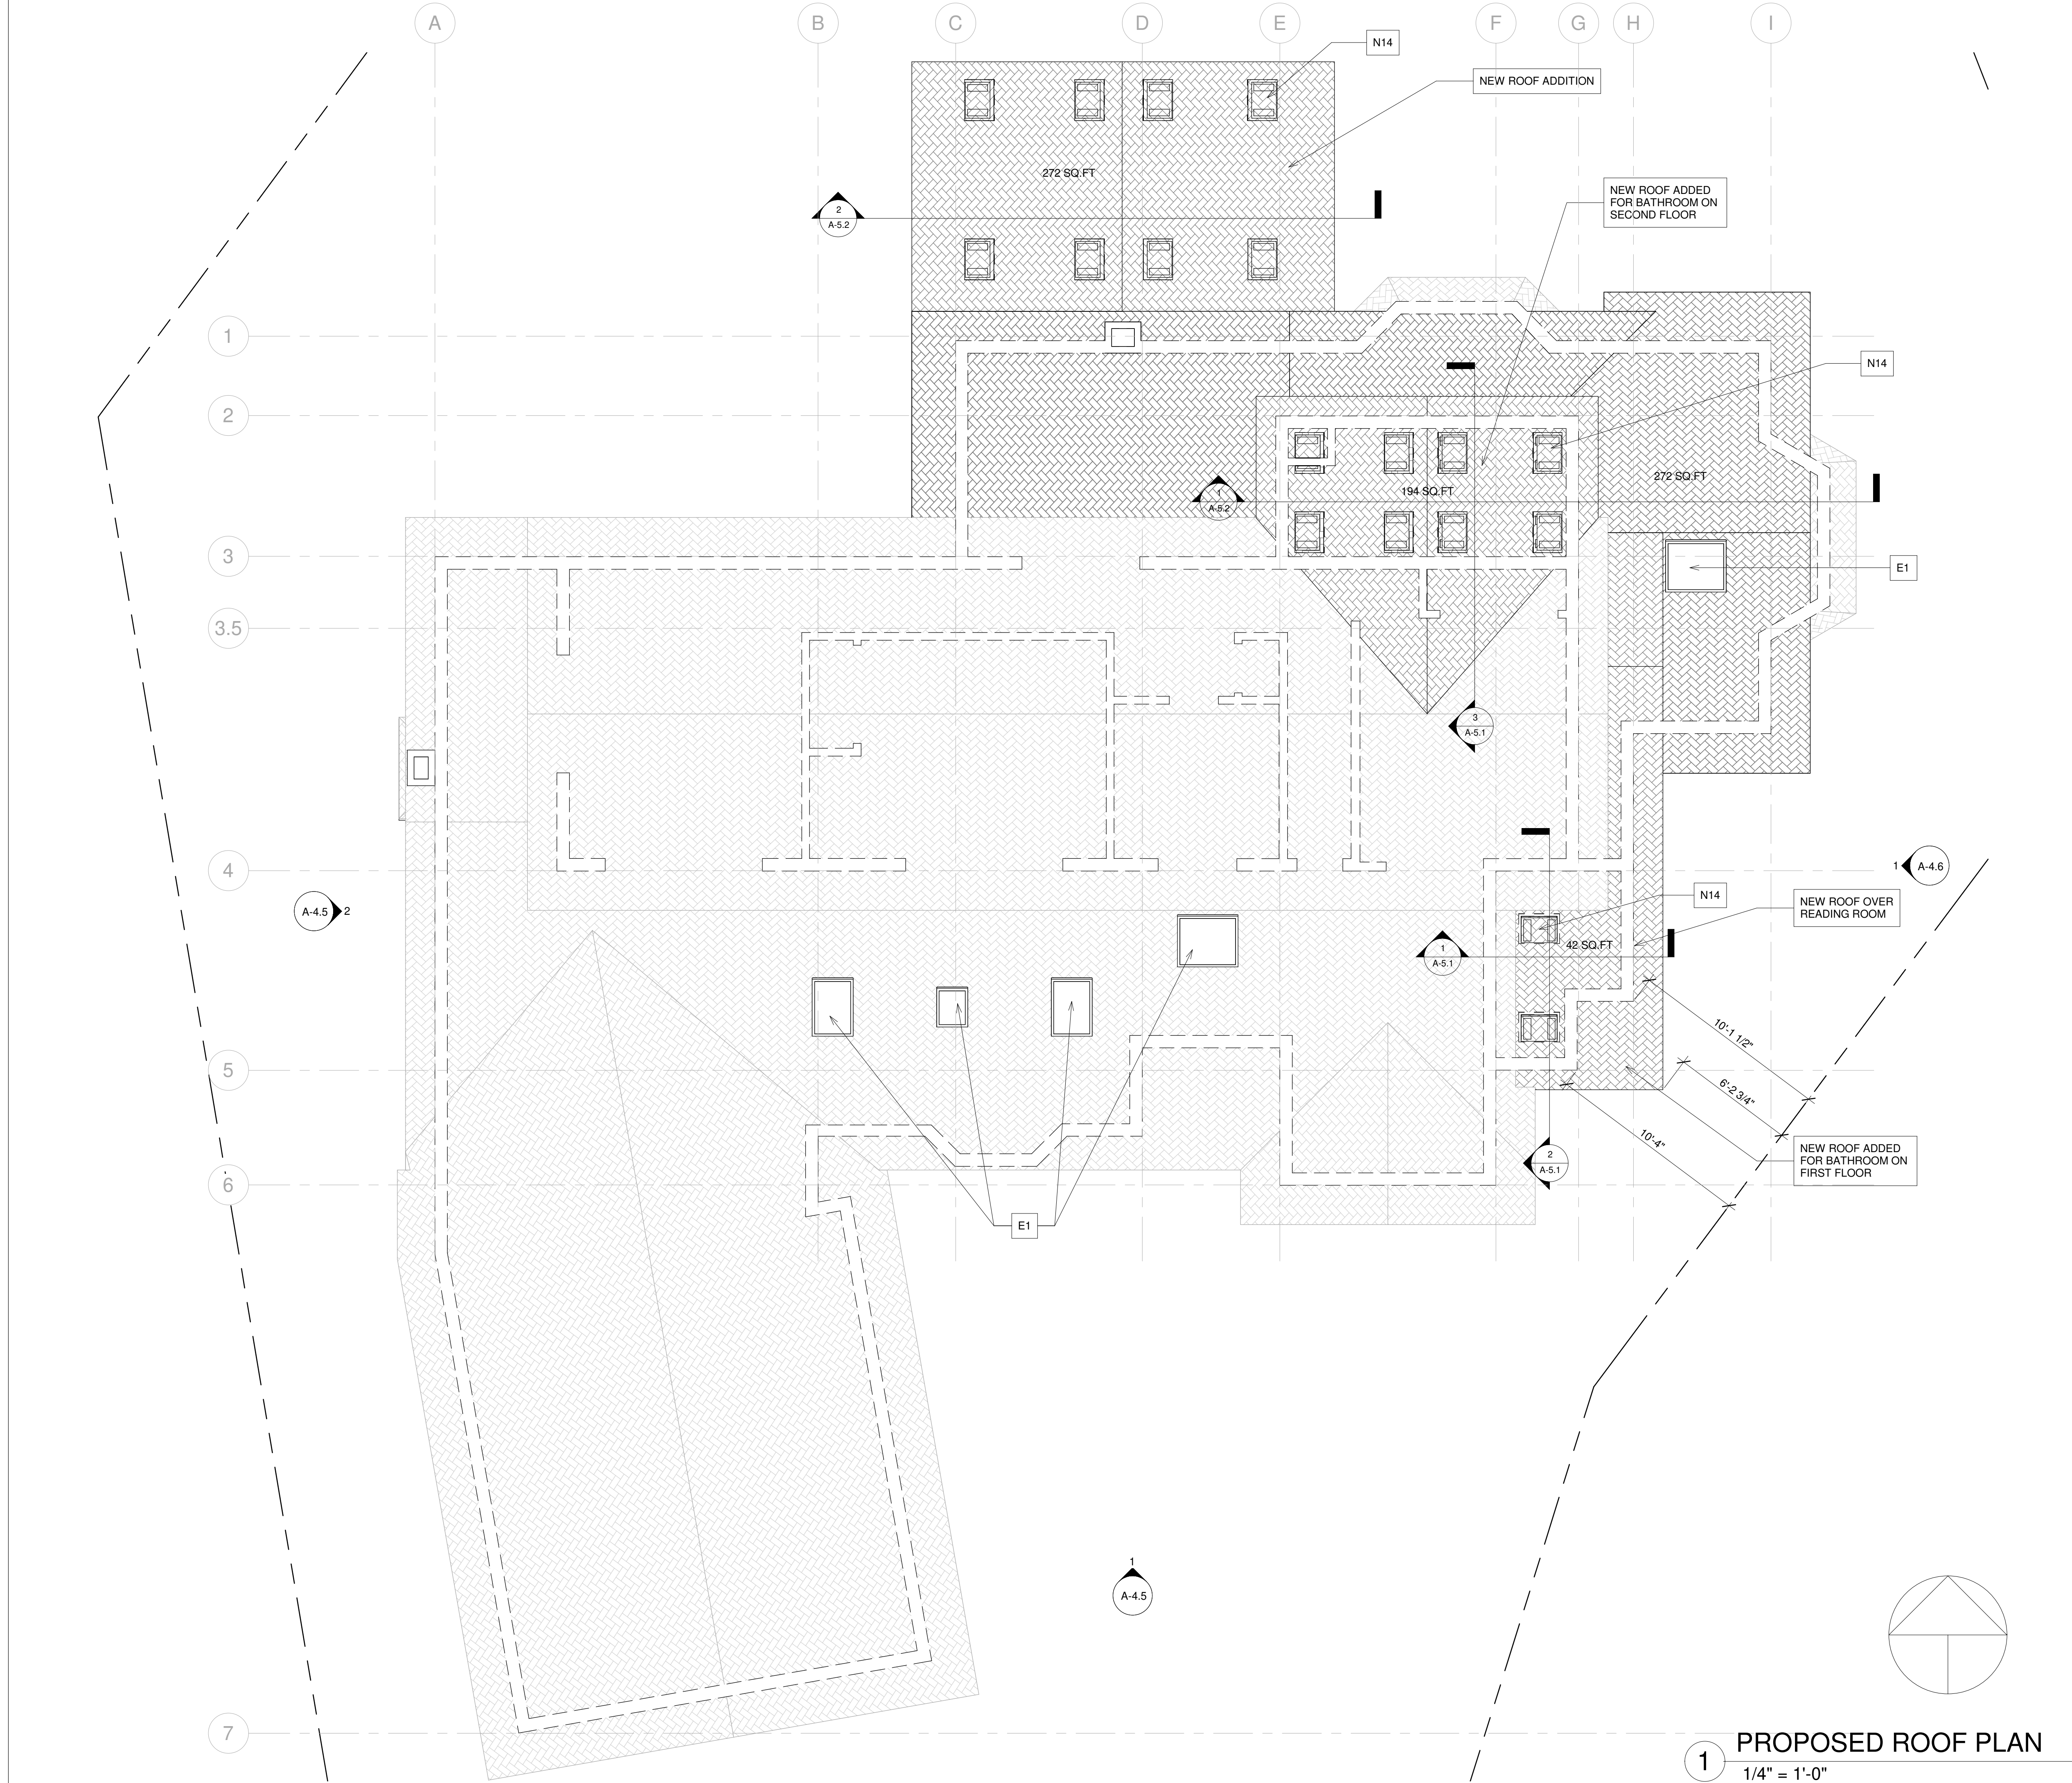ROOF SPECIFICATION
STEEP SLOPE ROOF COVERING:
1. COMPOSITION SHINGLE ROOF MATERIAL BY GAF-ELK OR APPROVED EQUAL ICC-ES REPORT RESR-1475 @ ENTIRE RESIDENCE - MATCH (E) COLOR
2. ROOF VENTS:
1. O'HAGINS LOW PROFILE (TAPERED) PRE-PAINTED GALVANIZED FINISH WITH SHINGLE OVER, REFER TO 6.8 /A8.2
2. PROVIDE INSULATION BAFFLES @ ROOF / WALL INTERSECTIONS WHERE VENTS OCCUR.

## KEY NOTE

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N1	ADD GAS TO EXISTING FIRE PLACE
N2	REFURBISH EXISTING FIRE PLACE INTO 2 SIDED FIRE PLACE
N3	OUTDOOR BBQ
N4	NEW FLOORING
N5	REMOVE FLAT CEILING
N6	PROVIDE SKYLIGHT
N7	FLOATING SINK WITH VANITY
N8	NEW TUB
N9	NEW WATER CLOSET
N10	NEW SINK
N11	NEW BIDET
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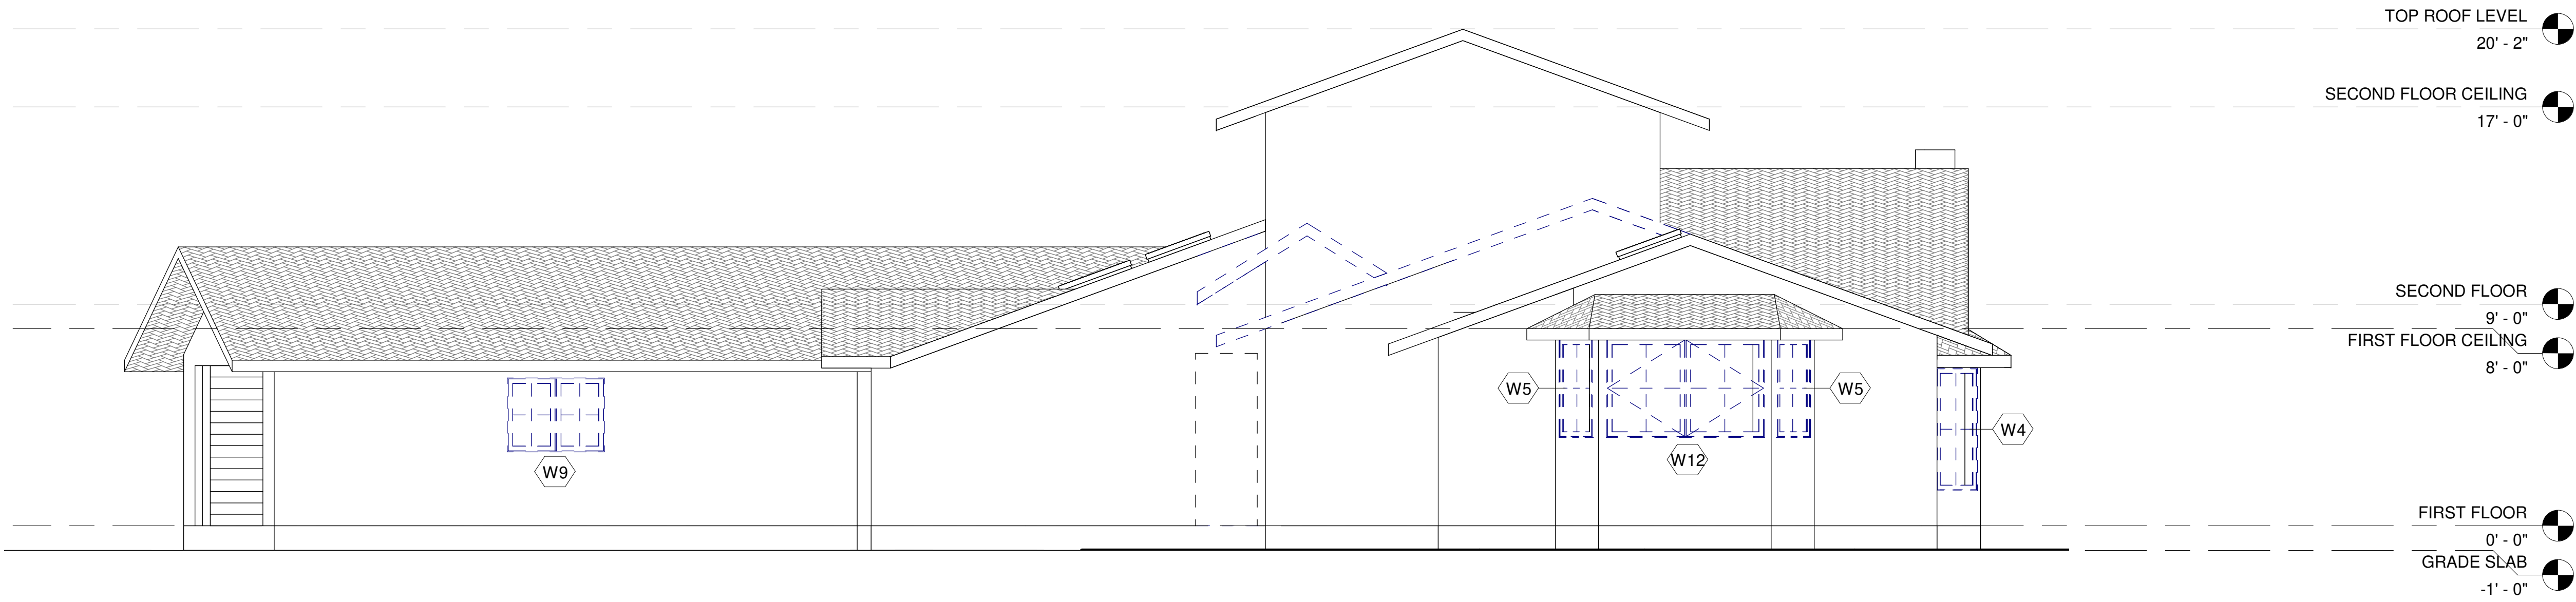
**DESIGN EVEREST**  
CONSULTING ENGINEERS

PROPOSED ROOF PLAN


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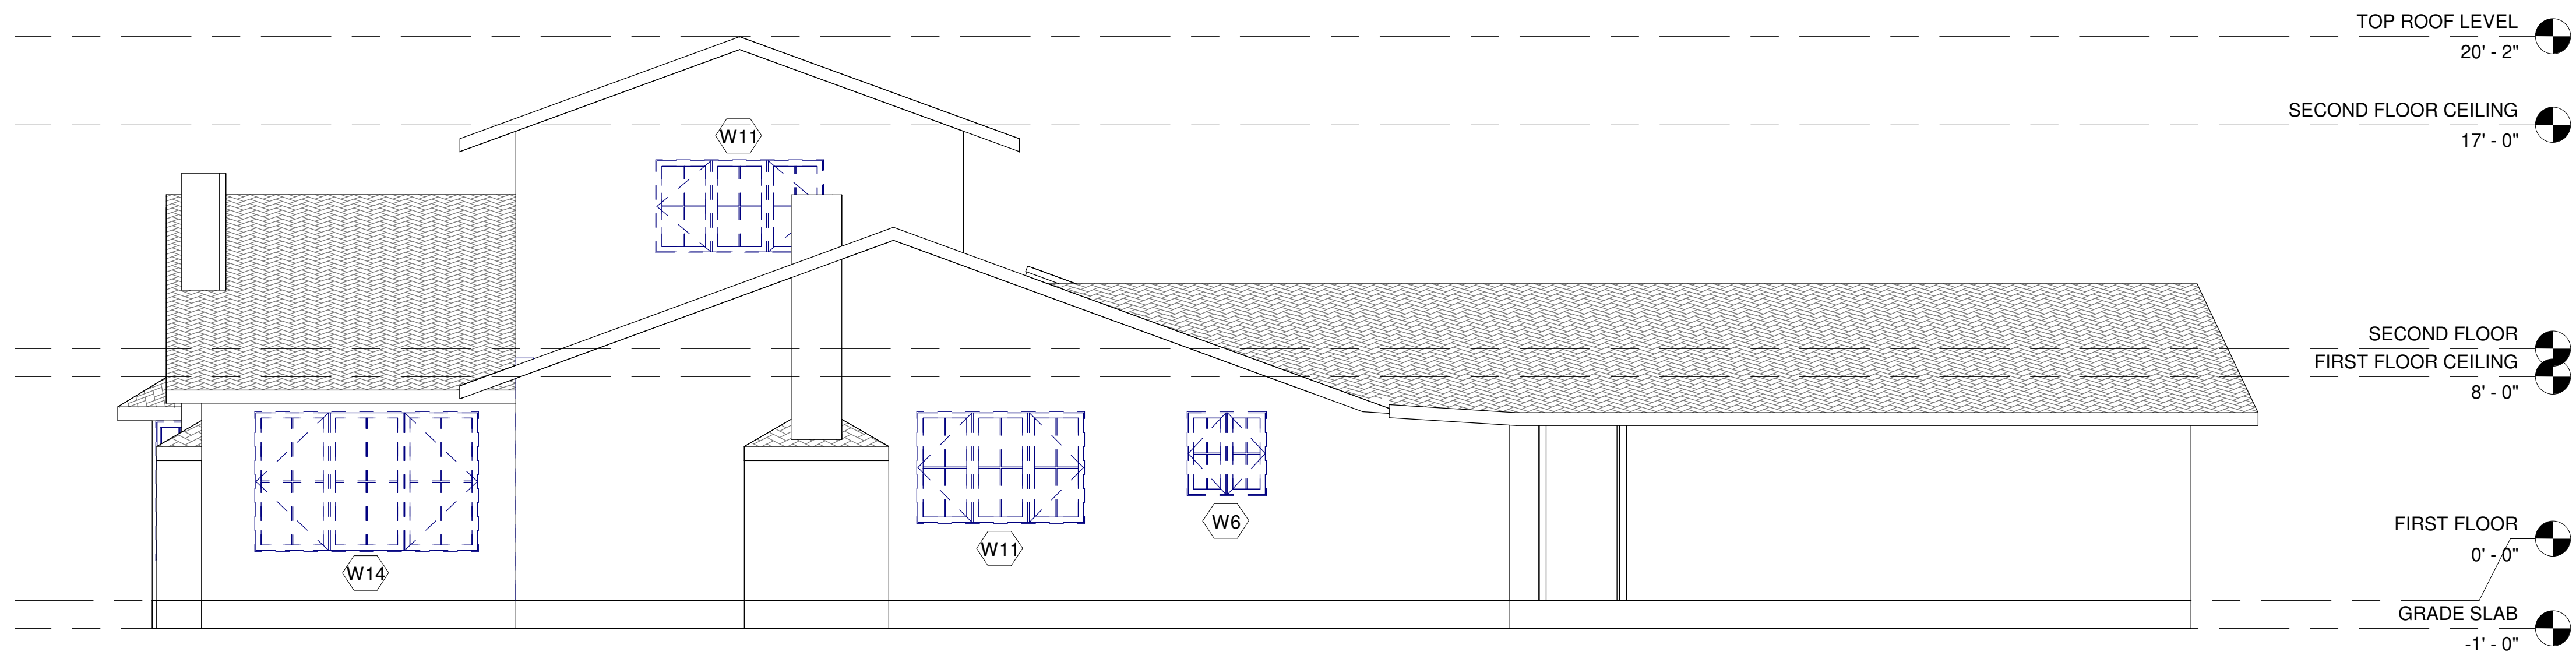


1 EXISTING EAST SIDE ELEVATION  
1/4" = 1'-0"




2 PROPOSED EAST SIDE ELEVATION  
1/4" = 1'-0"



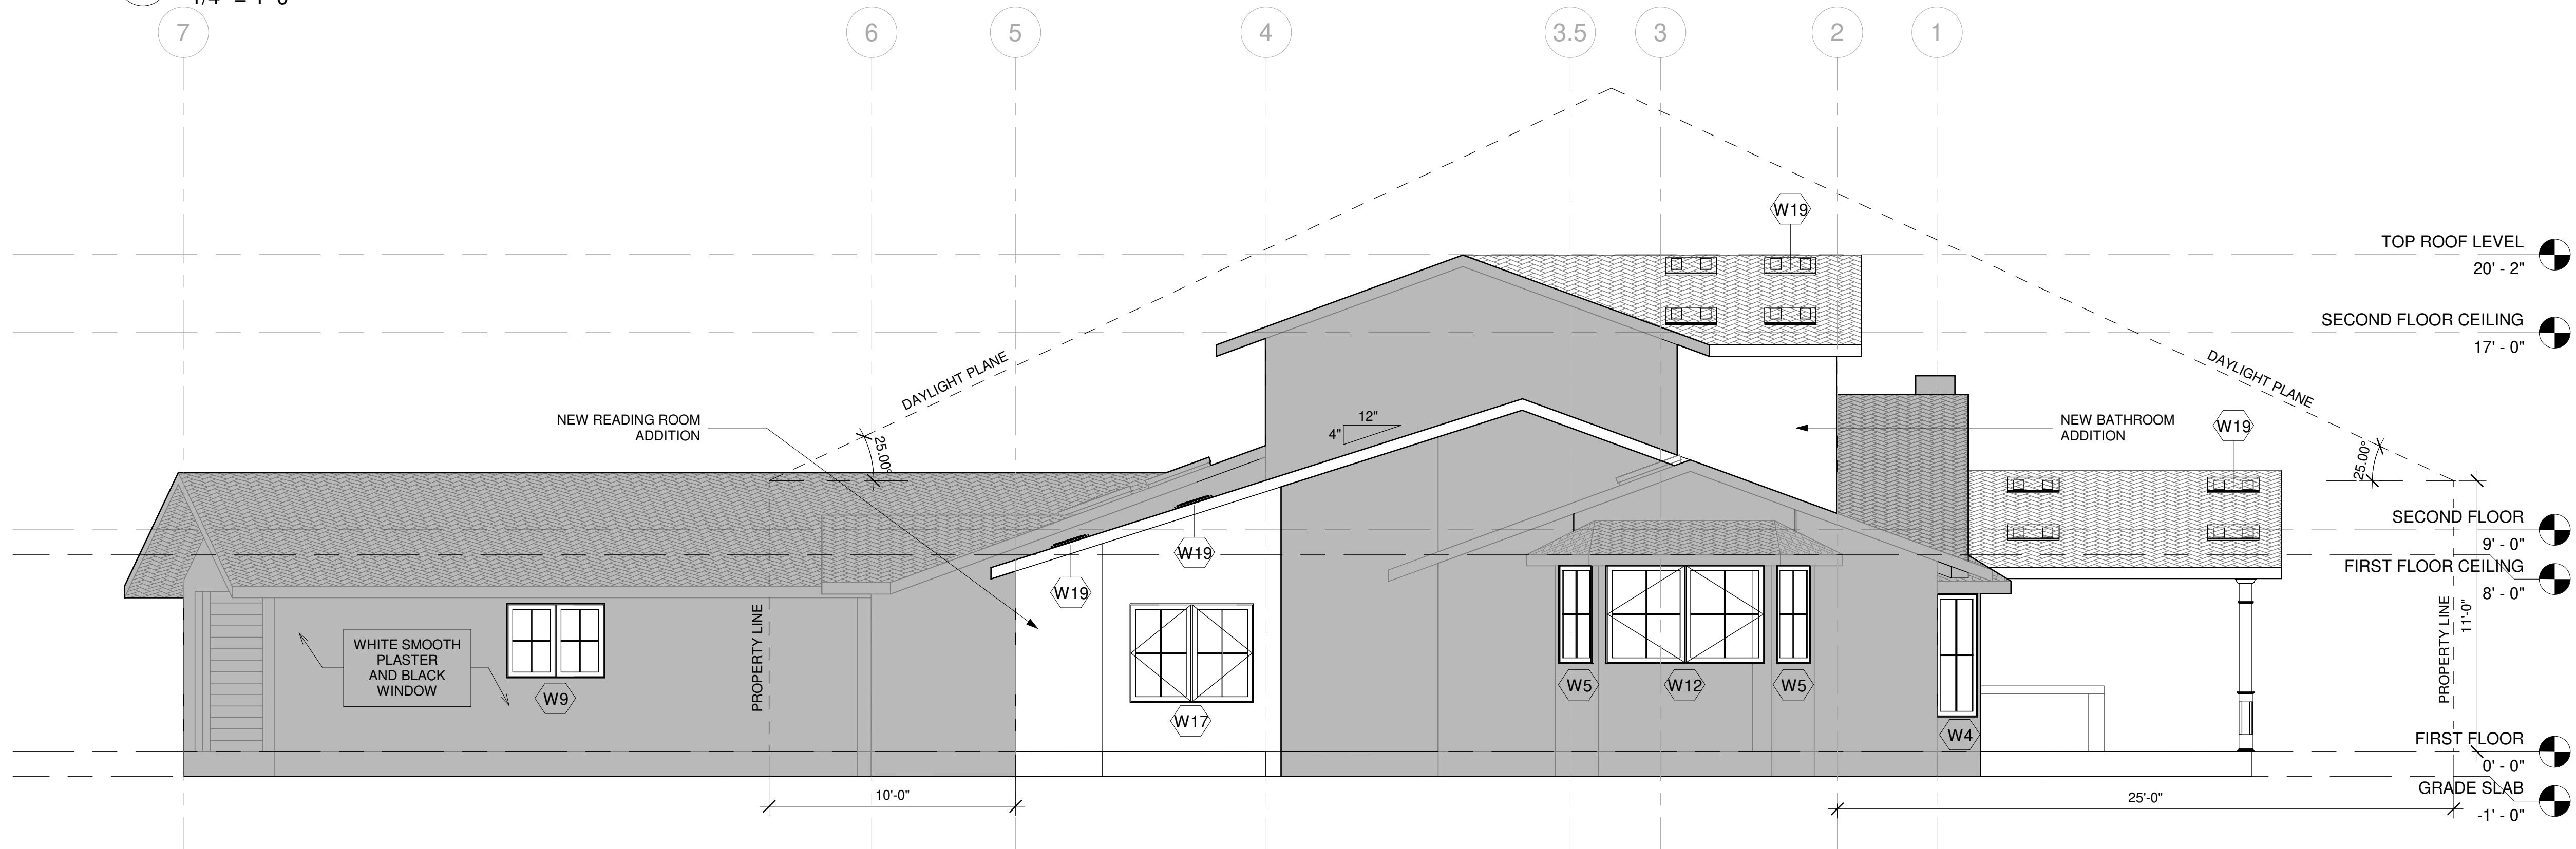

1 EXISTING SIDE WEST ELEVATION  
1/4" = 1'-0"

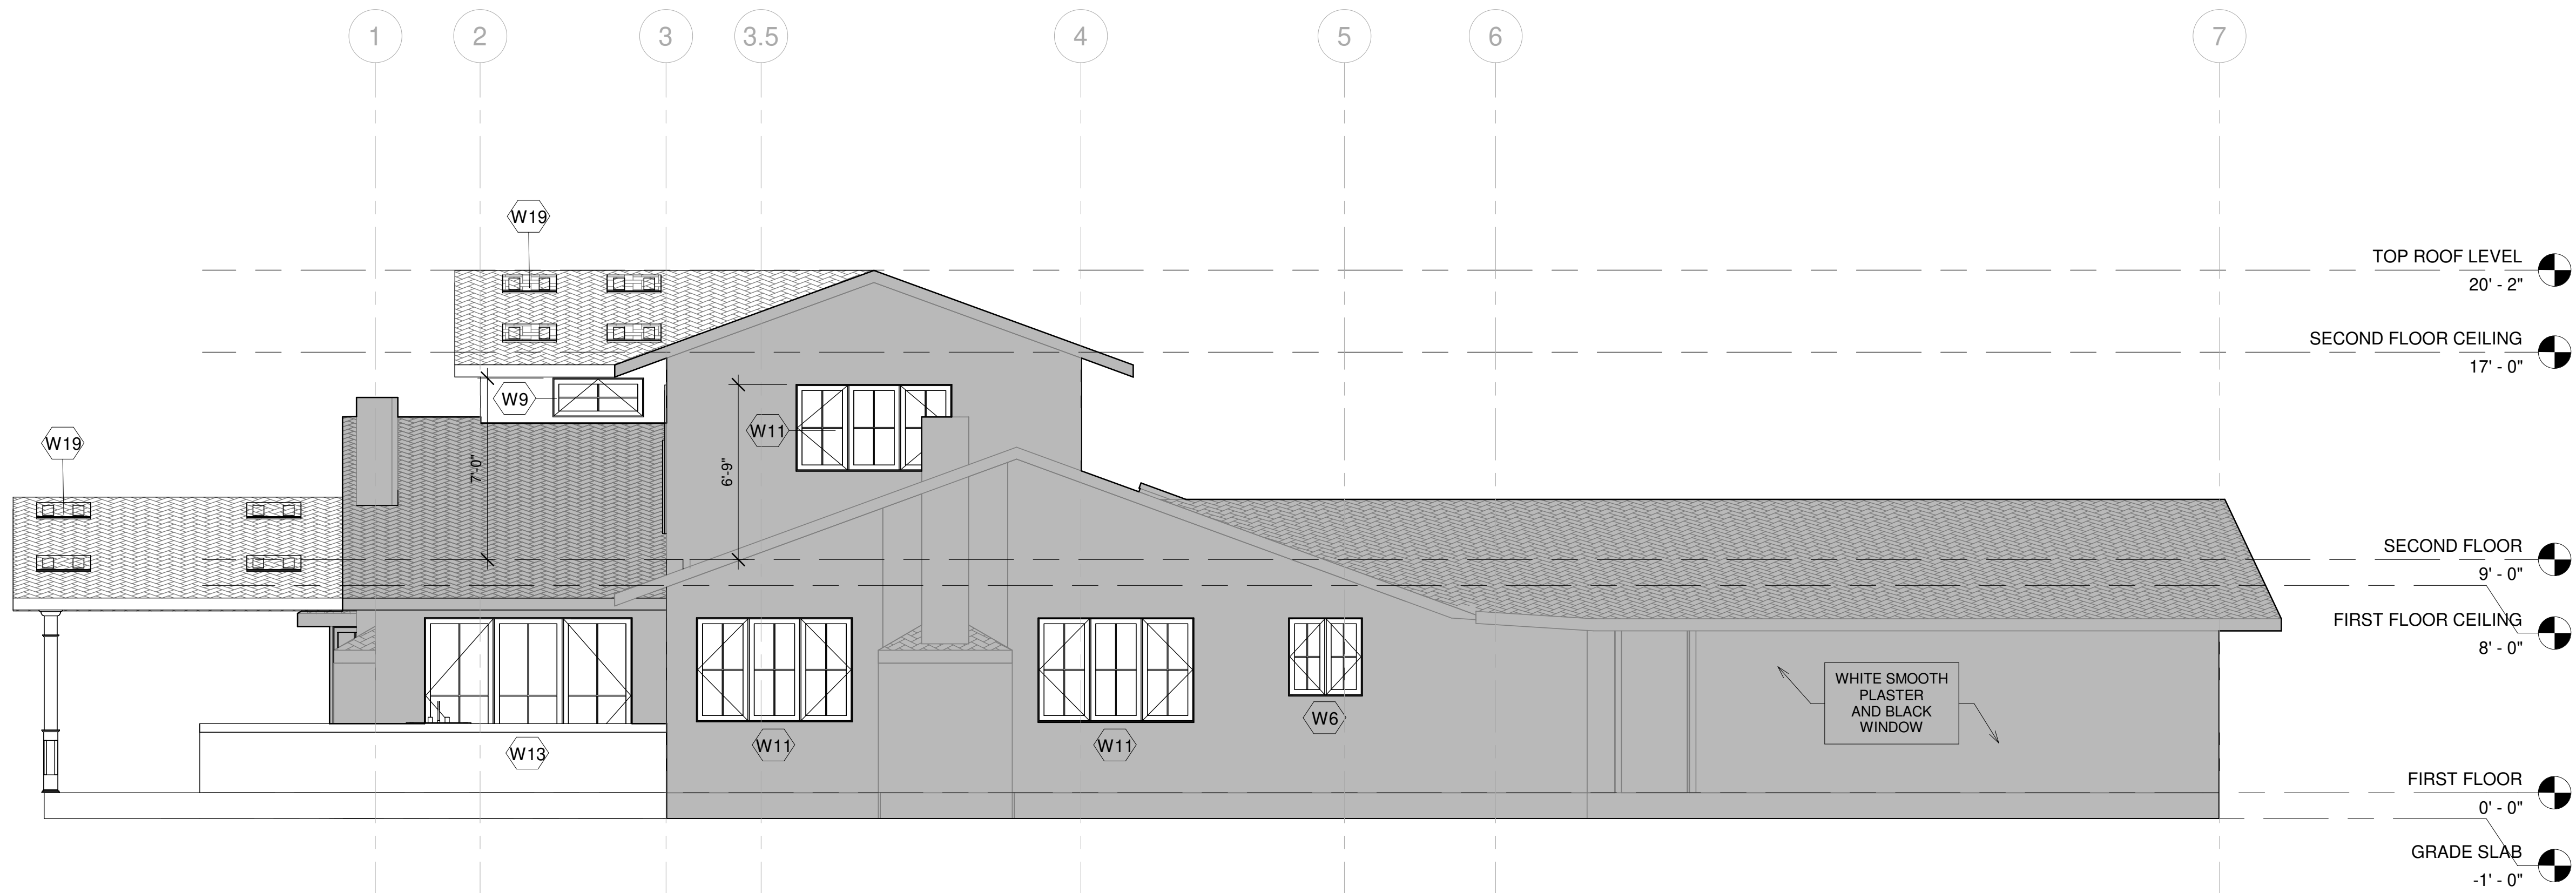


2 PROPOSED SIDE WEST ELEVATION  
1/4" = 1'-0"








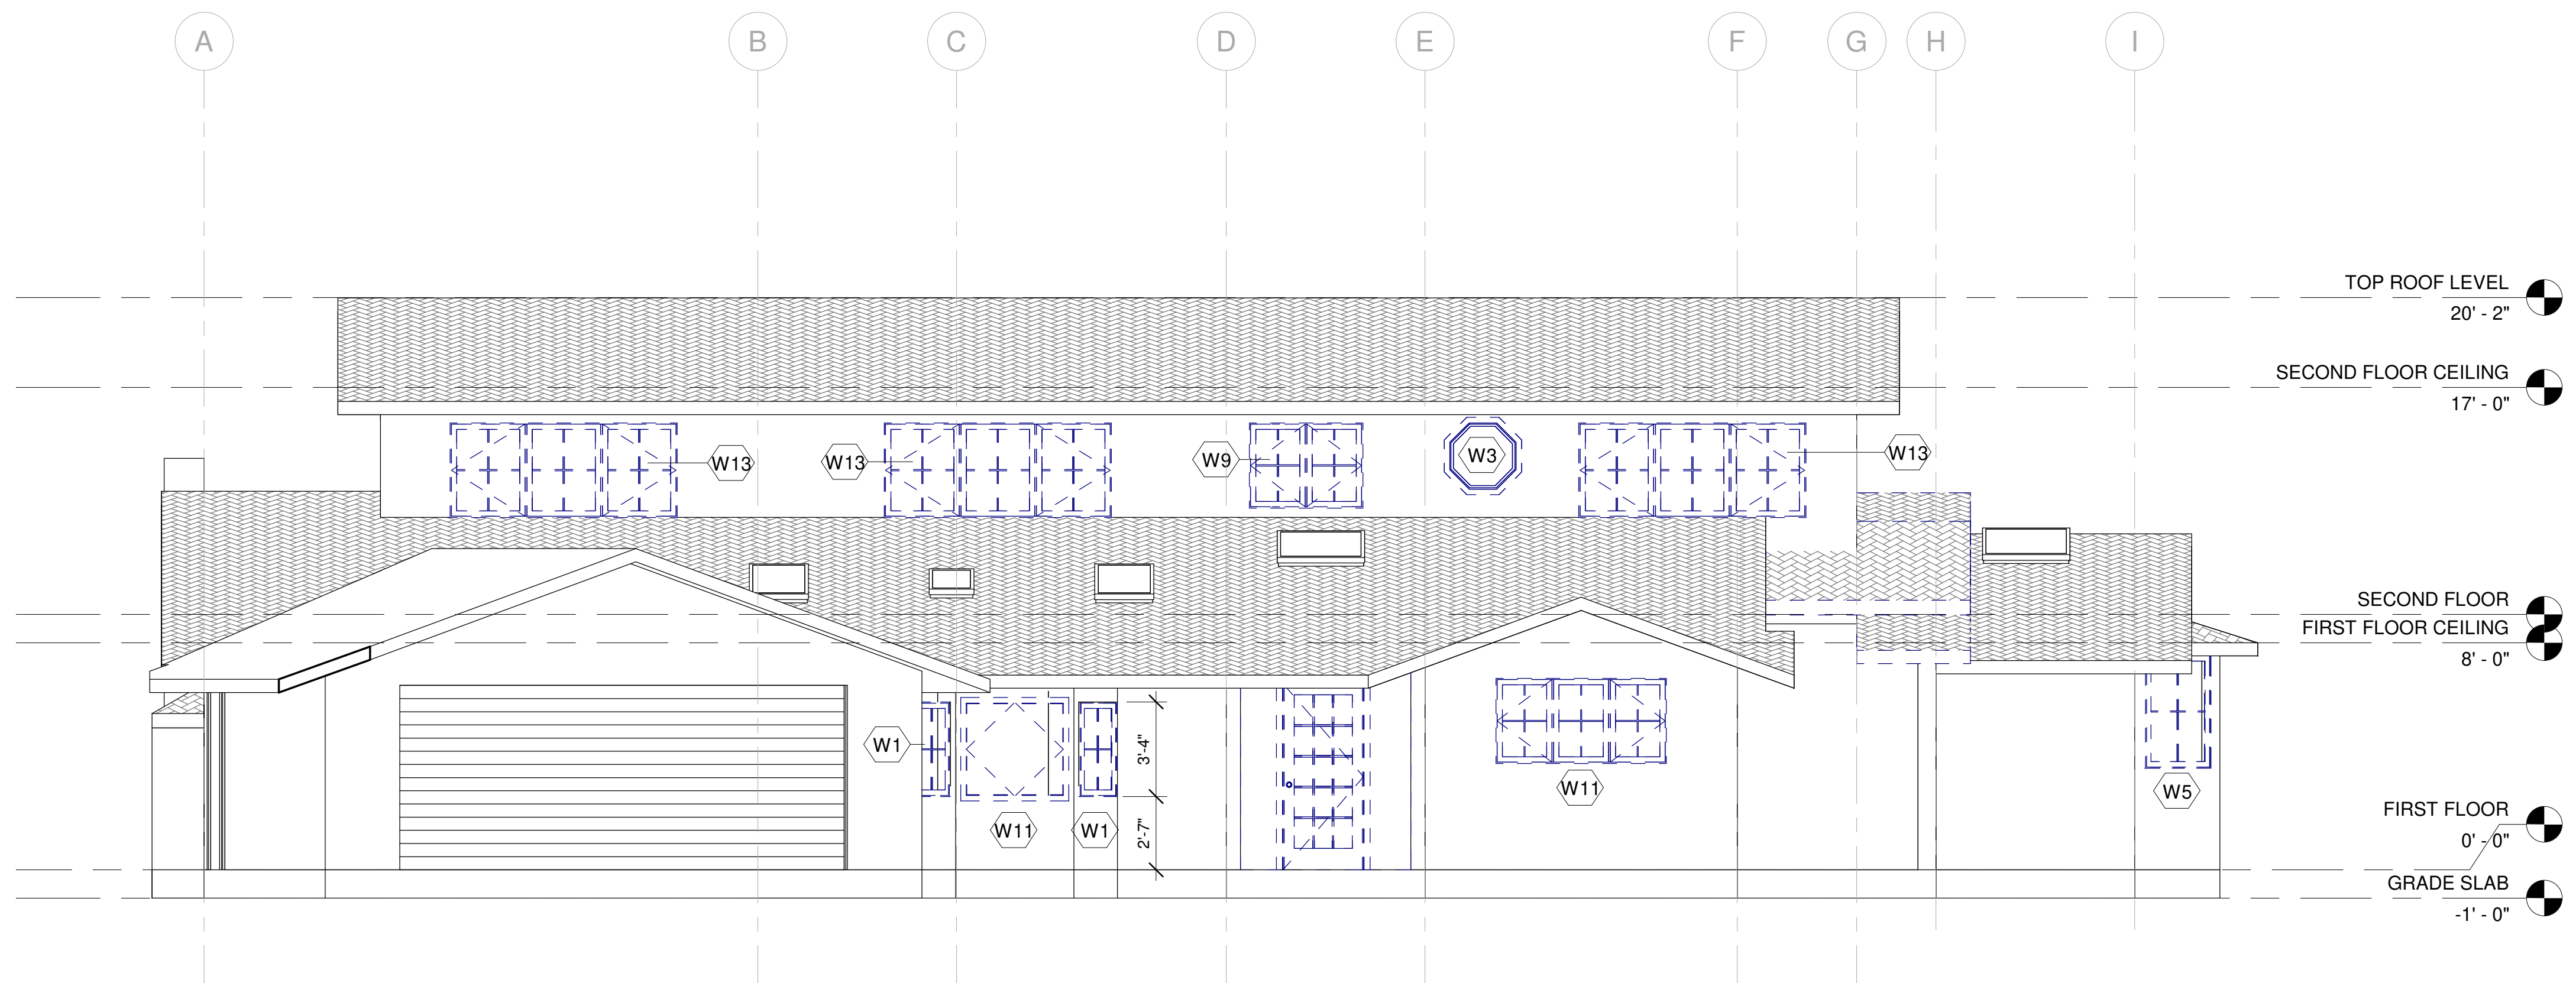

1 EXISTING SOUTH FRONT ELEVATION  
1/4" = 1'-0"

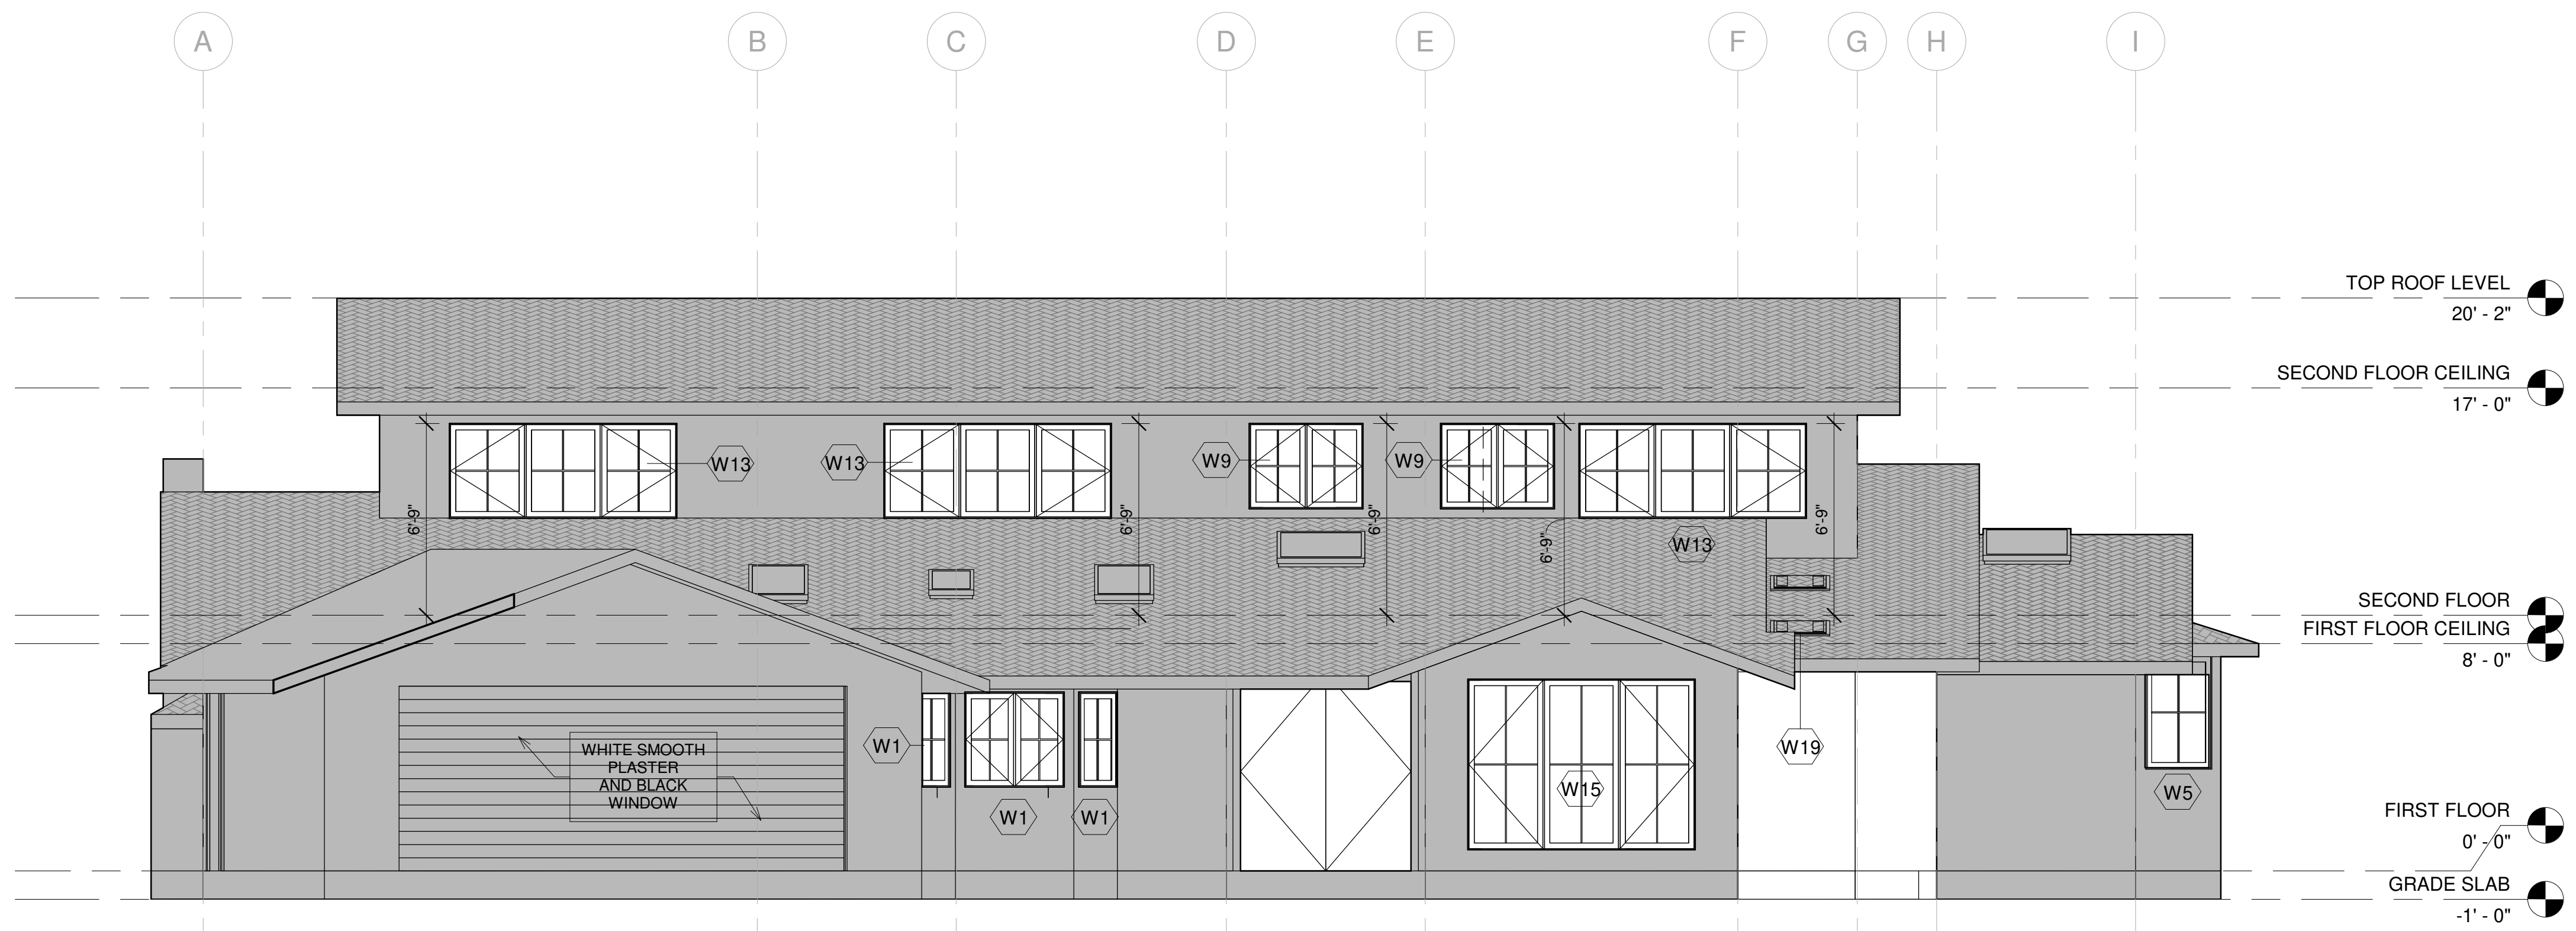


2 PROPOSED SOUTH FRONT ELEVATION  
1/4" = 1'-0"






1 SOUTH FRONT ELEVATION  
1/4" = 1'-0"

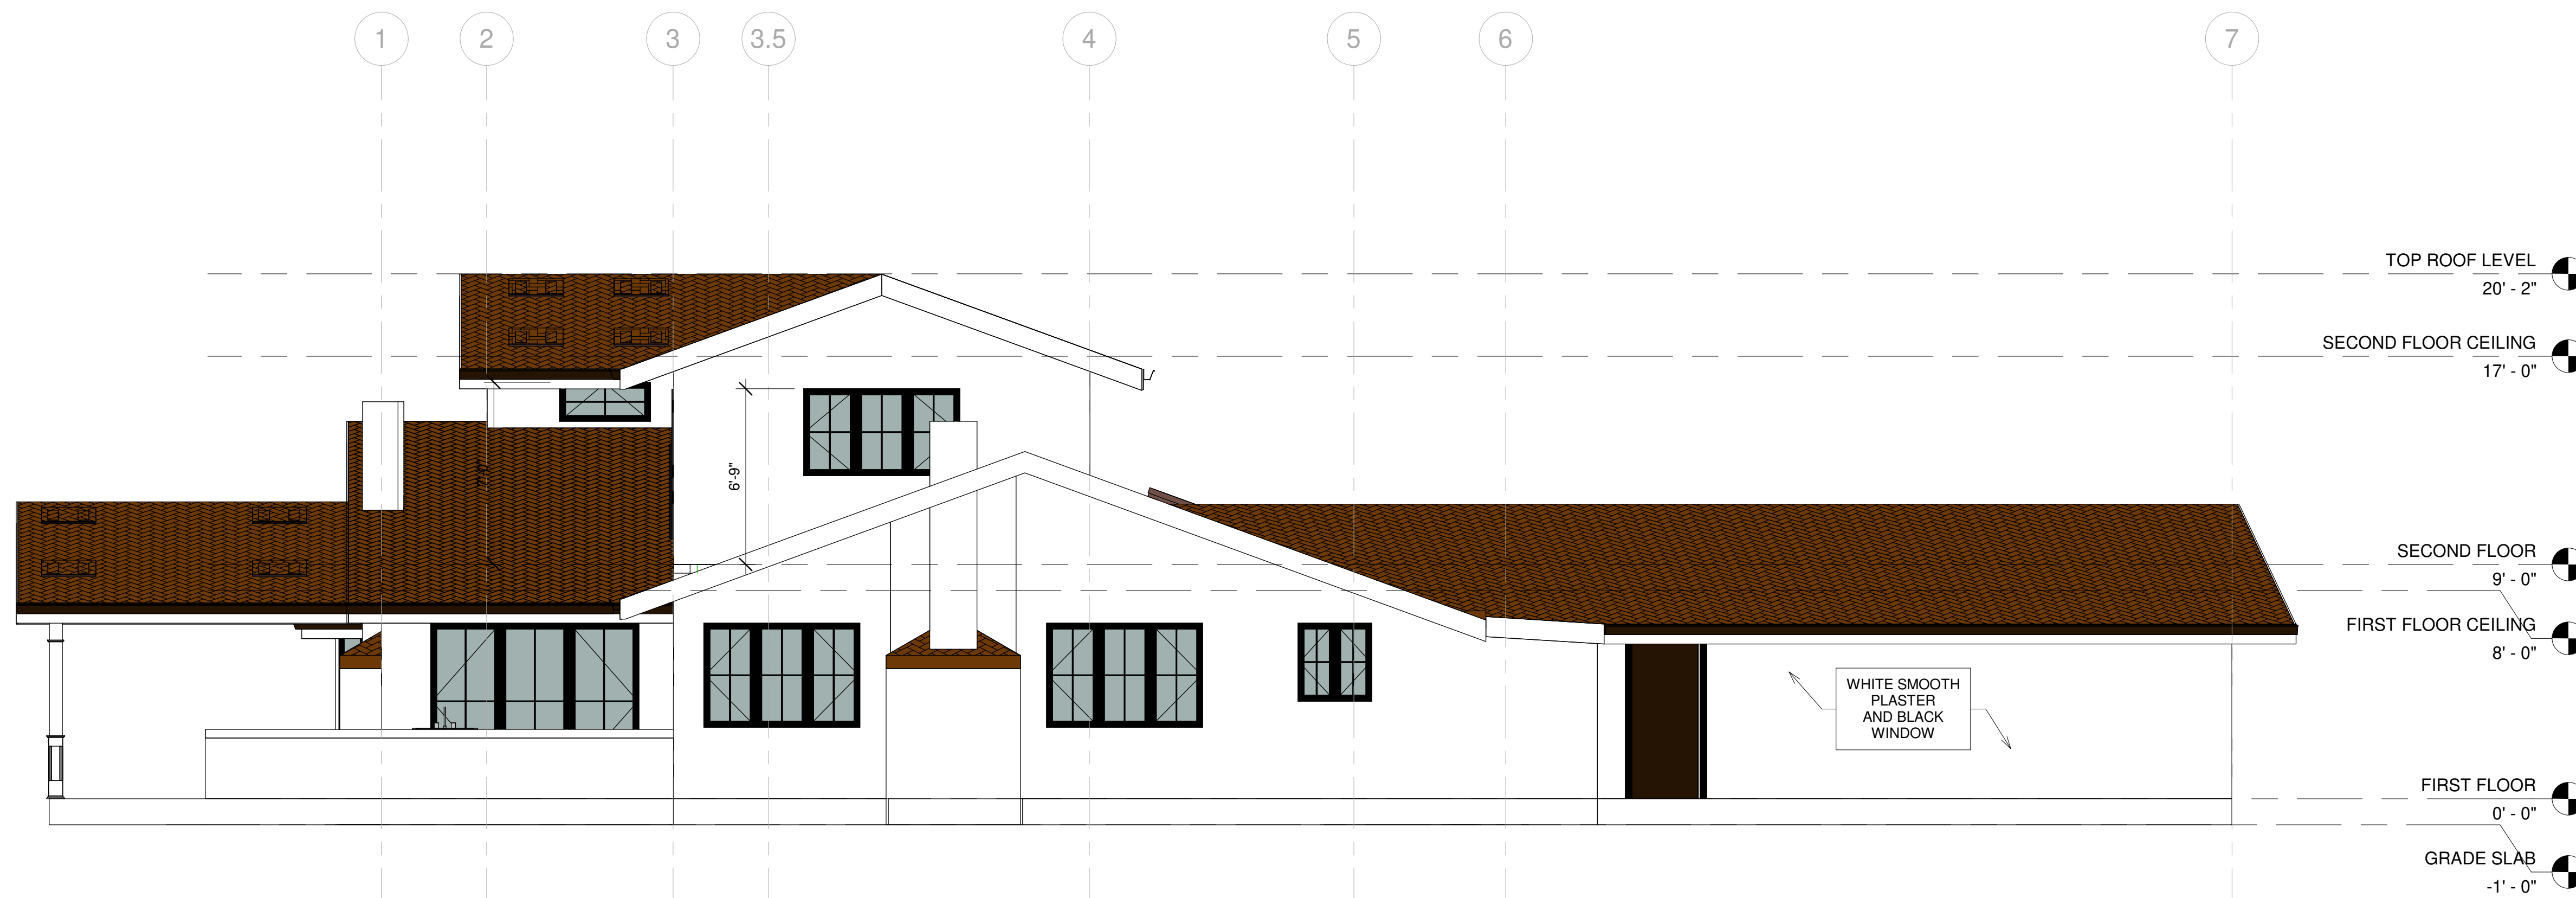

2 WEST ELEVATION  
1/4" = 1'-0"

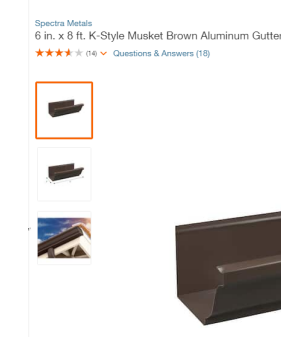


GUTTER  
MANUFACTURE: SPECTRA  
STYLE: K-STYLE MUSKET BROWN ALUMINUM  
GUTTER


No.	DATE:	DELTA DESCRIPTION:
1	22/09/17	CITY SUBMITTAL
2		
3		
4		
5		

DATE:	22/09/17
SCALE:	1/4" = 1'-0"
DRAWN BY :	
CKD BY:	
PROJECT :	202107199




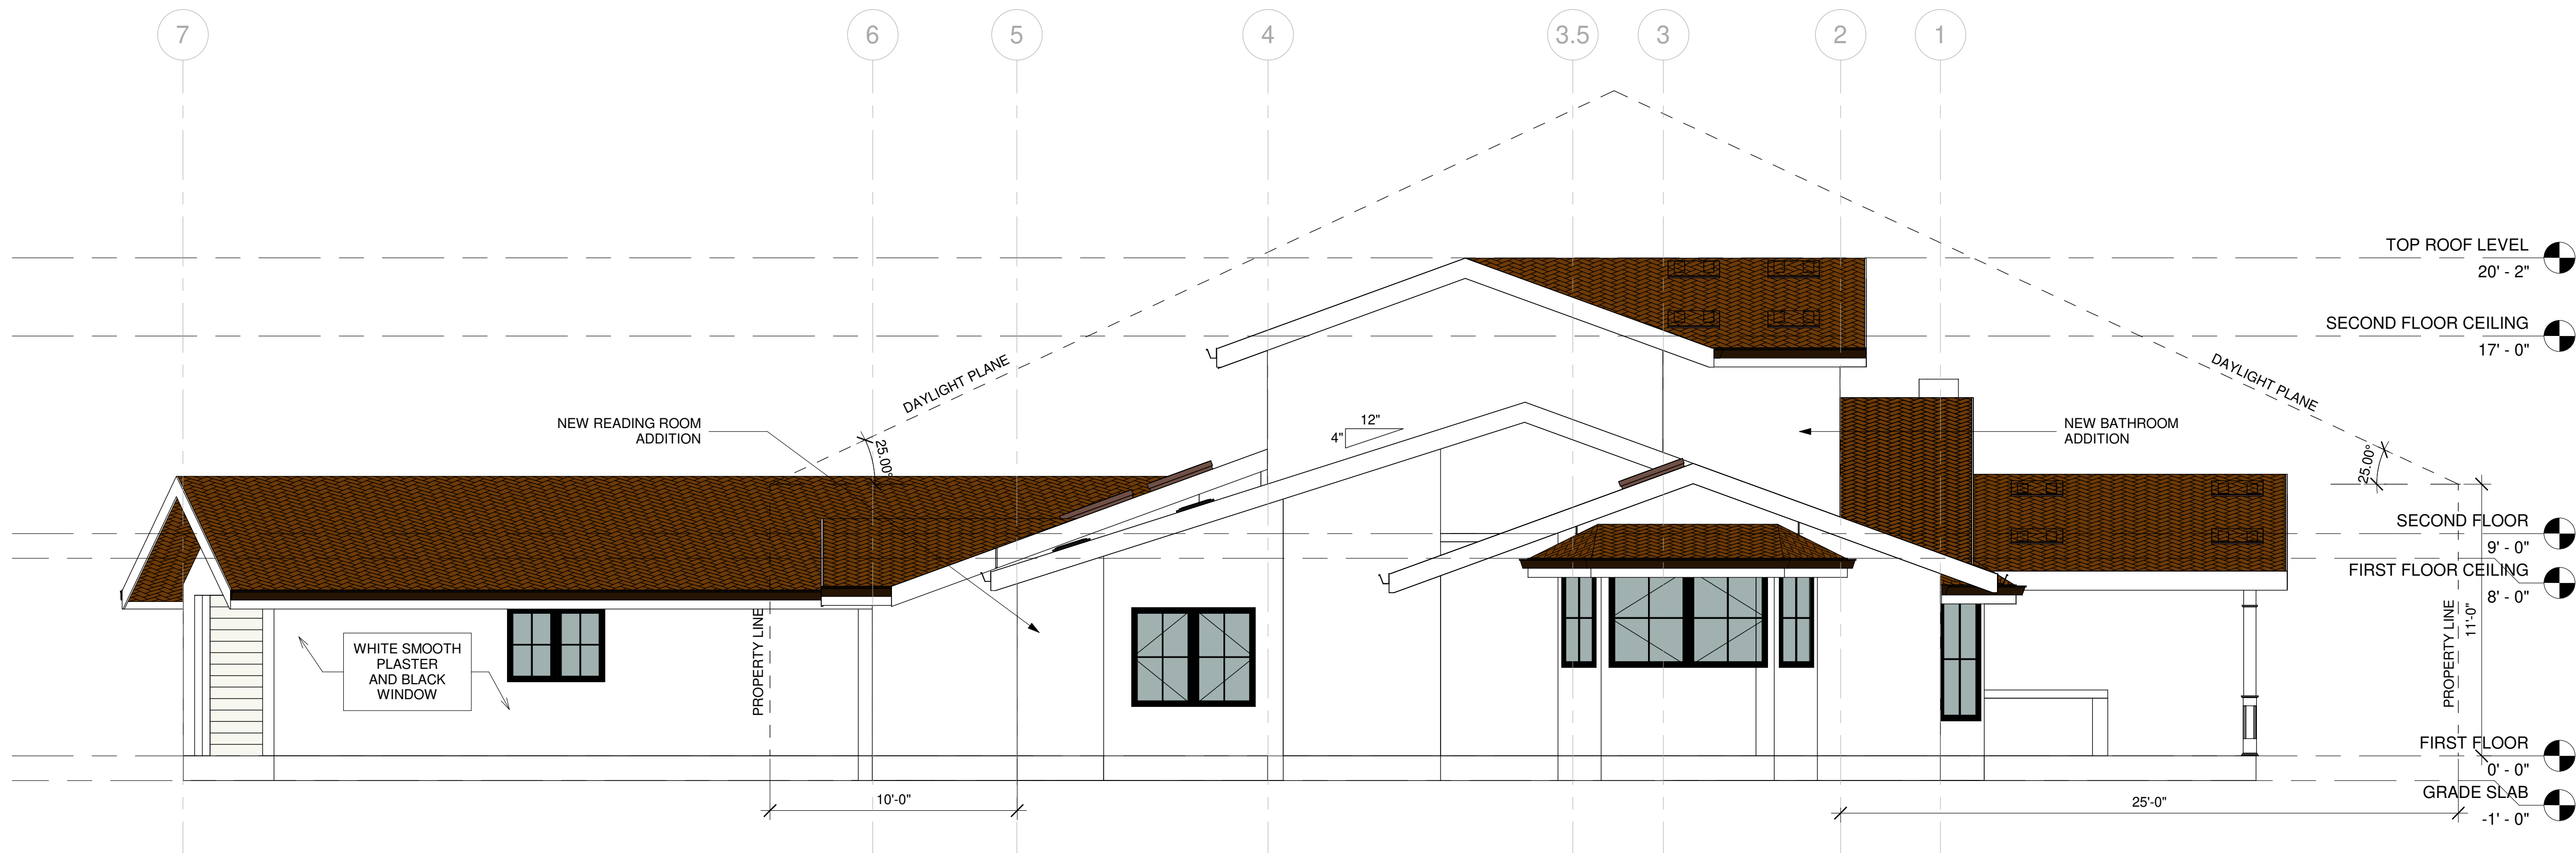

1 EAST SIDE ELEVATION  
1/4" = 1'-0"

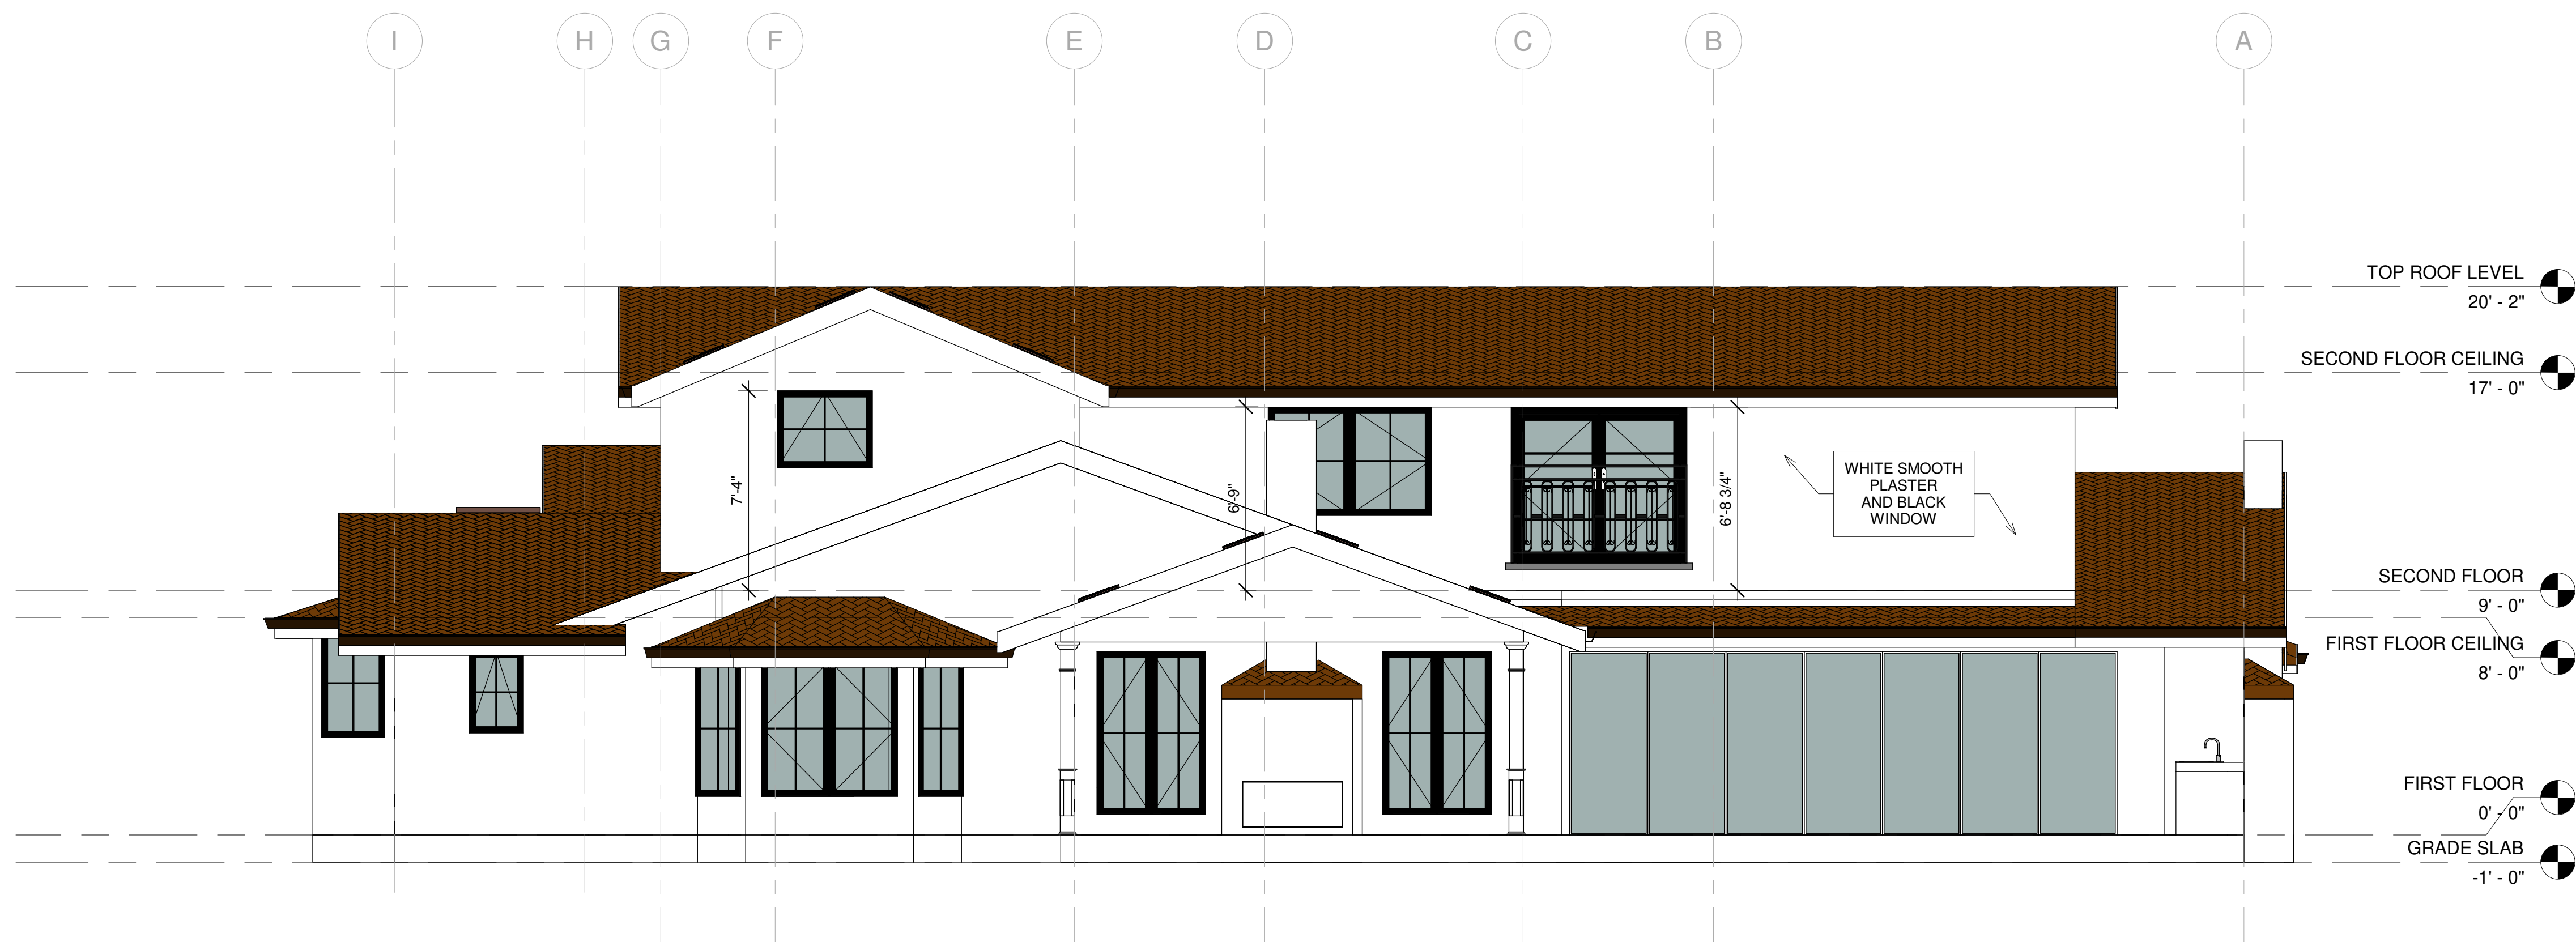

2 NORTH ELEVATION  
1/4" = 1'-0"

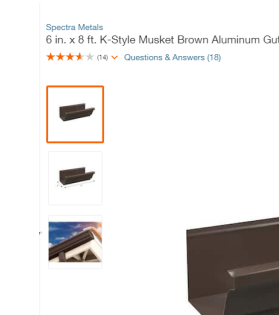

No.	DATE:	DELTA DESCRIPTION:
1	22/09/17	CITY SUBMITTAL
2		
3		
4		
5		

DATE:	22/09/17
SCALE:	1/4" = 1'-0"
DRAWN BY :	
CKD BY:	
PROJECT :	202107199




DOOR SCHEDULE										
WT	LOCATION(S)	Width	Sill Height	Head Height	Thickness	Frame Finish	Door Finish	Frame Material	Door Material	Level
109	OFFICE	2' - 8"	-0' - 6"	7' - 0"	0' - 2"	PT	PT	WOOD	WOOD	FIRST FLOOR
113	DRESSING	2' - 8"	0' - 0"	8' - 0"	0' - 2"	PT	PT	WOOD	WOOD	FIRST FLOOR
10	DRESSING	2' - 4"	0' - 0"	7' - 6"	0' - 2"	PT	PT	WOOD	WOOD	FIRST FLOOR
101.2	LAUNDRY	2' - 8"	0' - 0"	8' - 0"	0' - 2"	PT	PT	WOOD	WOOD	FIRST FLOOR
101.1	LAUNDRY	2' - 8"	0' - 0"	8' - 0"	0' - 2"	PT	PT	WOOD	WOOD	FIRST FLOOR
100.2	GARRAGE	16' - 0"	0' - 0"	6' - 6"	0' - 3"	PT	PT	METAL	METAL	FIRST FLOOR
100.1	GARRAGE	2' - 8"	0' - 0"	7' - 0"	0' - 2"	PT	PT	WOOD	WOOD	FIRST FLOOR
112.2	MA. BATH	2' - 4"	0' - 0"	8' - 0"	0' - 2"	PT	PT	WOOD	WOOD	FIRST FLOOR
102	BATH	2' - 4"	0' - 0"	8' - 0"	0' - 2"	PT	PT	WOOD	WOOD	FIRST FLOOR
114	(N) READING	2' - 6"	0' - 0"	7' - 6"	0' - 2"	PT	PT	WOOD	WOOD	FIRST FLOOR
108	ENTRY	6' - 0"	0' - 0"	7' - 0"	0' - 2"	PT	PT	WOOD	WOOD	FIRST FLOOR
110	W.I.C.	6' - 0"	0' - 0"	7' - 0"	0' - 2"	PT	PT	WOOD	WOOD	FIRST FLOOR
104	KITCHEN	2' - 4"	0' - 0"	8' - 0"	0' - 2"	PT	PT	WOOD	WOOD	FIRST FLOOR
112.1	MA. BATH	3' - 0"	0' - 0"	7' - 0"	0' - 2"	PT	PT	WOOD	WOOD	FIRST FLOOR
111	MA. BEDROOM	2' - 8"	0' - 0"	7' - 0"	0' - 2"	PT	PT	WOOD	WOOD	FIRST FLOOR
200	CLOSET	2' - 6"	0' - 0"	7' - 6"	0' - 2"	PT	PT	WOOD	WOOD	SECOND FLOOR
203.2	BEDROOM 2	6' - 0"	0' - 0"	7' - 0"	0' - 2"	PT	PT	WOOD	WOOD	SECOND FLOOR
203.1	BEDROOM 2	2' - 8"	0' - 0"	7' - 6"	0' - 2"	PT	PT	WOOD	WOOD	SECOND FLOOR
202	BATH	2' - 6"	0' - 0"	7' - 6"	0' - 2"	PT	PT	WOOD	WOOD	SECOND FLOOR
204.1	BEDROOM 3	2' - 8"	0' - 0"	7' - 6"	0' - 2"	PT	PT	WOOD	WOOD	SECOND FLOOR
206.1	BEDROOM 4	2' - 8"	0' - 0"	7' - 6"	0' - 2"	PT	PT	WOOD	WOOD	SECOND FLOOR
204.2	BEDROOM 3	5' - 0"	0' - 0"	7' - 0"	0' - 2"	PT	PT	WOOD	WOOD	SECOND FLOOR
206.2	BEDROOM 4	5' - 0"	0' - 0"	7' - 0"	0' - 2"	PT	PT	WOOD	WOOD	SECOND FLOOR
205	(N) BATH	2' - 6"	0' - 0"	7' - 6"	0' - 2"	PT	PT	WOOD	WOOD	SECOND FLOOR
200	HALL	6' - 0"	1' - 0"	6' - 6"	0' - 1 1/2"	PT	PT	WOOD	WOOD	SECOND FLOOR

SCHEDULE KEY	DOOR GENERAL NOTES	DOOR ABBREVIATIONS			
1. MEET EGRESS REQUIREMENT. 2.OBSCURED GLASS REQUIREMENT.	1. SEE DOOR TYPE FOR DOOR MANUFACTURER OR APPROVED EQUAL. 2.VERIFY SCREENS WITH OWNER. 3. DOOR & FRAME FINISHES APPROVED BY OWNER PRIOR TO ORDERING. 4. SIZE CALL OUT 3680= 3'-6" WIDE X 8'-0" HIGH. 5. FIELD VERIFY ALL DIMENSIONS & DESIGN W/ OWNER, PROVIDE SUBMITTAL TO ARCHITECT/ OWNER. 6. EXTERIOR FRENCH DOOR GLAZING SHALL BE TEMPERED GLASS. 7. DOORS ORDER TO BE APPROVED BY OWNER PRIOR TO CONTRACTOR PLACING ORDER. 8. INSTALL PER MANUFACTURER'S RECOMMENDATIONS. 9. THE MANUFACTURED WINDOWS SHALL HAVE A LABEL ATTACHED CERTIFIED BY THE NATIONAL FENESTRATION RATING COUNCIL (NFRC) AND SHOWING COMPLIANCE WITH THE ENERGY CALC. 10. PROVIDE FULL WEATHERSTRIPPING @ALL EXTERIOR DOORS & DOORS TO ATTIC. 11. ALL GLAZING LOW-E PER T-24 CALCS. 12. CASING SELECTED BY OWNER- MATCH (E) SEE DETAIL 9/A8.2. 13. REPAIR, RESTORE & REFINISH ALL EXISTING WOOD WINDOWS/ DOORS INTERIOR & EXTERIOR. 14. ALL GLAZING IN EXISTING DOORS & WINDOWS TO REMAIN SINGLE PANE WITH TRUE DIVIDED LITES.	A A/S HM/G S SCW STL TS VNL FF WD V	ALUMINIUM & SPANDREL HOLLOW METAL & GLASS SPANDREL GLASS SOLID CORE WOOD STEEL TUBE STEEL VINYL FACTORY FINISH WOOD VENEER	A/G HM PTD SS SCW/G TH WI CL HCW GL TS	ALUMINIUM & GLASS HOLLOW METAL PAINTED STAINLESS STEEL SOLID CORE WOOD & GLASS TEMP. HARDBOARD WROUGHT IRON CHAIN LINK HOLLOW CORE WOOD GLASS TUBE STEEL


WINDOW SCHEDULE								
V	Width	Sill Height	Lintel	FRAME MATERIAL	WINDOW MATERIAL	Window Finish	WINDOW FRAME FINISH	Level
W19	1' - 6"			WD/GL	WD		PT	
W19	1' - 6"			WD/GL	WD		PT	
W1	1' - 10"	2' - 11 1/2"	6' - 3 1/2"	WD/GL	WD	PT	PT	FIRST FLOOR
W1	1' - 10"	2' - 11 1/2"	6' - 3 1/2"	WD/GL	WD	PT	PT	FIRST FLOOR
W3	2' - 0"	3' - 9"	6' - 9"	WD/GL	WD	PT	PT	FIRST FLOOR
W4	2' - 4"	1' - 5"	6' - 5"	WD/GL	WD	PT	PT	FIRST FLOOR
W4	2' - 4"	1' - 5"	6' - 5"	WD/GL	WD	PT	PT	FIRST FLOOR
W5	2' - 8"	3' - 7"	7' - 7"	WD/GL	WD	PT	PT	FIRST FLOOR
W5	2' - 8"	3' - 7"	7' - 7"	WD/GL	WD	PT	PT	FIRST FLOOR
W6	2' - 10"	3' - 9"	6' - 9"	WD/GL	WD	PT	PT	FIRST FLOOR
W7	2' - 10 1/2"	0' - 0"	6' - 9"	WD/GL	WD	PT	PT	FIRST FLOOR
W11	3' - 6"	2' - 11 1/2"	6' - 3 1/2"	WD/GL	WD	PT	PT	FIRST FLOOR
W9	4' - 0"	0' - 9"	6' - 9"	WD/GL	WD	PT	PT	FIRST FLOOR
W9	4' - 0"	0' - 9"	6' - 9"	WD/GL	WD	PT	PT	FIRST FLOOR
W9	4' - 0"	3' - 0"	6' - 0"	WD/GL	WD	PT	PT	FIRST FLOOR
W10	5' - 0"	1' - 5"	6' - 5"	WD/GL	WD	PT	PT	FIRST FLOOR
W17	5' - 0"	2' - 0"	6' - 0"	WD/GL	WD	PT	PT	FIRST FLOOR
W11	6' - 0"	2' - 9"	6' - 9"	WD/GL	WD	PT	PT	FIRST FLOOR
W11	6' - 0"	2' - 9"	6' - 9"	WD/GL	WD	PT	PT	FIRST FLOOR
W12	6' - 5"	3' - 7"	7' - 7"	WD/GL	WD	PT	PT	FIRST FLOOR
W13	8' - 0"	0' - 9"	6' - 9"	WD/GL	WD	PT	PT	FIRST FLOOR
W15	8' - 0"	0' - 9"	6' - 9"	WD/GL	WD	PT	PT	FIRST FLOOR
W9	3' - 6"	5' - 6"	7' - 0"	WD/GL	WD	PT	PT	SECOND FLOOR
W18	3' - 6"	4' - 6"	7' - 4"	WD/GL	WD	PT	PT	SECOND FLOOR
W9	4' - 0"	3' - 9"	6' - 9"	WD/GL	WD	PT	PT	SECOND FLOOR
W9	4' - 0"	3' - 9"	6' - 9"	WD/GL	WD	PT	PT	SECOND FLOOR
W11	6' - 0"	3' - 5"	6' - 9"	WD/GL	WD	PT	PT	SECOND FLOOR
W11	6' - 0"	2' - 9"	6' - 9"	WD/GL	WD	PT	PT	SECOND FLOOR
W13	8' - 0"	3' - 5"	6' - 9"	WD/GL	WD	PT	PT	SECOND FLOOR
W13	8' - 0"	3' - 5"	6' - 9"	WD/GL	WD	PT	PT	SECOND FLOOR
W13	8' - 0"	3' - 5"	6' - 9"	WD/GL	WD	PT	PT	SECOND FLOOR
W19	1' - 6"			WD/GL	WD		PT	TOP ROOF LEVEL
W19	1' - 6"			WD/GL	WD		PT	TOP ROOF LEVEL
W19	1' - 6"			WD/GL	WD		PT	TOP ROOF LEVEL
W19	1' - 6"			WD/GL	WD		PT	TOP ROOF LEVEL
W19	1' - 6"			WD/GL	WD		PT	TOP ROOF LEVEL
W19	1' - 6"			WD/GL	WD		PT	TOP ROOF LEVEL
W19	1' - 6"			WD/GL	WD		PT	TOP ROOF LEVEL

WINDOW NOTES	DOOR WINDOW REMARKS
1. SEE SPECS FOR ADDITIONAL INFORMATION. 2. FACTORY PRIMED- PINE INT. & EXT. 3. SEE ELEVATIONS FOR DIVIDED LITE PATTERN. 4. PROVIDE MINIMUM CLEAR EGRESS OPENING DIMENSIONS AT EACH OPERABLE SECTION OF WINDOWS IN SLEEPING ROOMS AND DENS ( PER CURRENT CODE). 5. SEE DOOR SCHEDULE FOR INTEGRAL TRANSOM WINDOWS. 6. VERIFY SCREENS & BLINDS WITH OWNER. 7. VERIFY LOCATION AND DESIGN OF OBSCURE GLASS WITH OWNER, SEE PLAN. 8.WINDOWS BY: MARVIN, ULTIMATE WOOD OR EQ. 9. FIELD VERIFY ALL DIMENSIONS AND DESIGN W/ OWNER PROVIDE SUBMITTAL TO ARCH & OWNER. 10. SIZE CALL OUT 2155= 2'-1" WIDE X 5'-5" HIGH. 11. CALL OUT SIZES ARE NOMINAL DIMENSIONS, BID STANDARD SIZES, TYP. 12. INSTALL PER MANUFACTURER RECOMMENDATIONS 13. WINDOW ORDER TO BE APPROVED BY OWNER & ARCHITECT PRIOR TO CONTRACTOR PLACING ORDER. 14. THE MANUFACTURED WINDOWS SHALL HAVE A LABEL ATTACHED CERTIFIED BY THE NATIONAL FENESTRATION RATING COUNCIL (NFRC) AND SHOWING COMPLIANCE WITH THE ENERGY CALCS. 15. ALL NEW GLAZING PER TITLE 24 U.O.N. 16. WINDOWS & FRAME FINISHES TO BE APPROVED BY OWNER PRIOR TO ORDERING. 17. OPERABLE WINDOWS WITH SILLS 6 FEET OR MORE ABOVE GRADE MUST BE 24" ABOVE THE FLOOR THEY SERVE.	① MEETS EGRESS REQUIREMENTS. ② OBSCURED GLASS ③ FIELD VERIFY HEIGHT ④ (N) DUAL- GLAZED




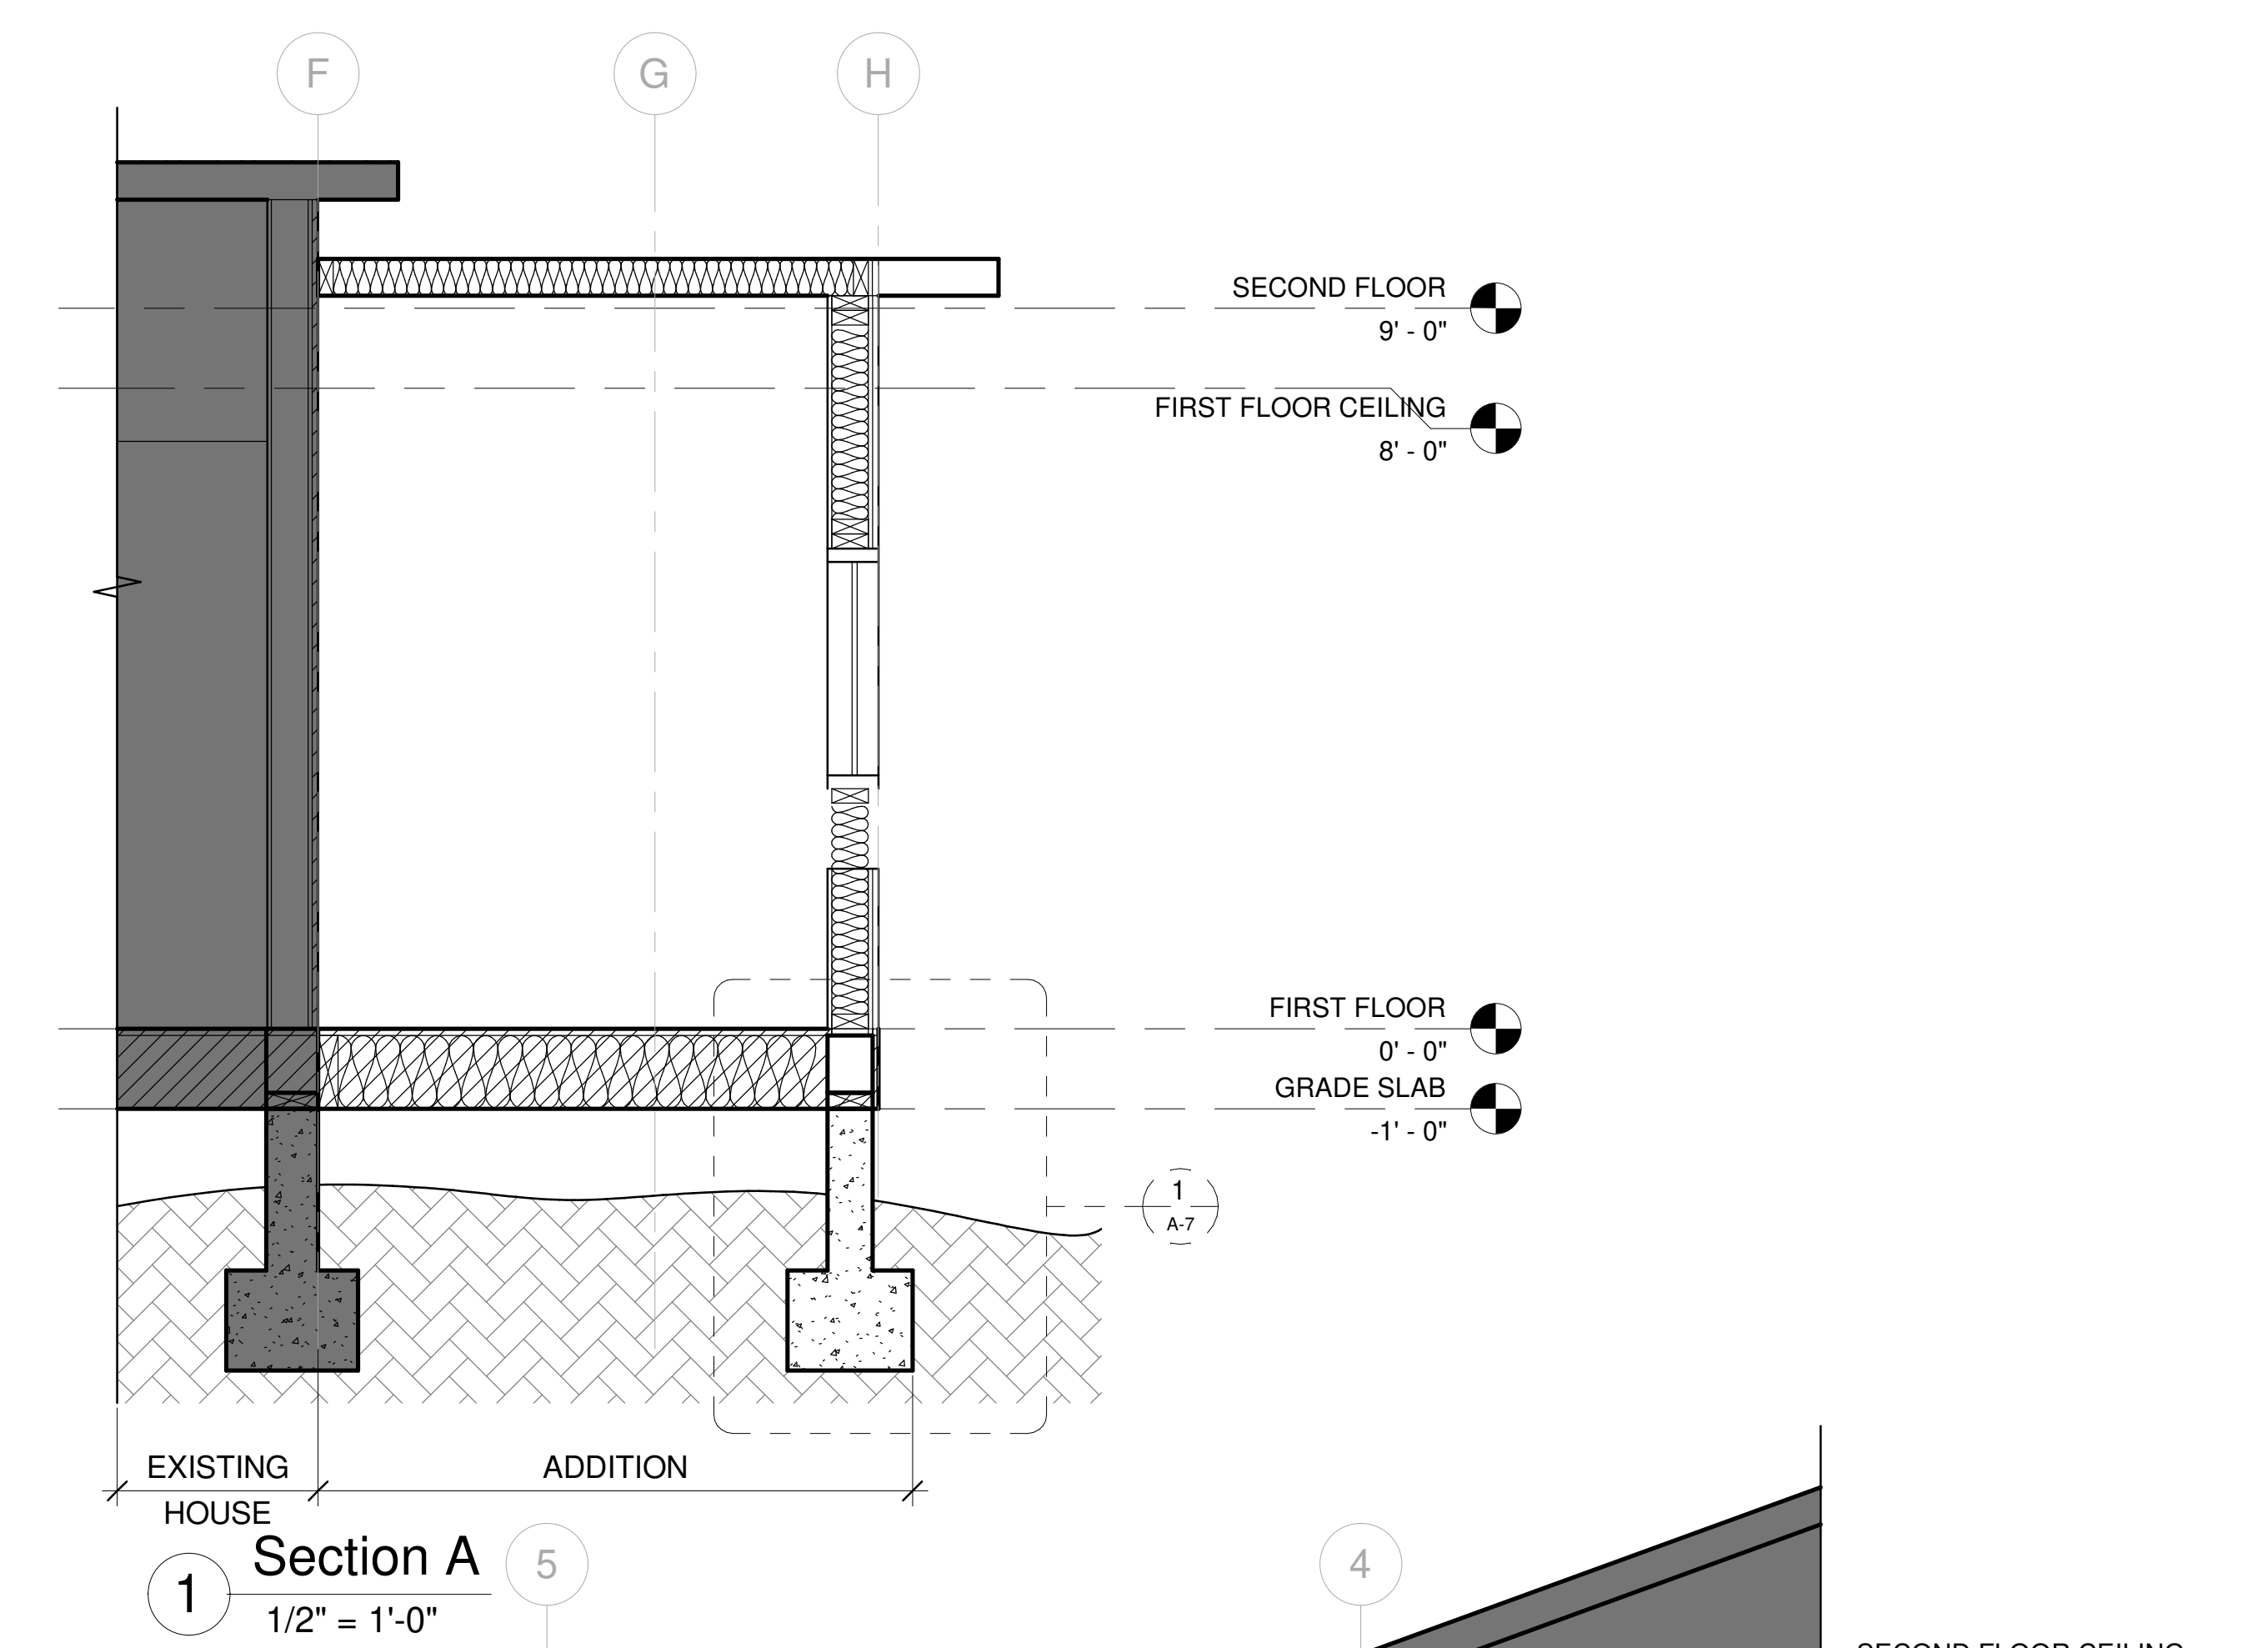

1 Section A  
1/2" = 1'-0"

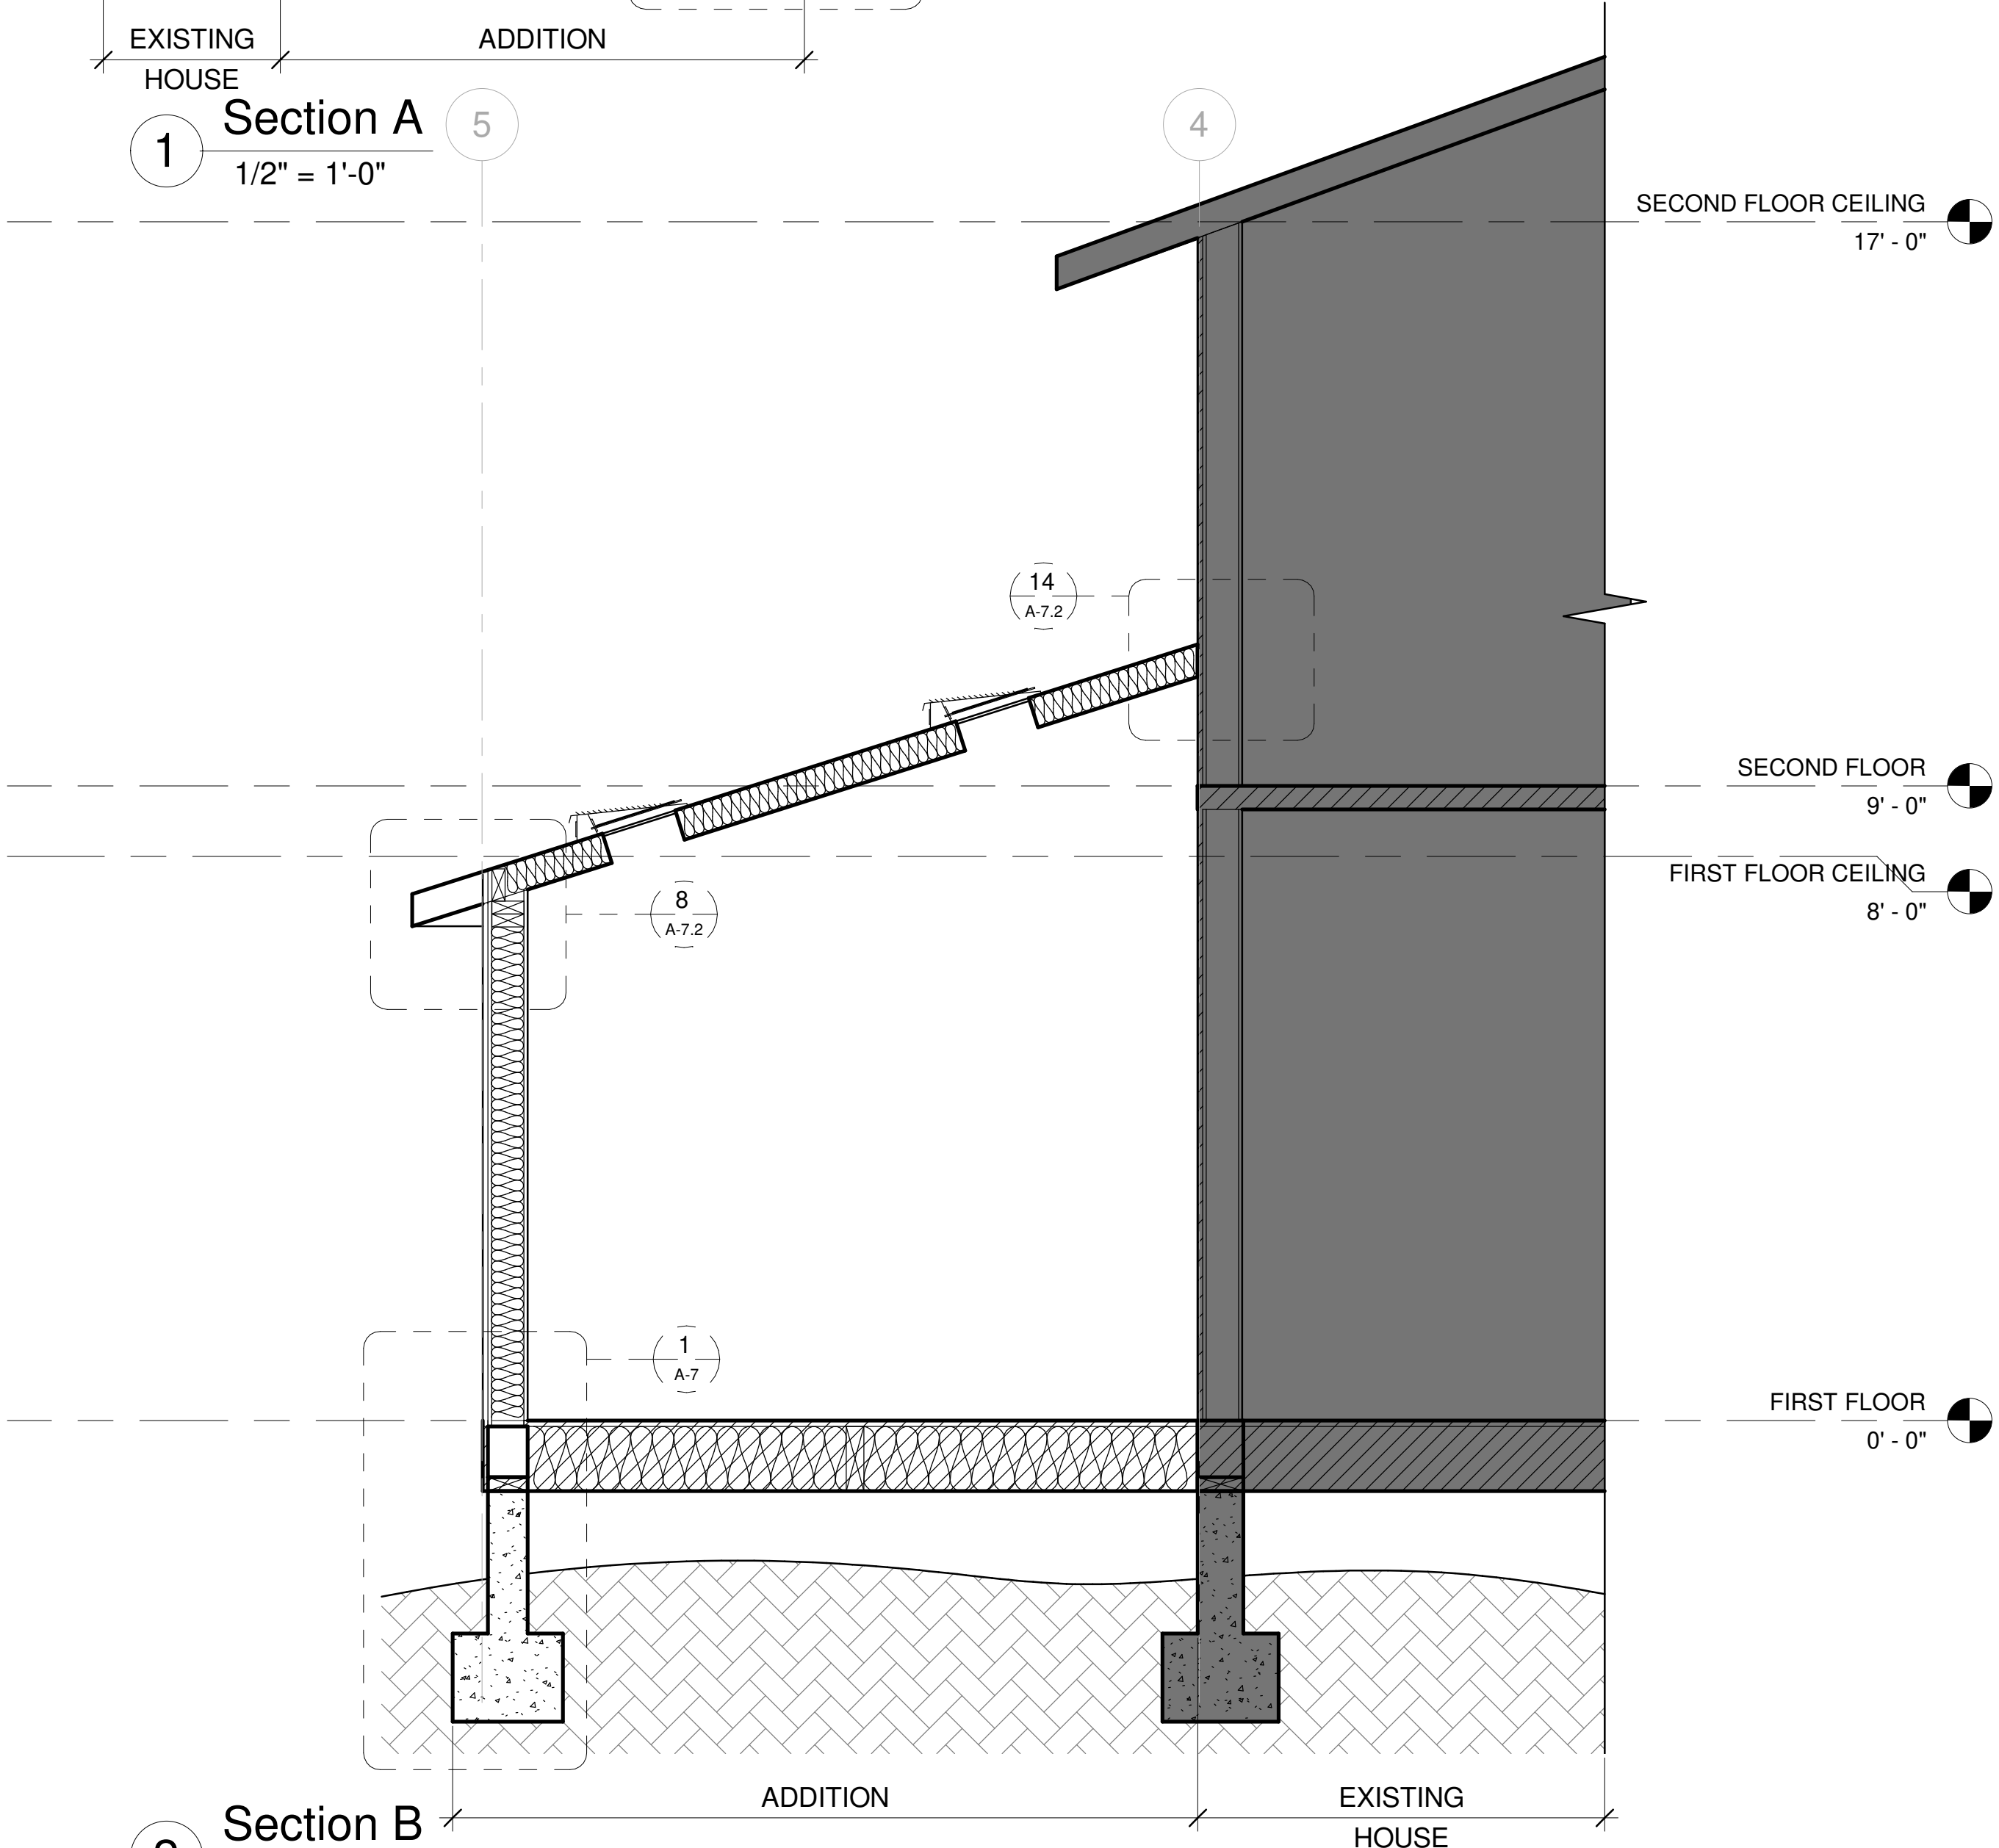

2 Section B  
1/2" = 1'-0"

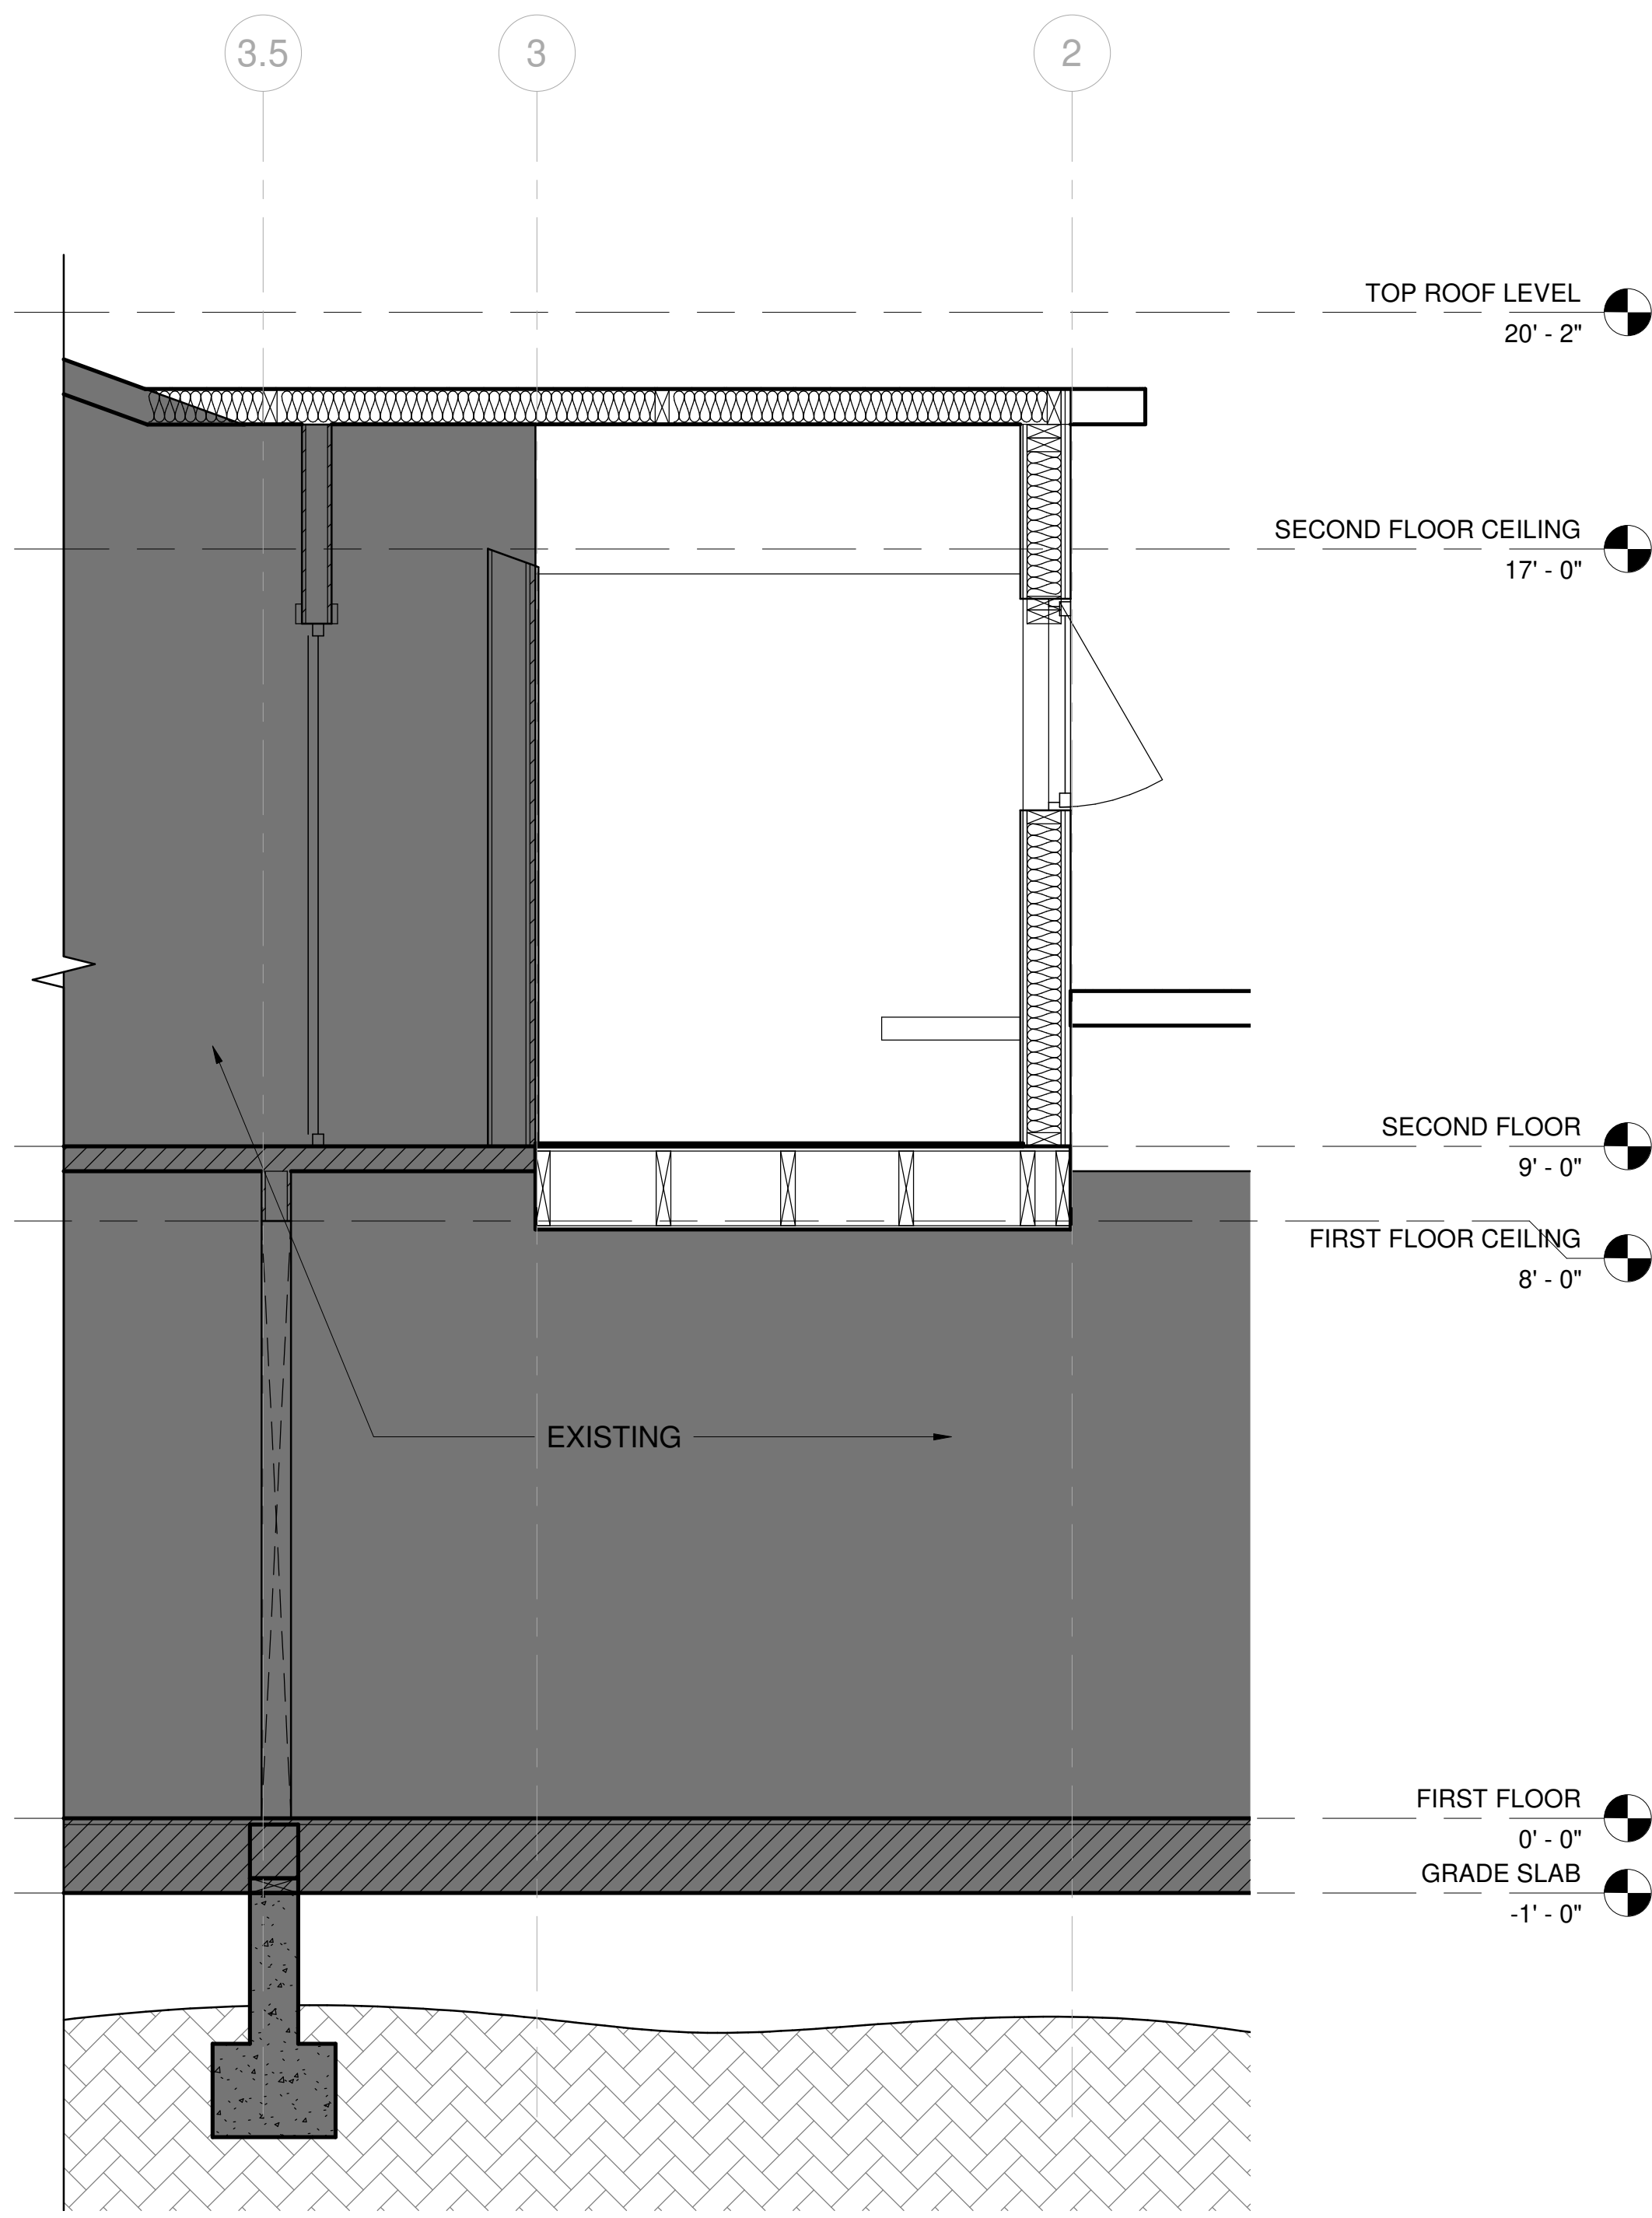


3 Section - C  
1/2" = 1'-0"




DELTA DESCRIPTION:	
DATE:	CITY SUBMITTAL
No.	
1	
2	
3	
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5	

DATE:	22/09/17
SCALE:	1/2" = 1'-0"
DRAWN BY :	
CKD BY:	
PROJECT :	202107199



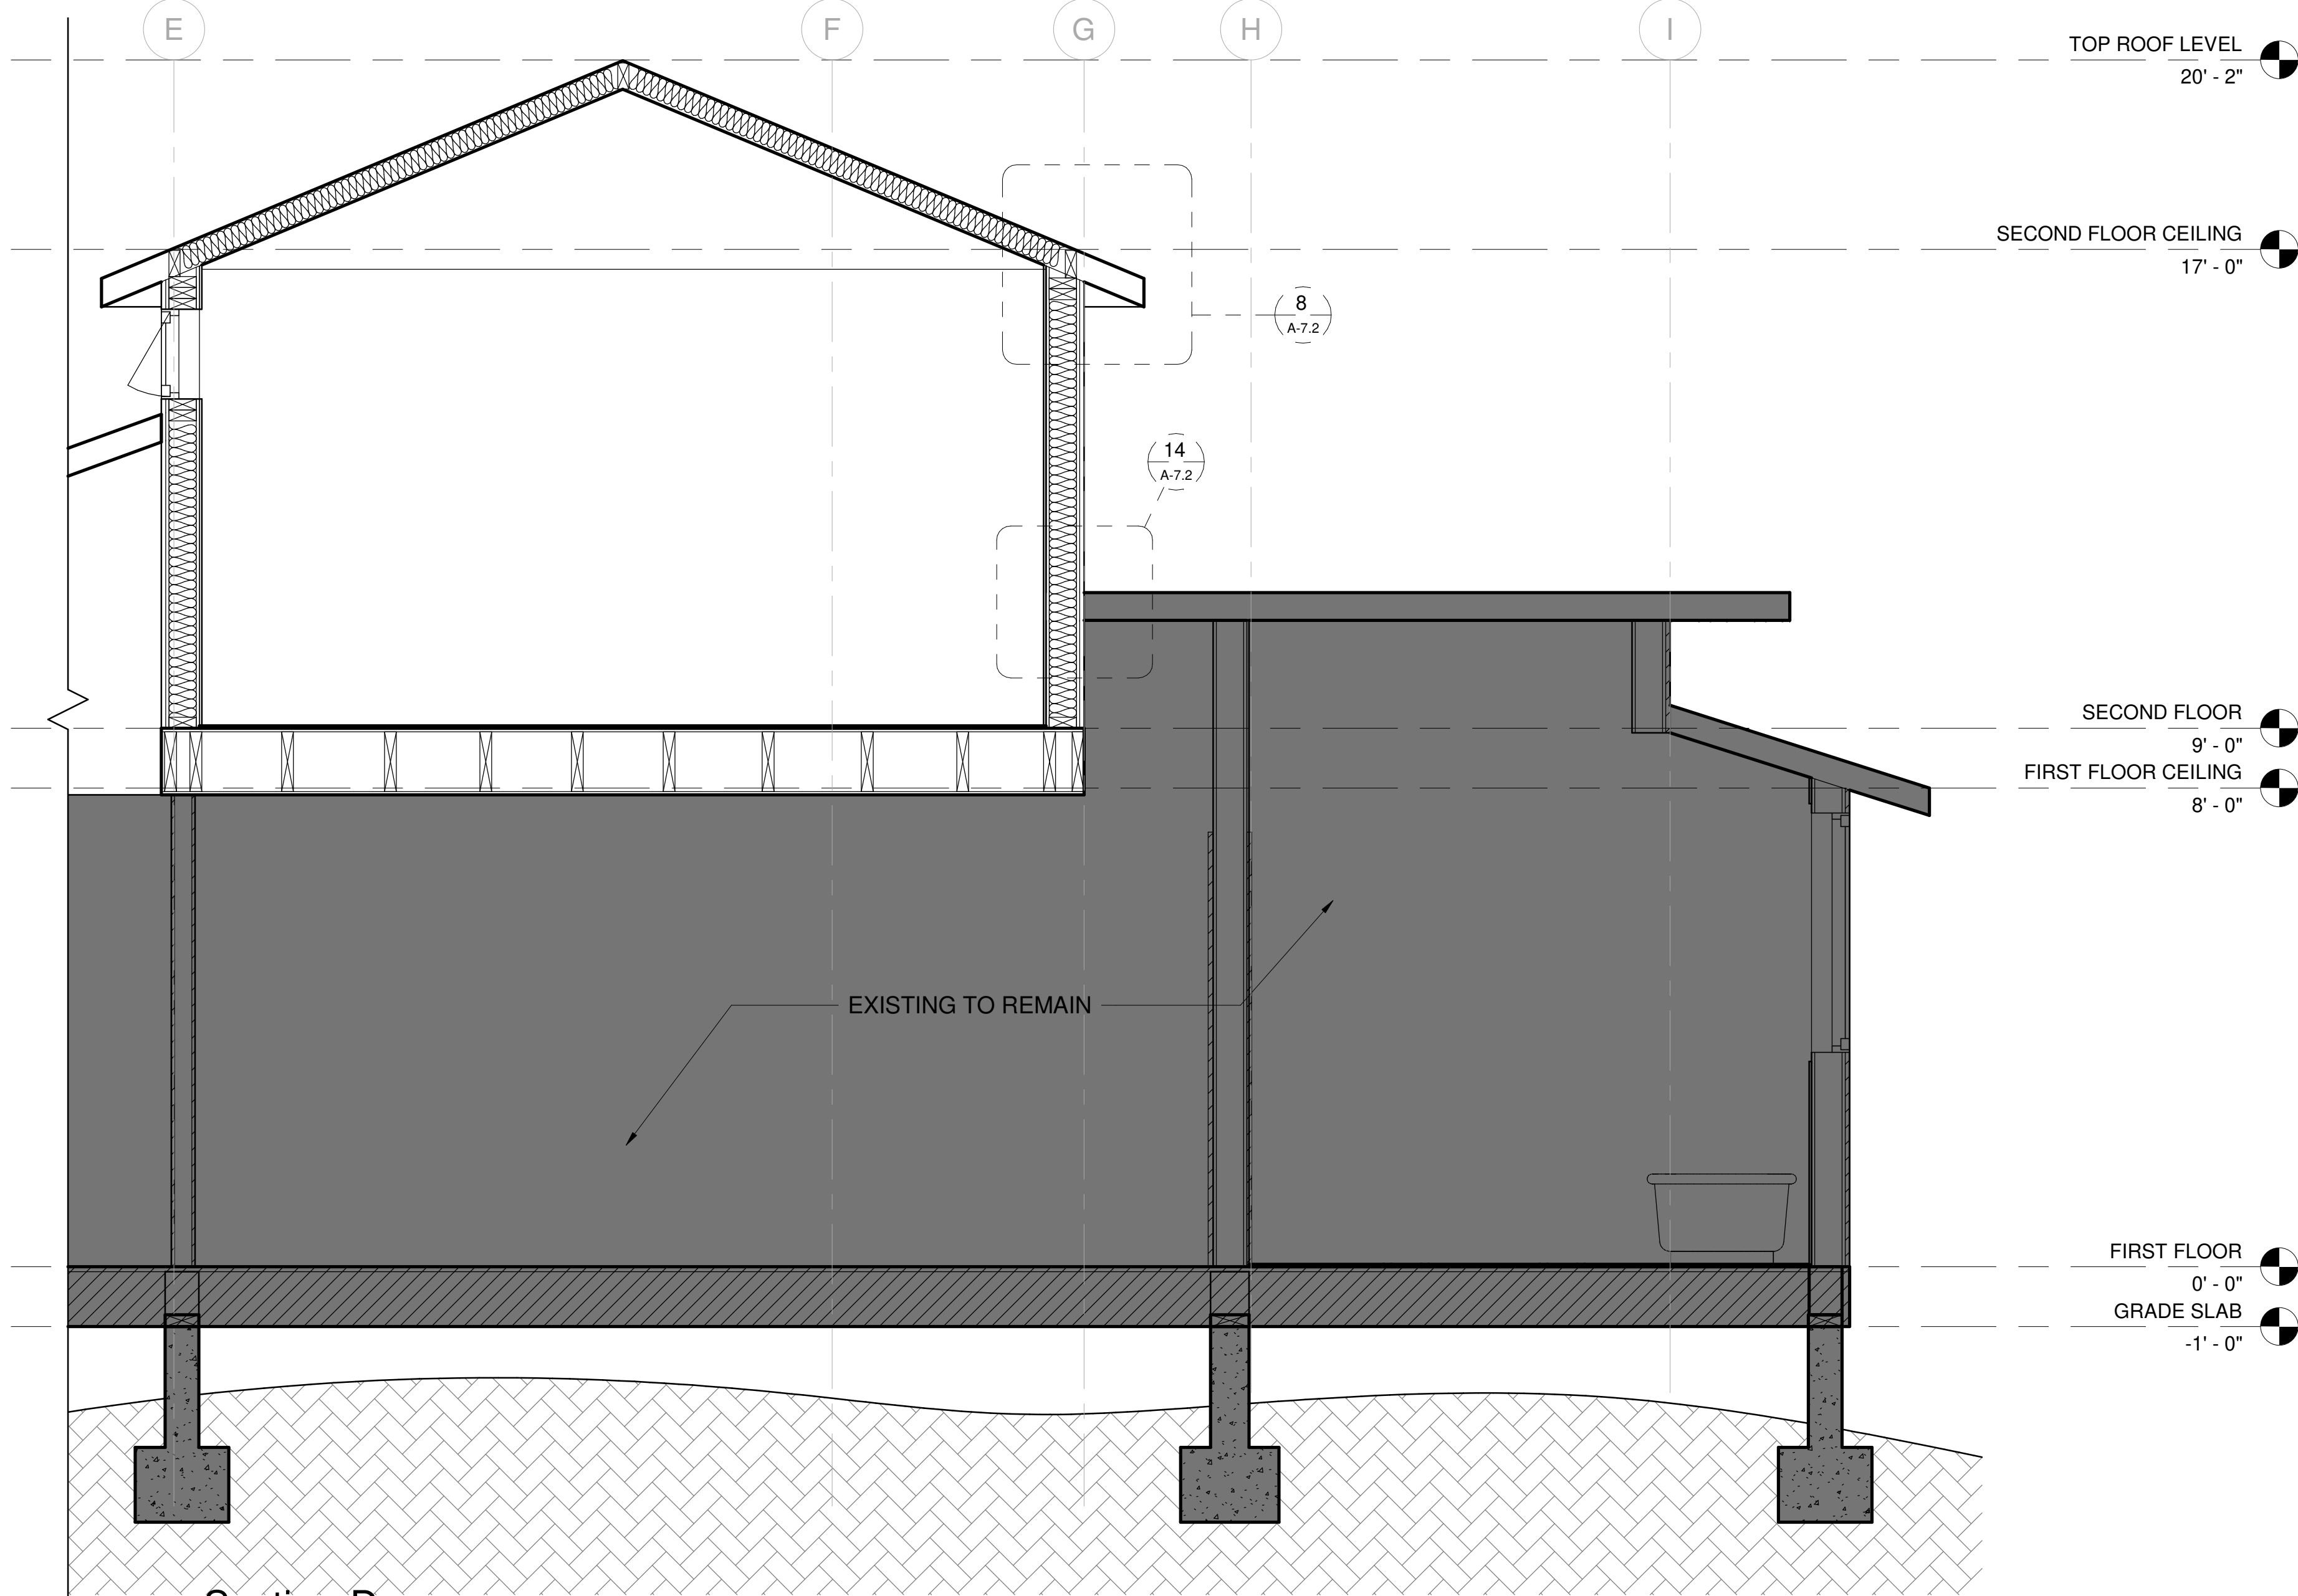


1 Section-D  
1/2" = 1'-0"

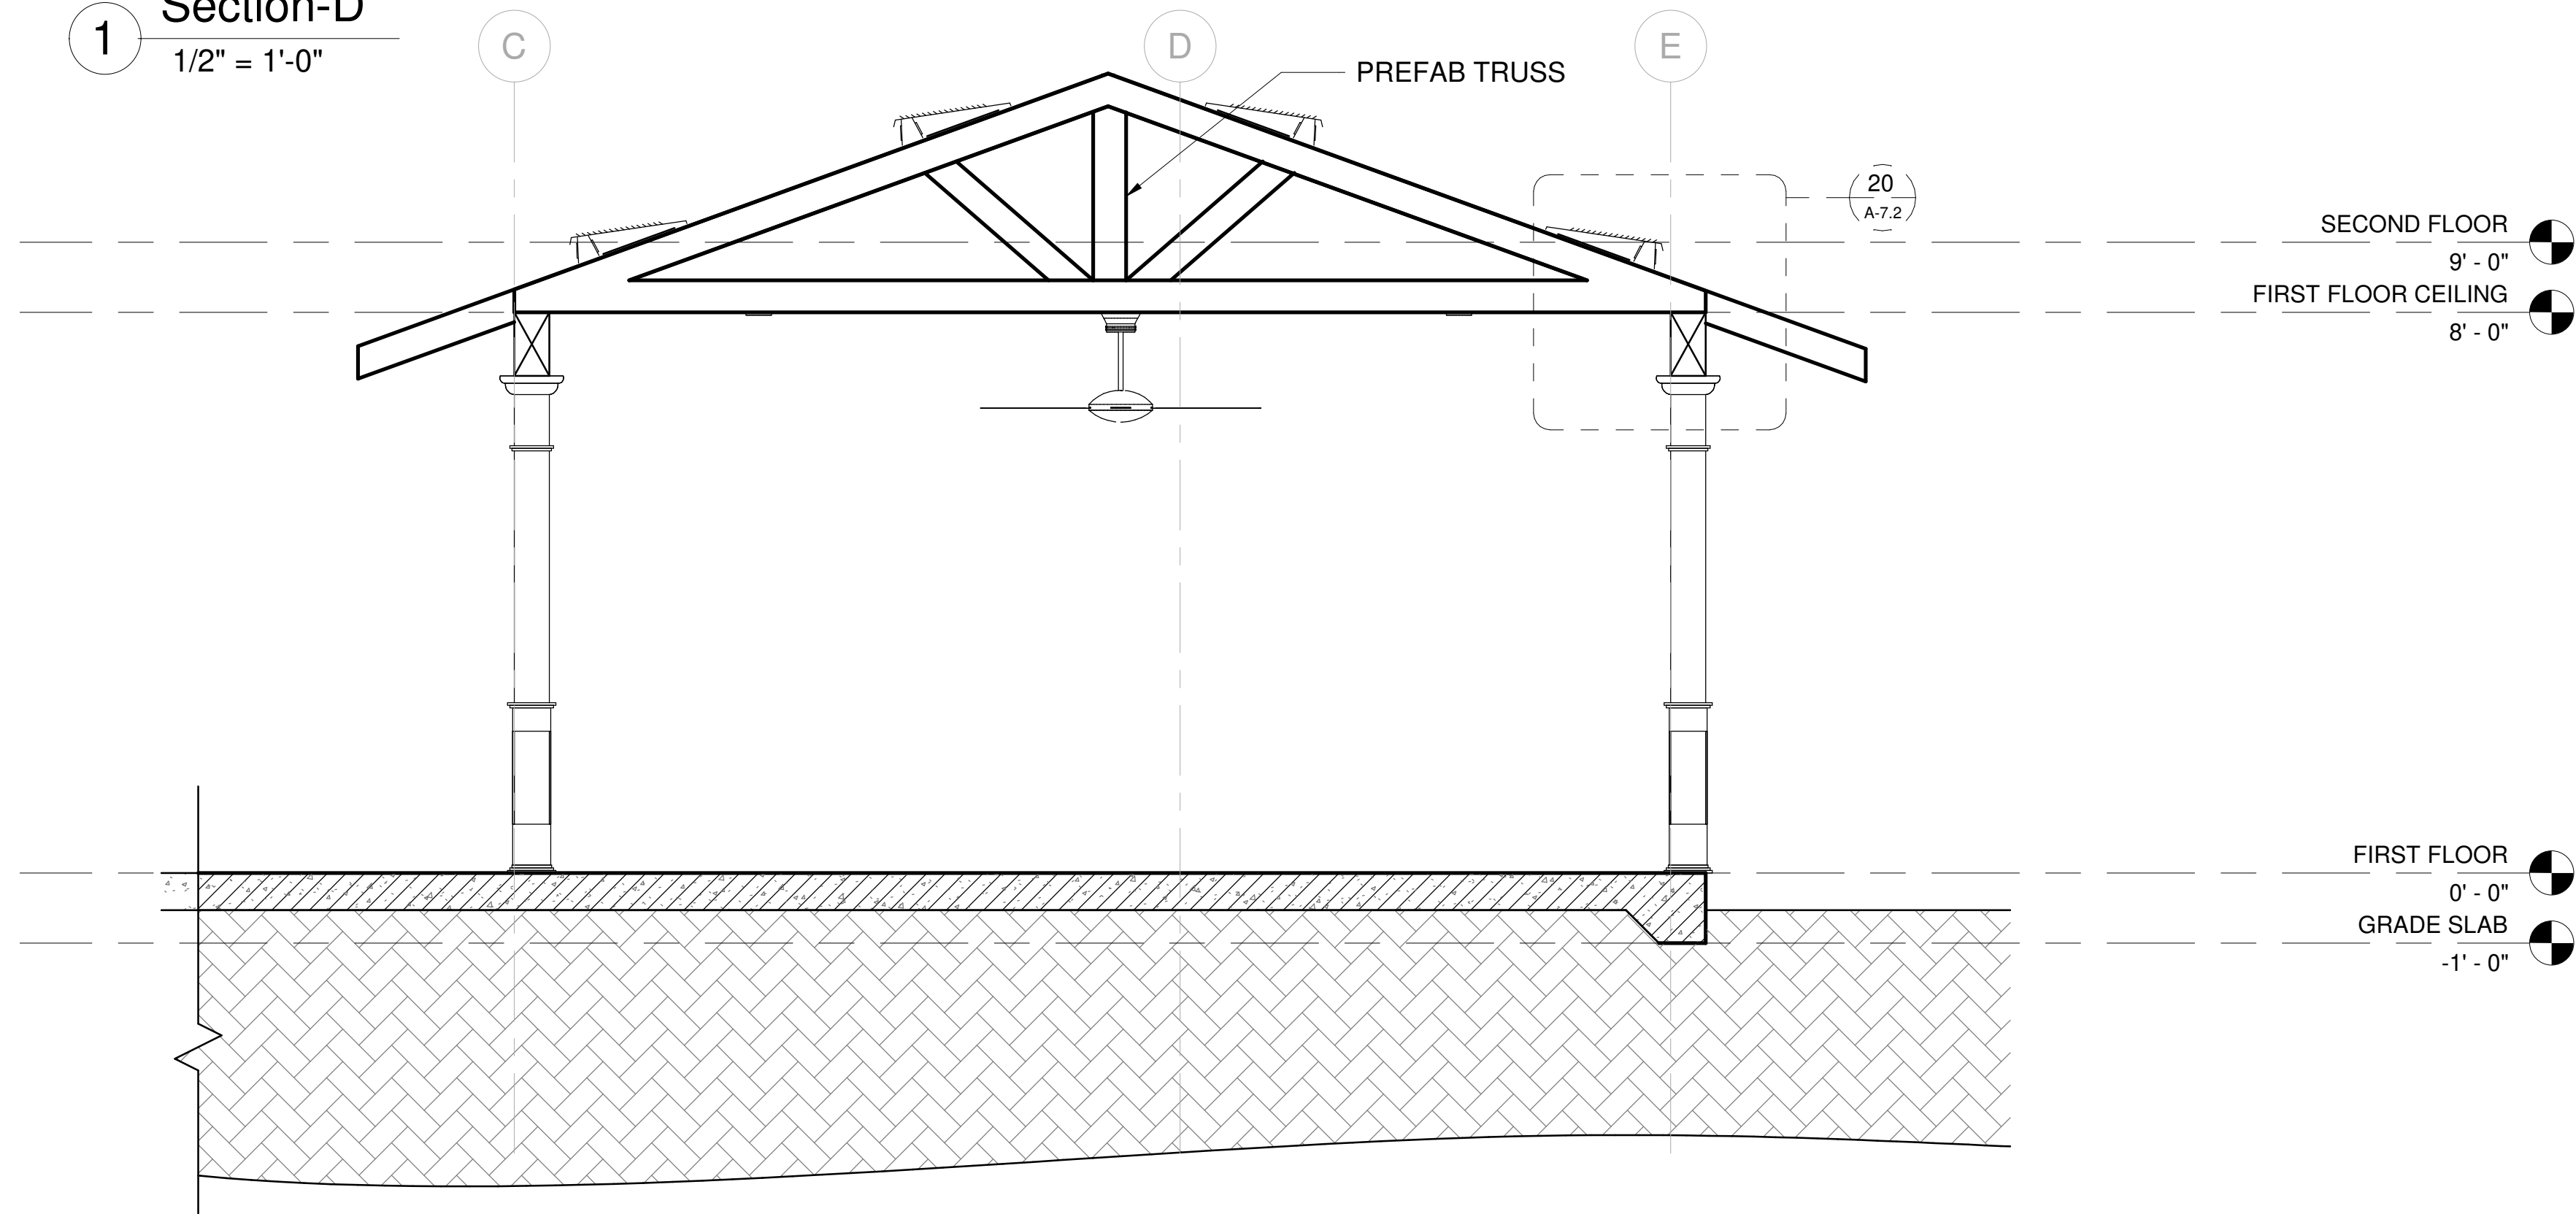

2 Section 1  
1/2" = 1'-0"



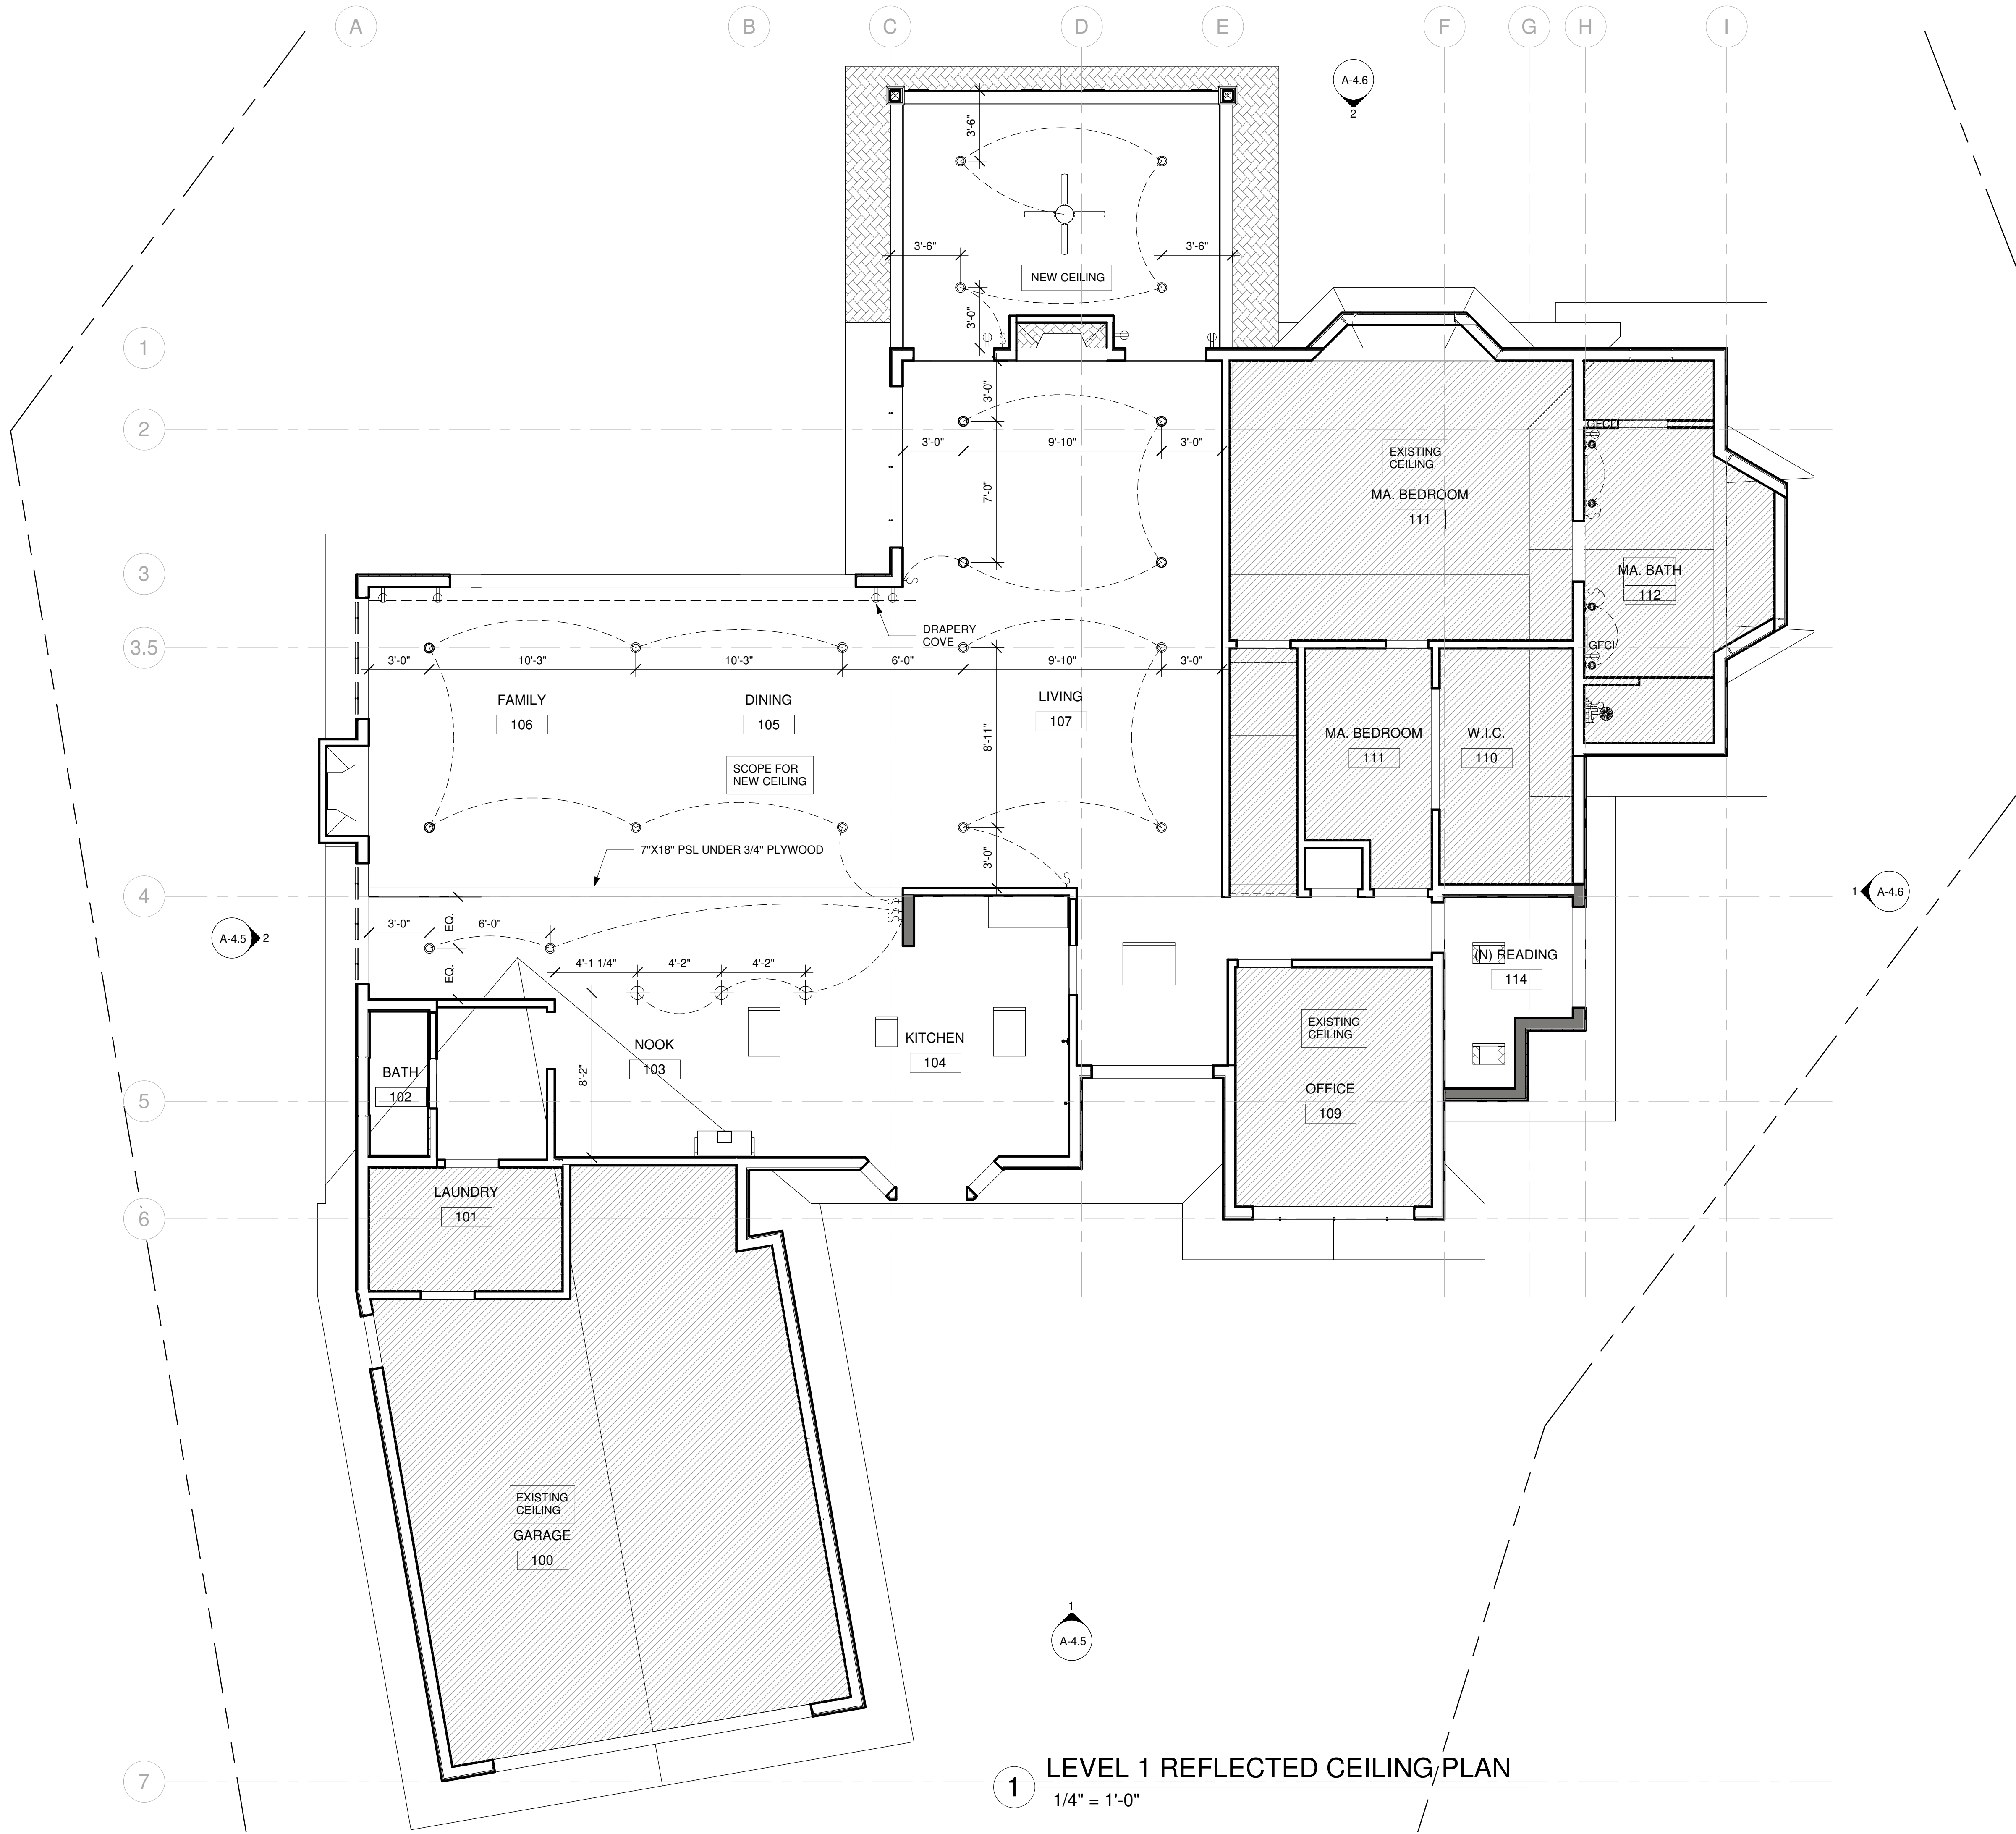

RCP LEGEND	
	DOWNLIGHT
	PENDANT LIGHT
	SWITCH
	OUTLET
	GROUND FAULT CIRCUIT INTERRUPTOR OUTLET



DESIGN EVEREST

CONSULTING ENGINEERS

365 FLOWER LANE  
MOUNTAIN VIEW, CA 94043  
PHONE: (888) 311-3015 FAX: (650) 695-1801

RCP FIRST FLOOR	AHMED RENOVATION ALINA AHMED LOT 15 1081 NOTTINGHAM WAY LOS ALTOS, CA 94024
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DATE:	DELTA DESCRIPTION:
22/09/17	CITY SUBMITTAL
No.	
1	
2	
3	
4	
5	

DATE:	22/09/17
SCALE:	As indicated
DRAWN BY :	
CKD BY:	
PROJECT :	202107199

DRAWING NO.  
A-6.1


1 LEVEL 1 REFLECTED CEILING PLAN  
1/4" = 1'-0"



1

LEVEL-02 REFLECTED CEILING PLAN

1/4" = 1'-0"

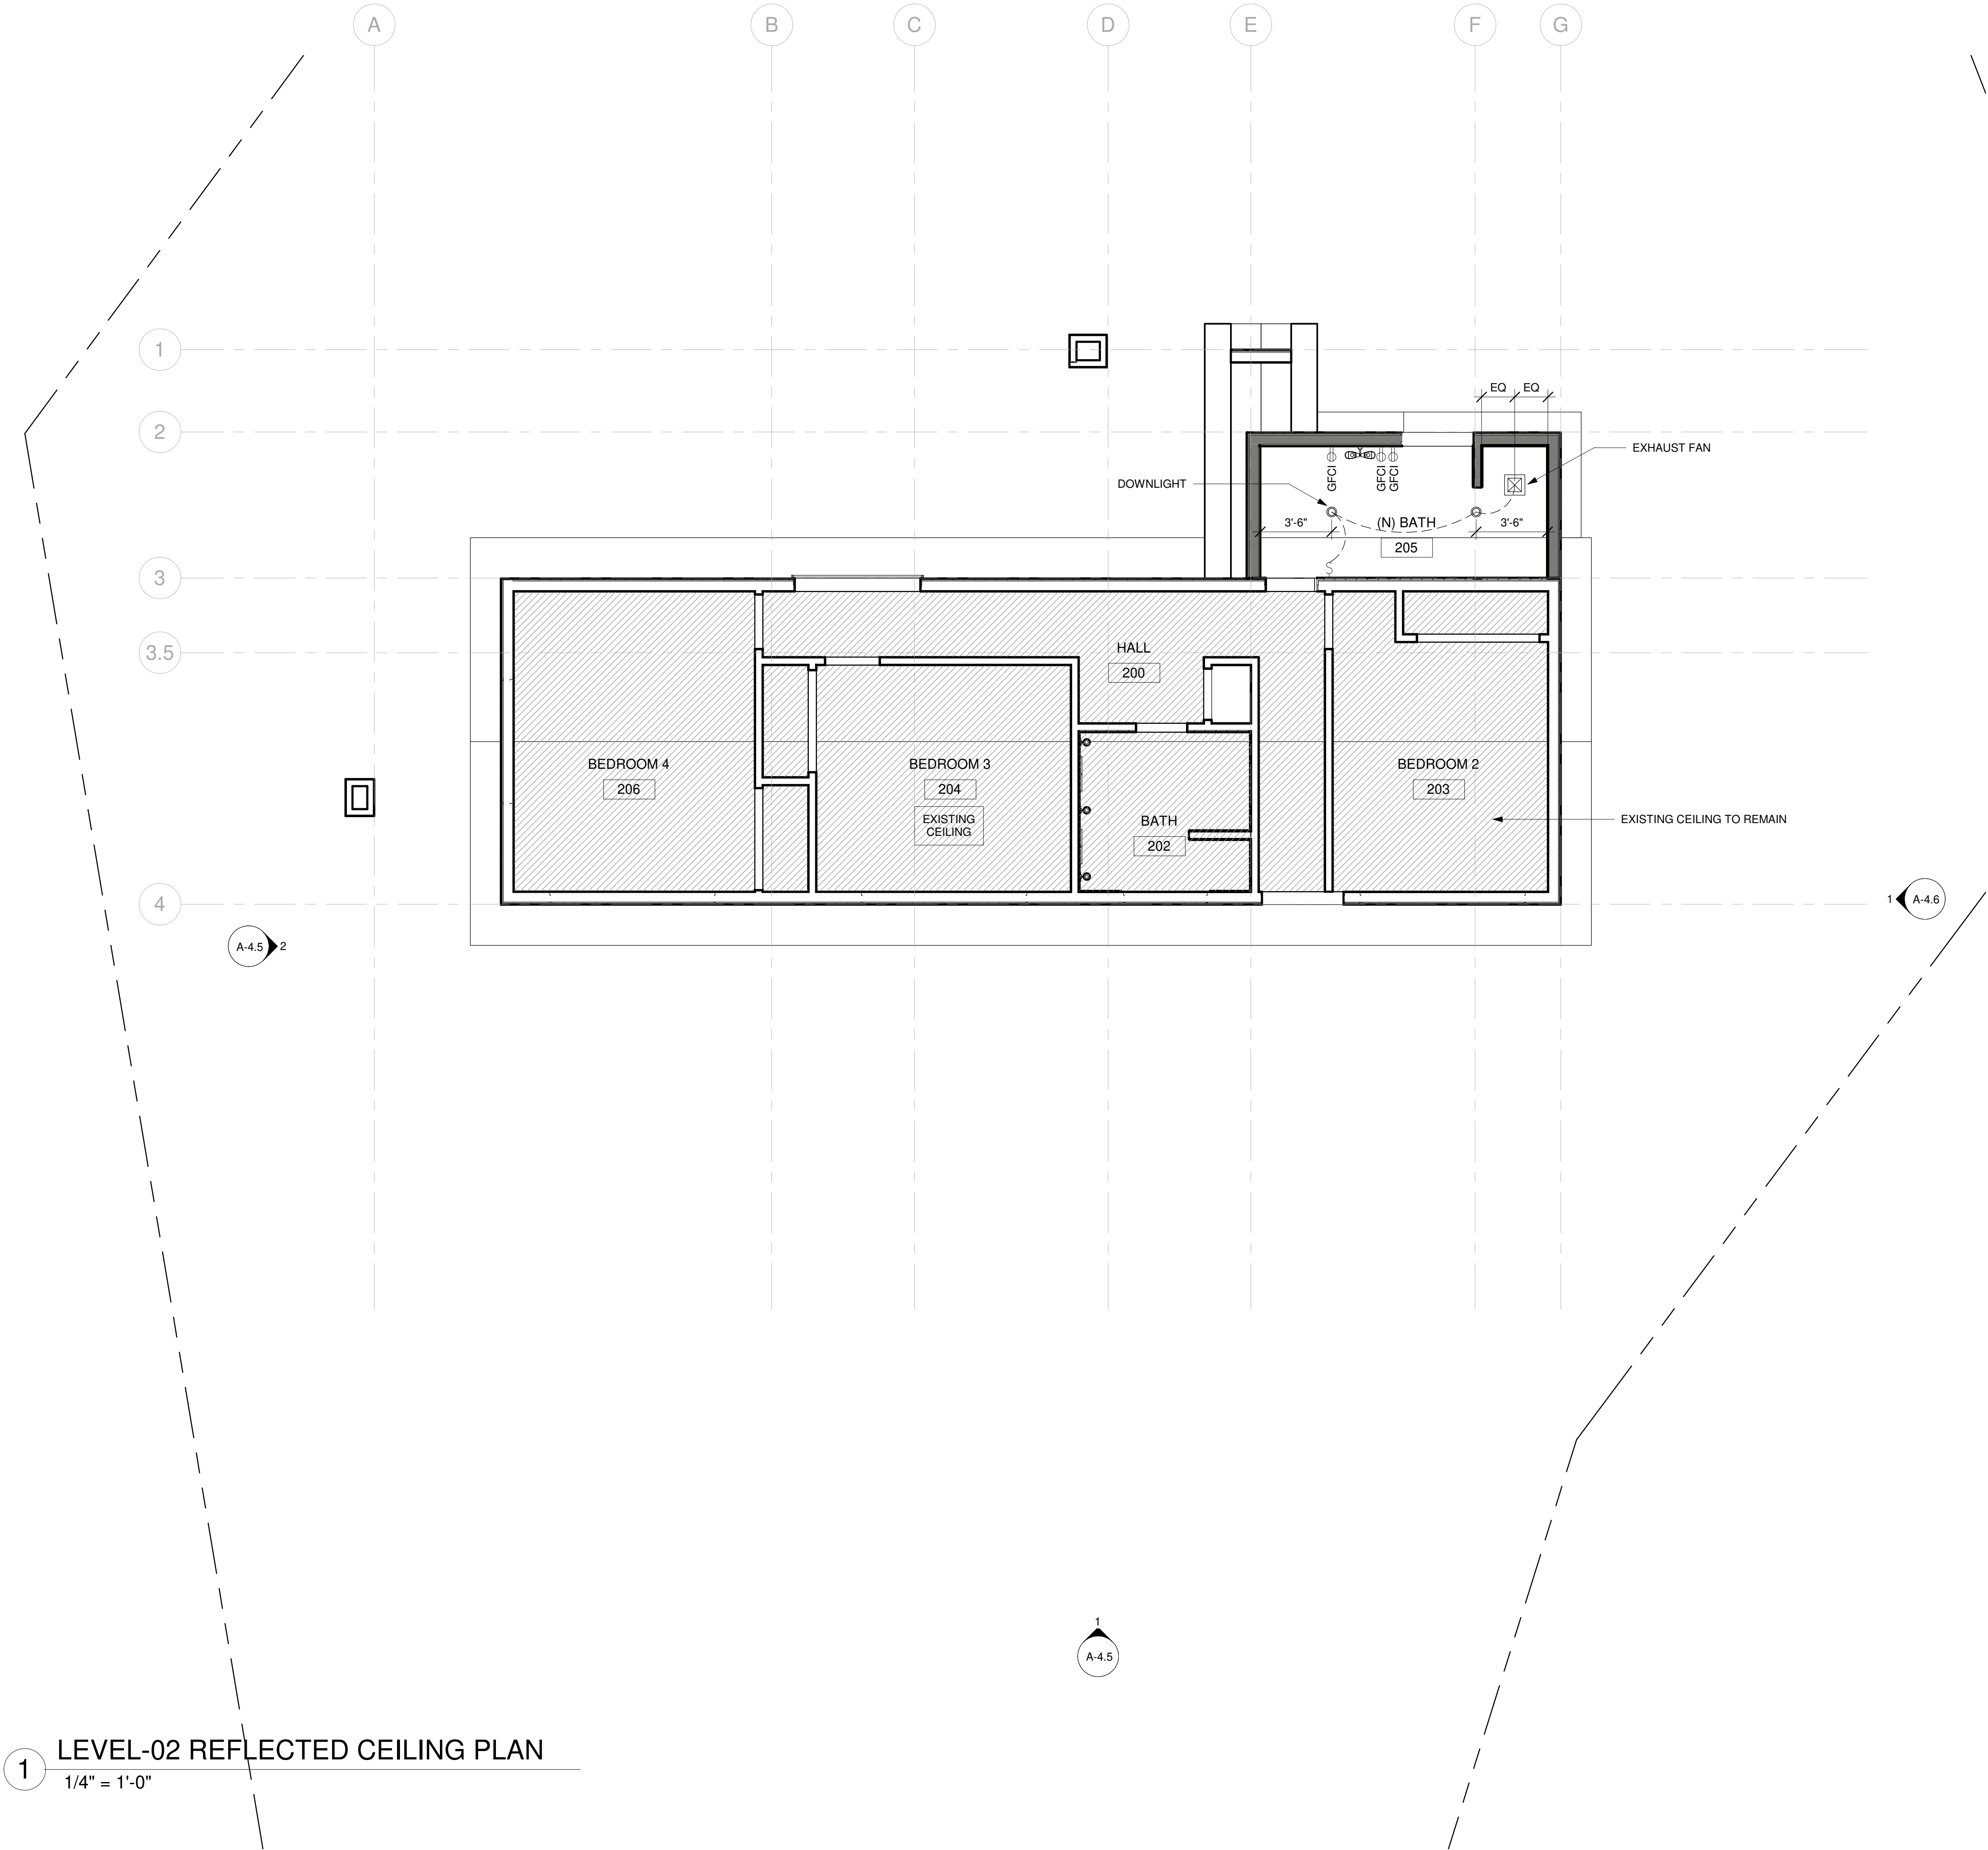

RCP LEGEND

- DOWNLIGHT
- PENDANT LIGHT
- SWITCH
- OUTLET
- GROUND FAULT CIRCUIT INTERRUPTOR OUTLET








RCP SECOND FLOOR  
AHMED RENOVATION  
ALINA AHMED  
LOT 15  
1081 NOTTINGHAM WAY  
LOS ALTOS, CA 94024

No.	DATE:	DELTA DESCRIPTION:
1	22/09/17	CITY SUBMITTAL
2		
3		
4		
5		






DATE: 22/09/17  
SCALE: As indicated  
DRAWN BY :  
CKD BY:  
PROJECT : 202107199

DRAWING NO.  
A-6.2




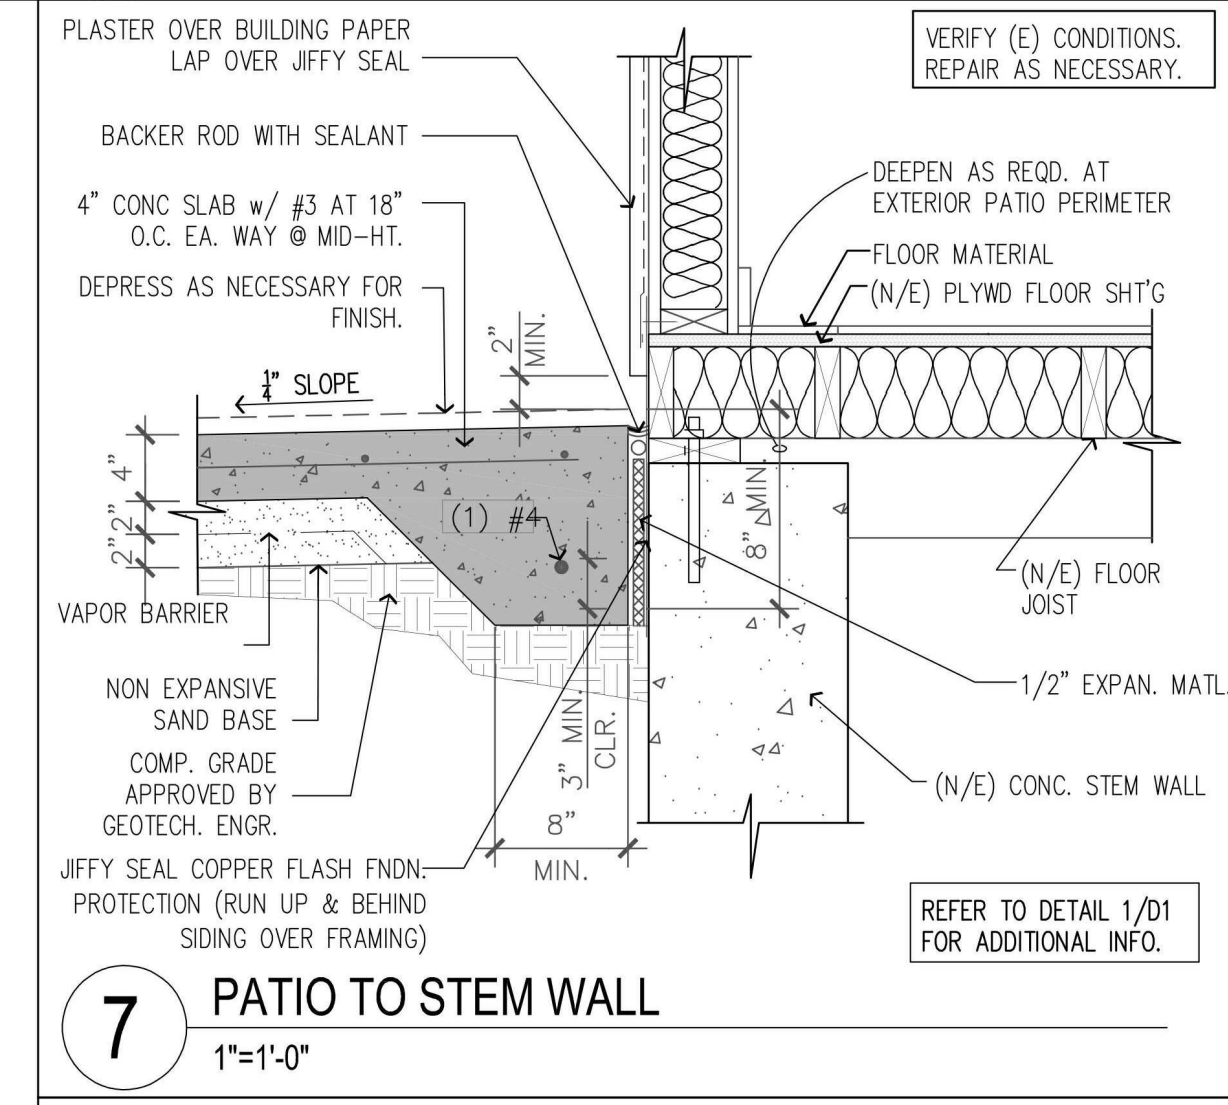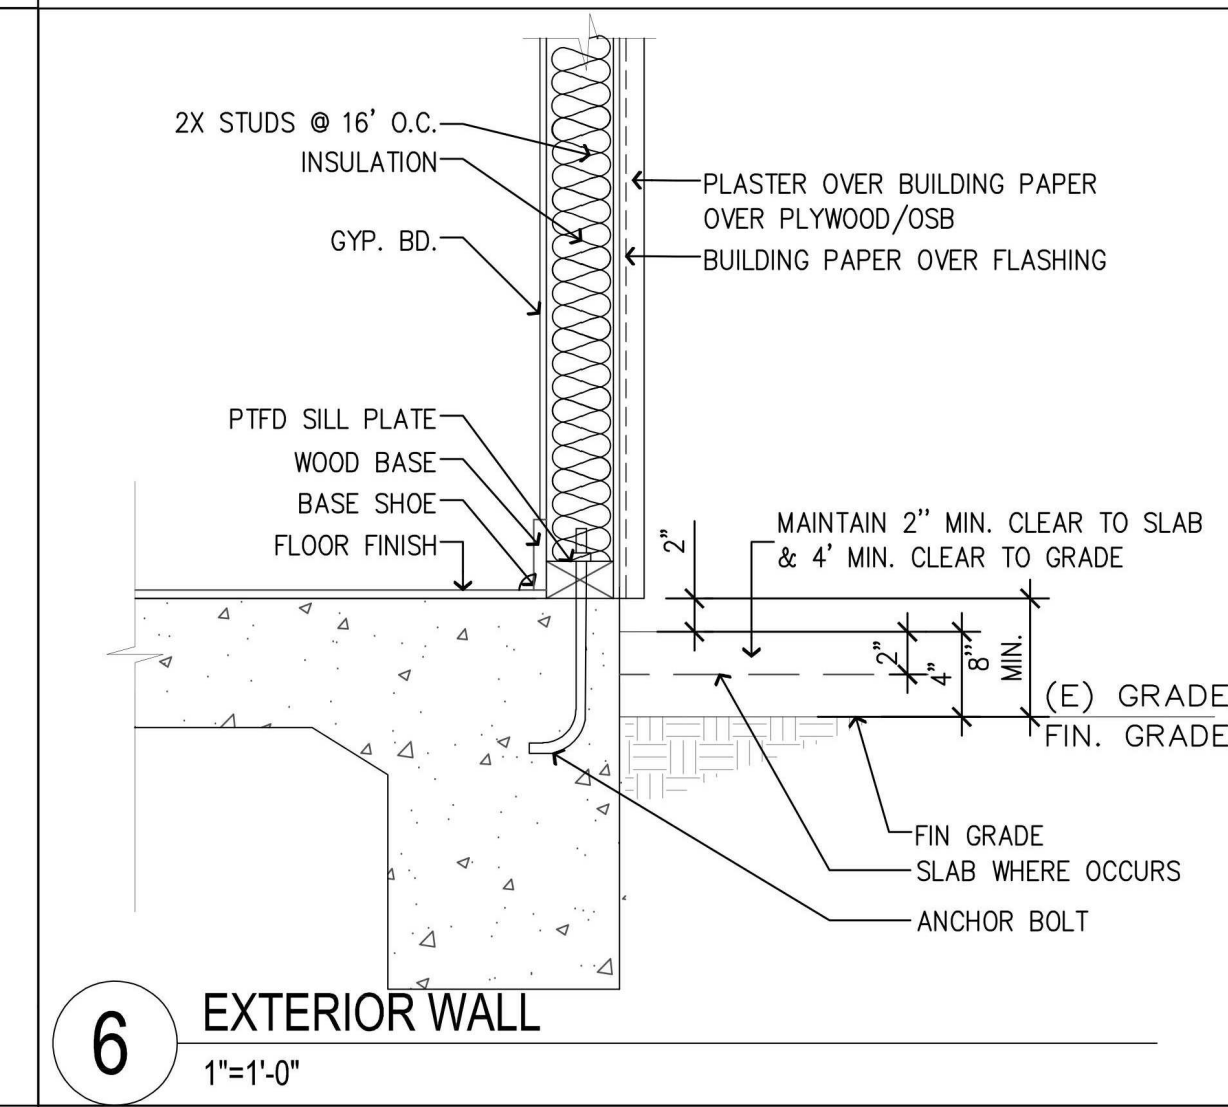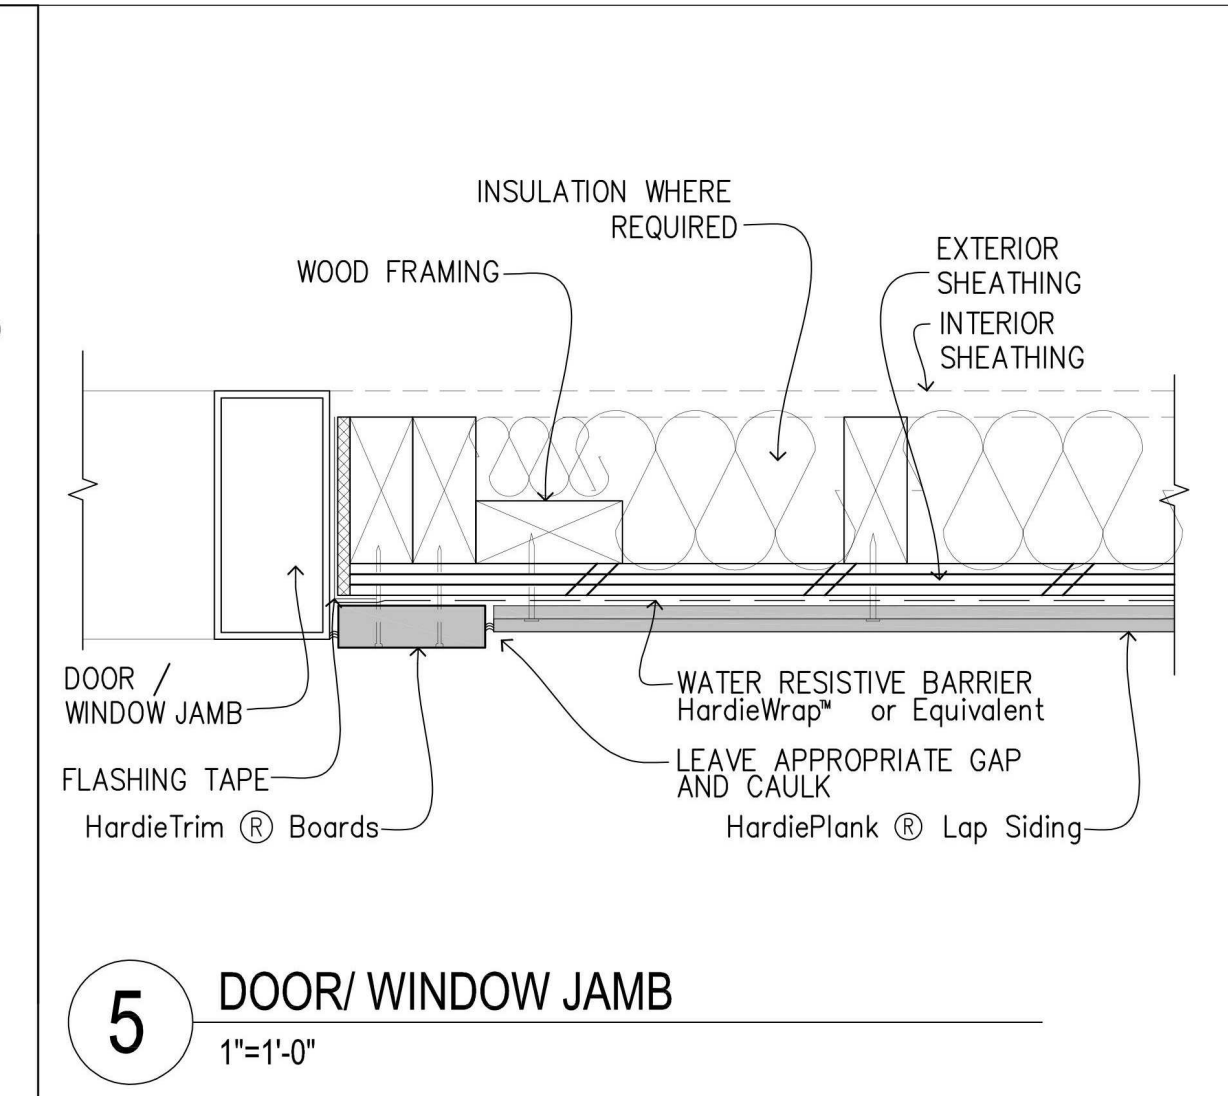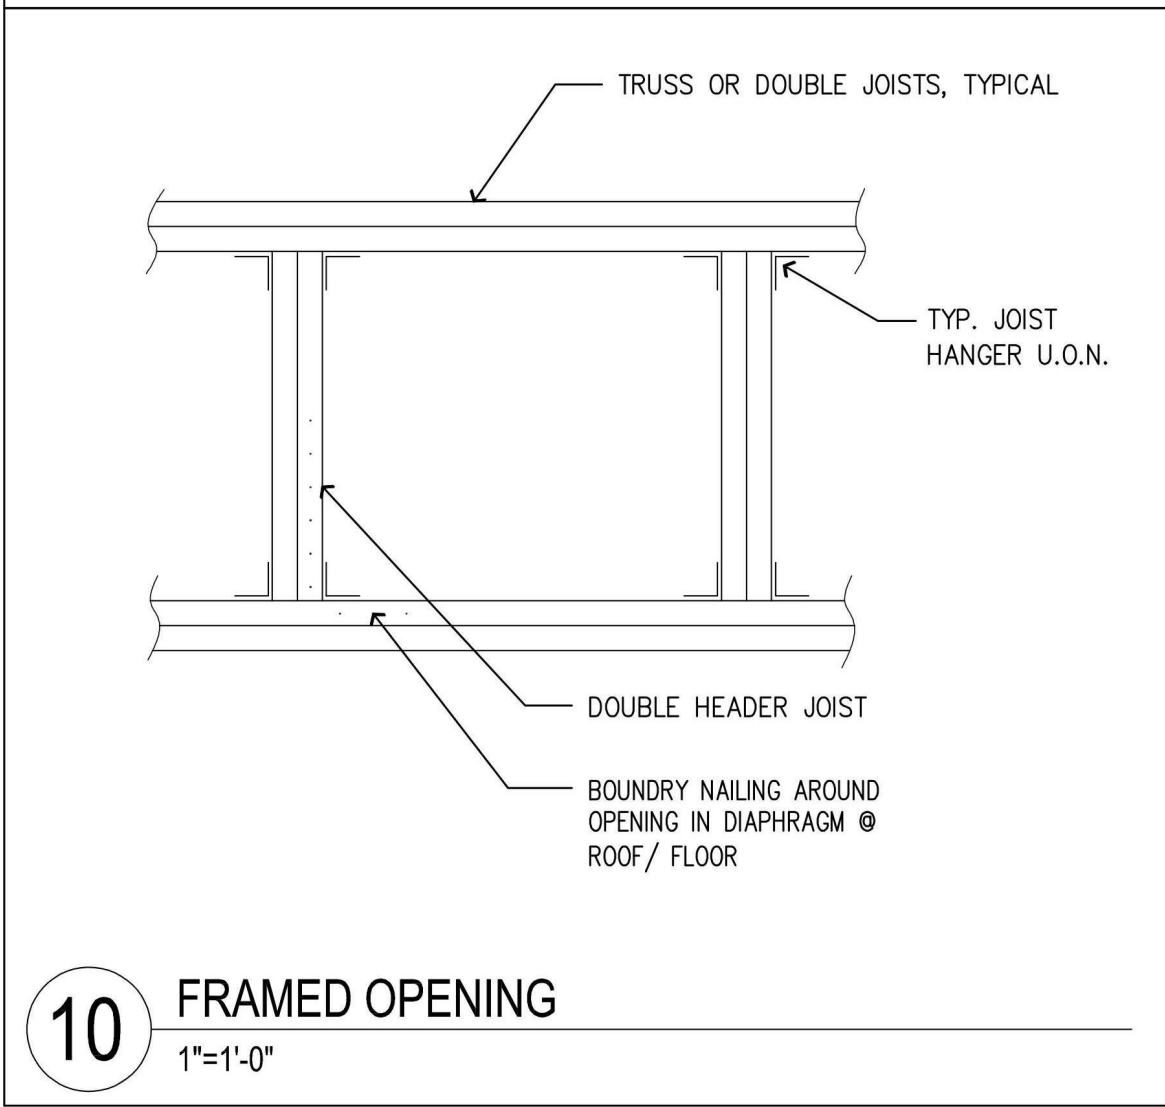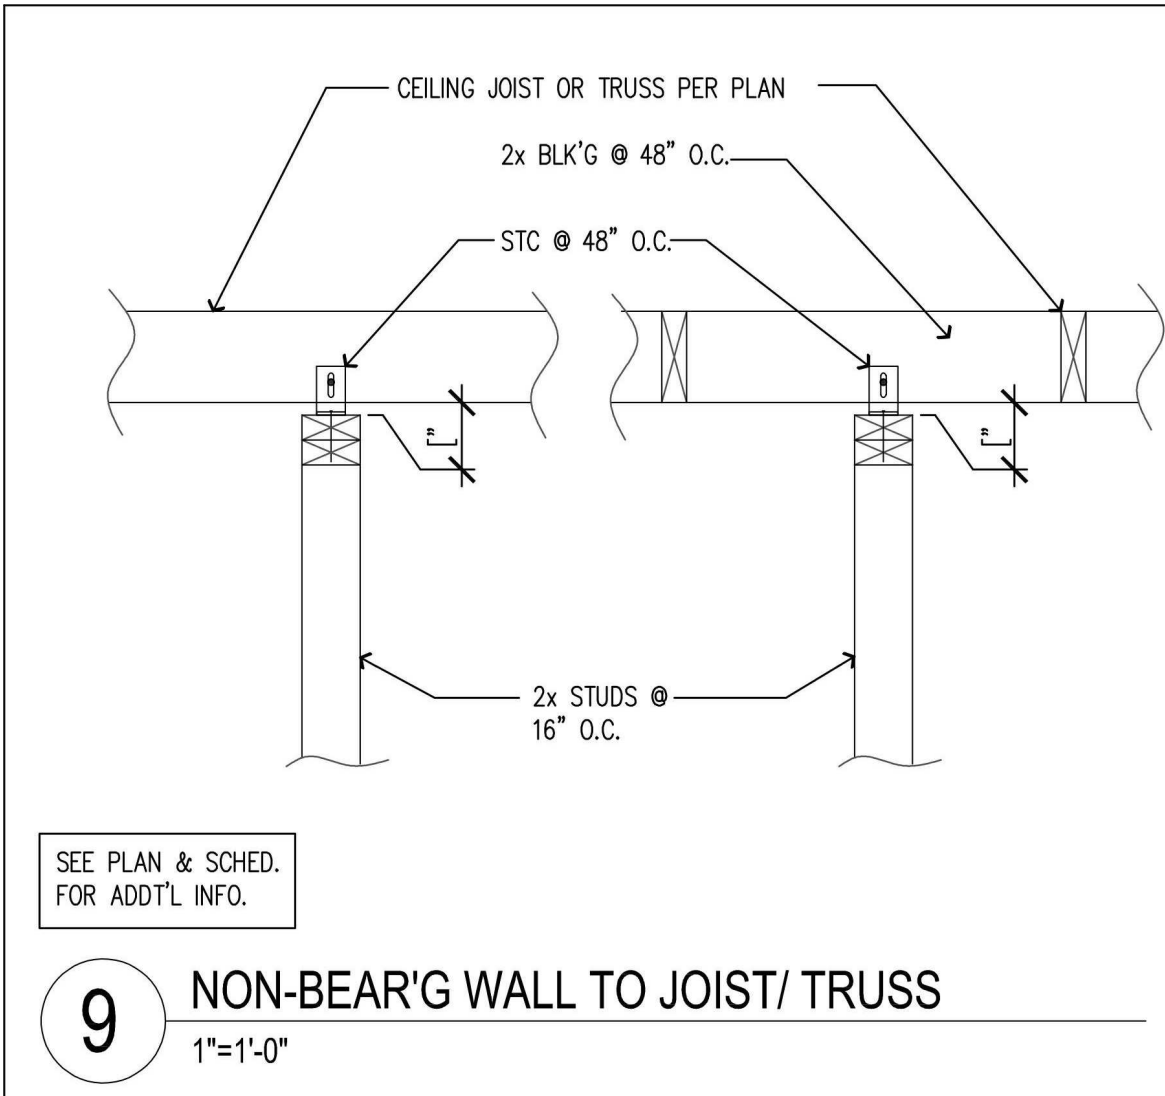


LUMBER GRADE DOUGLAS FIR LARCH NO. 2		ALLOWABLE SPANS	
FINISH OR SLOPE		CEILING JOISTS	
DEFLECTION		WITH PLASTER BELOW	WITH DRYWALL BELOW
LOAD DURATION FACTORS		1.00	1.00
NOMINAL SIZE (INCHES)	SPACING (INCHES)	DL = 7.5 PSF LL = 10 PSF	DL = 5 PSF LL = 10 PSF
2 X 4	12	10'-6"	10'-9"
	16	9'-7"	9'-7"
	24	8'-4"	8'-4"
	36	7'-0"	7'-0"
2 X 6	12	17'-9"	16'-9"
	16	16'-3"	15'-3"
	24	14'-6"	13'-3"
	36	12'-0"	11'-0"
2 X 8	12	N/A	N/A
	16	N/A	N/A
	24	N/A	N/A
	36	N/A	N/A
2 X 10	12	N/A	N/A
	16	N/A	N/A
	24	N/A	N/A
	36	N/A	N/A
2 X 12	12	N/A	N/A
	16	N/A	N/A
	24	N/A	N/A
	36	N/A	N/A
2 X 14	12	N/A	N/A
	16	N/A	N/A
	24	N/A	N/A
	36	N/A	N/A

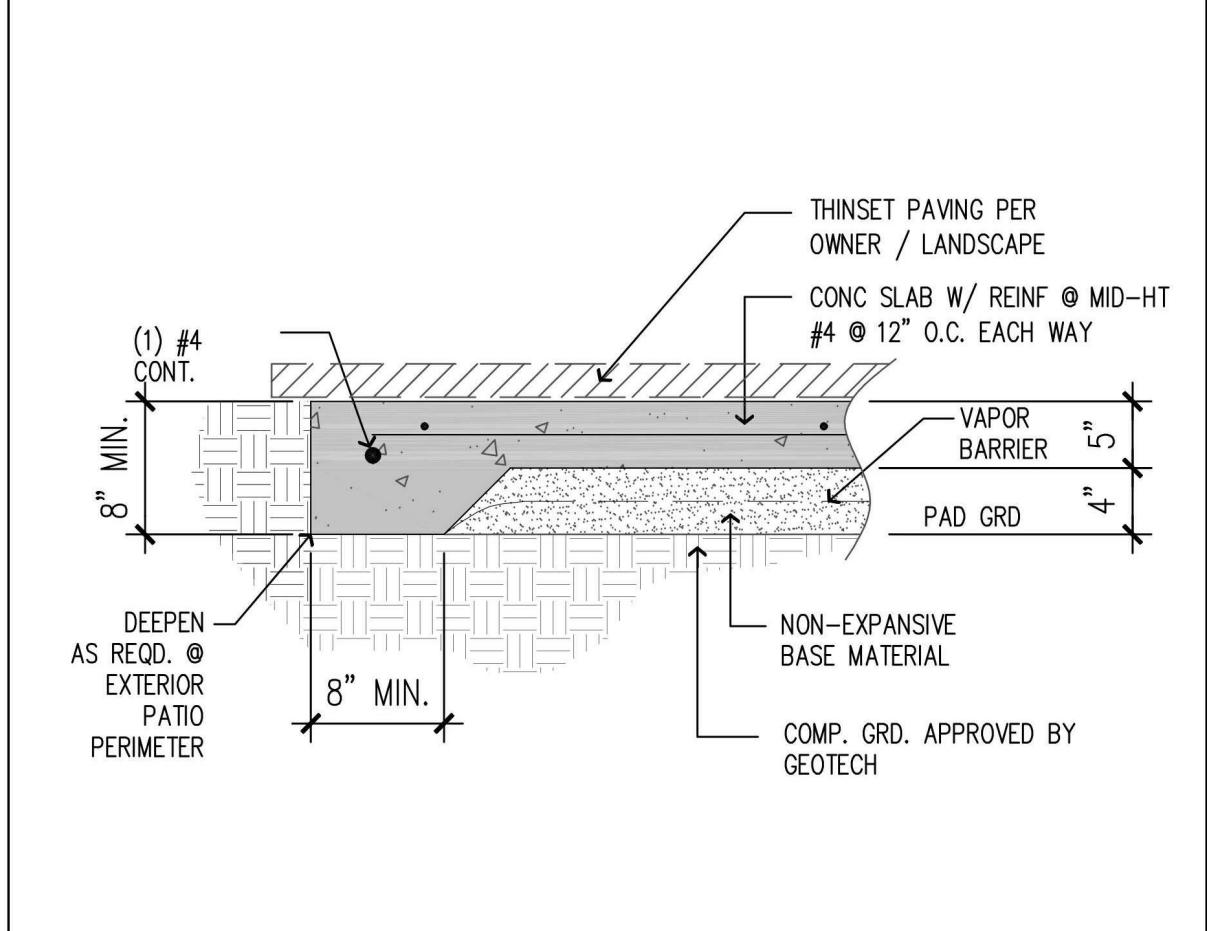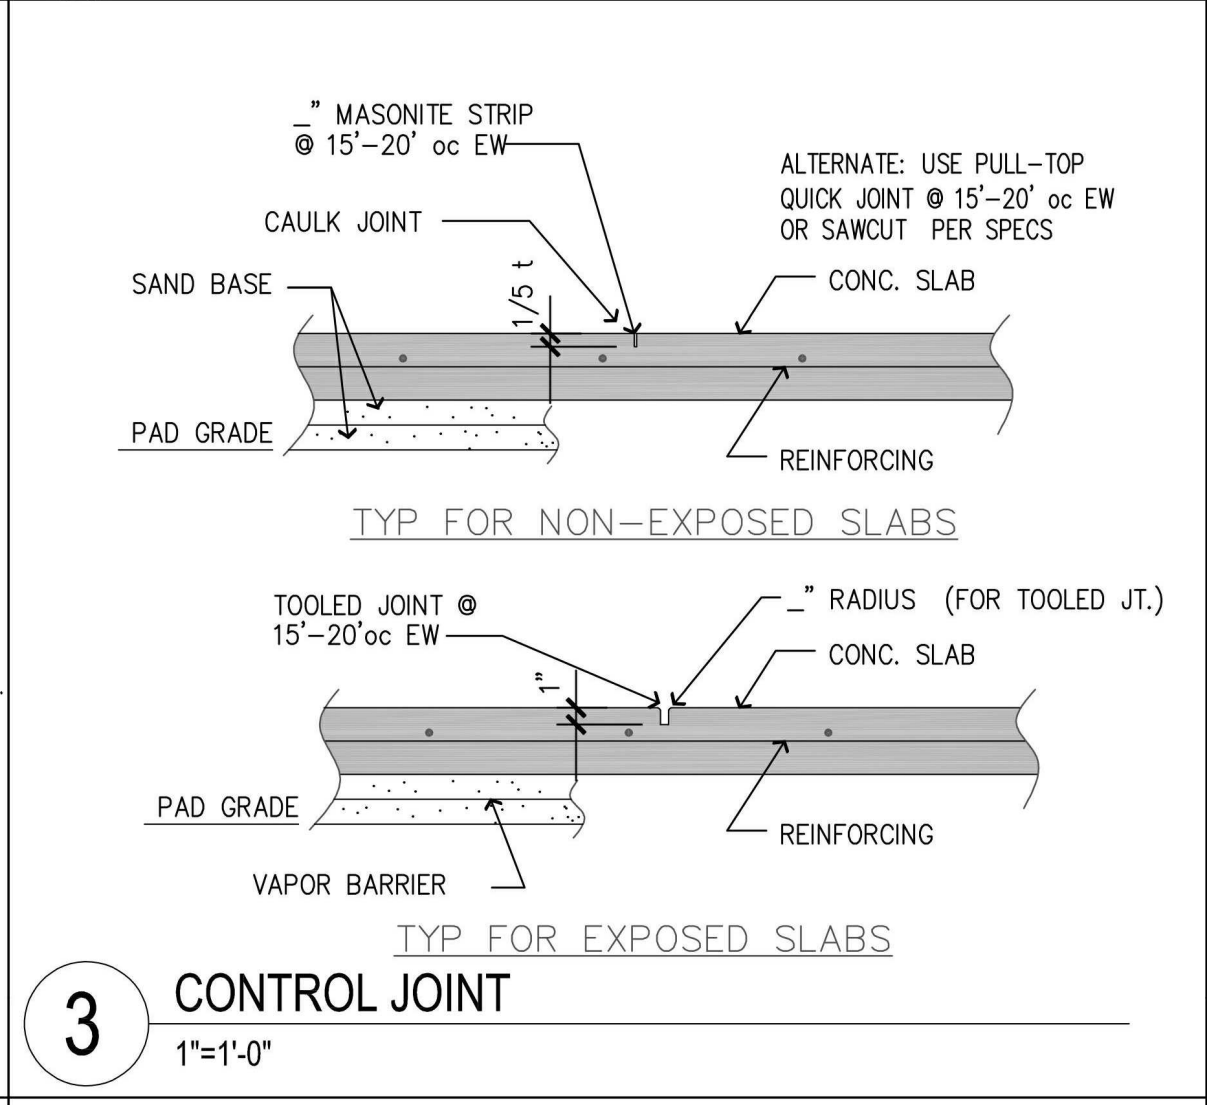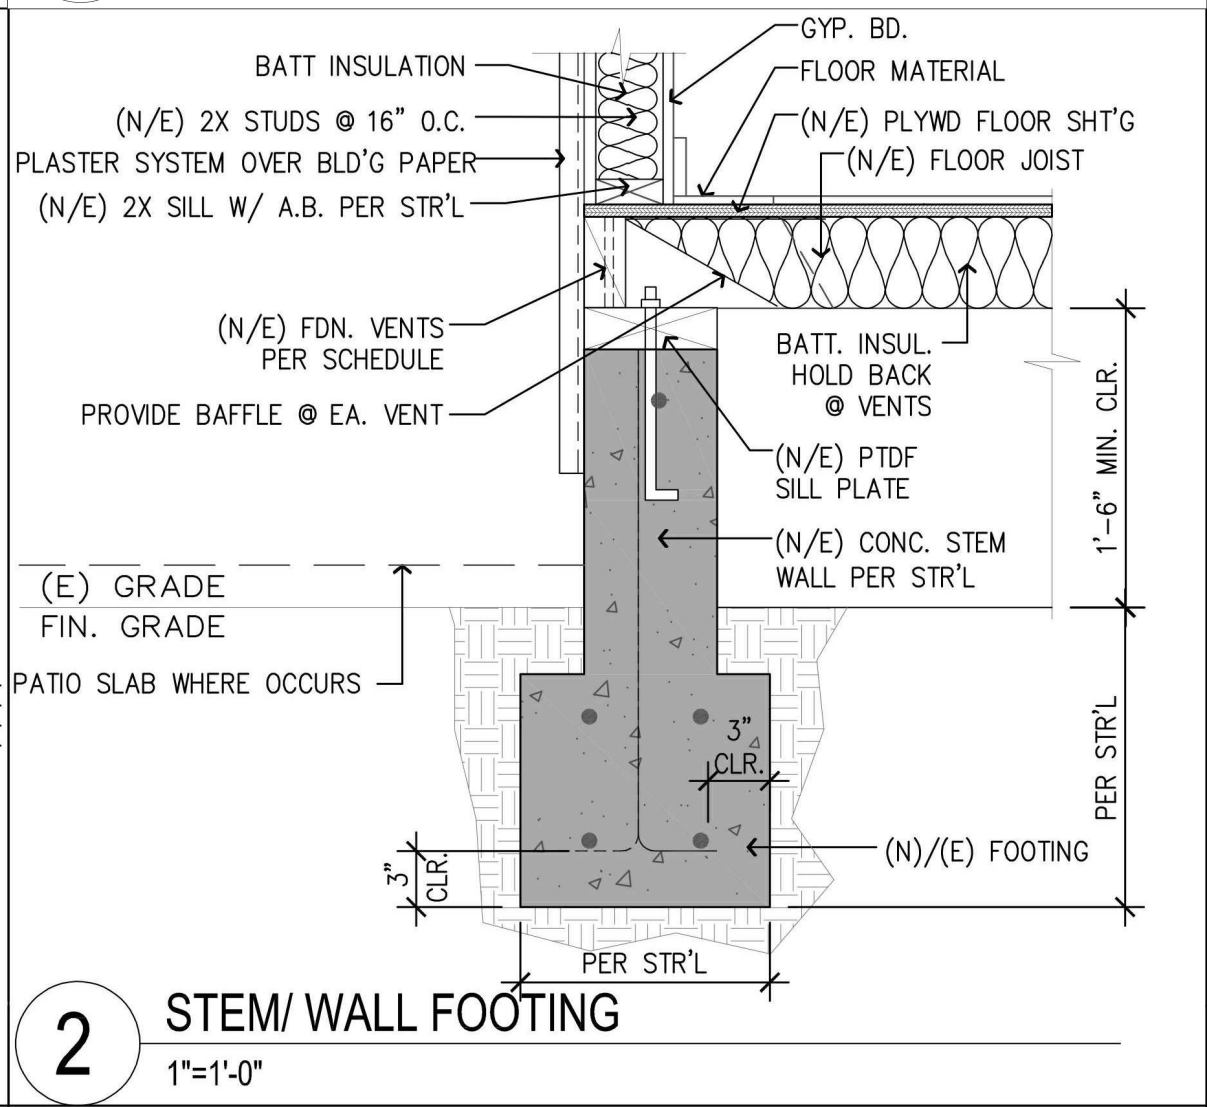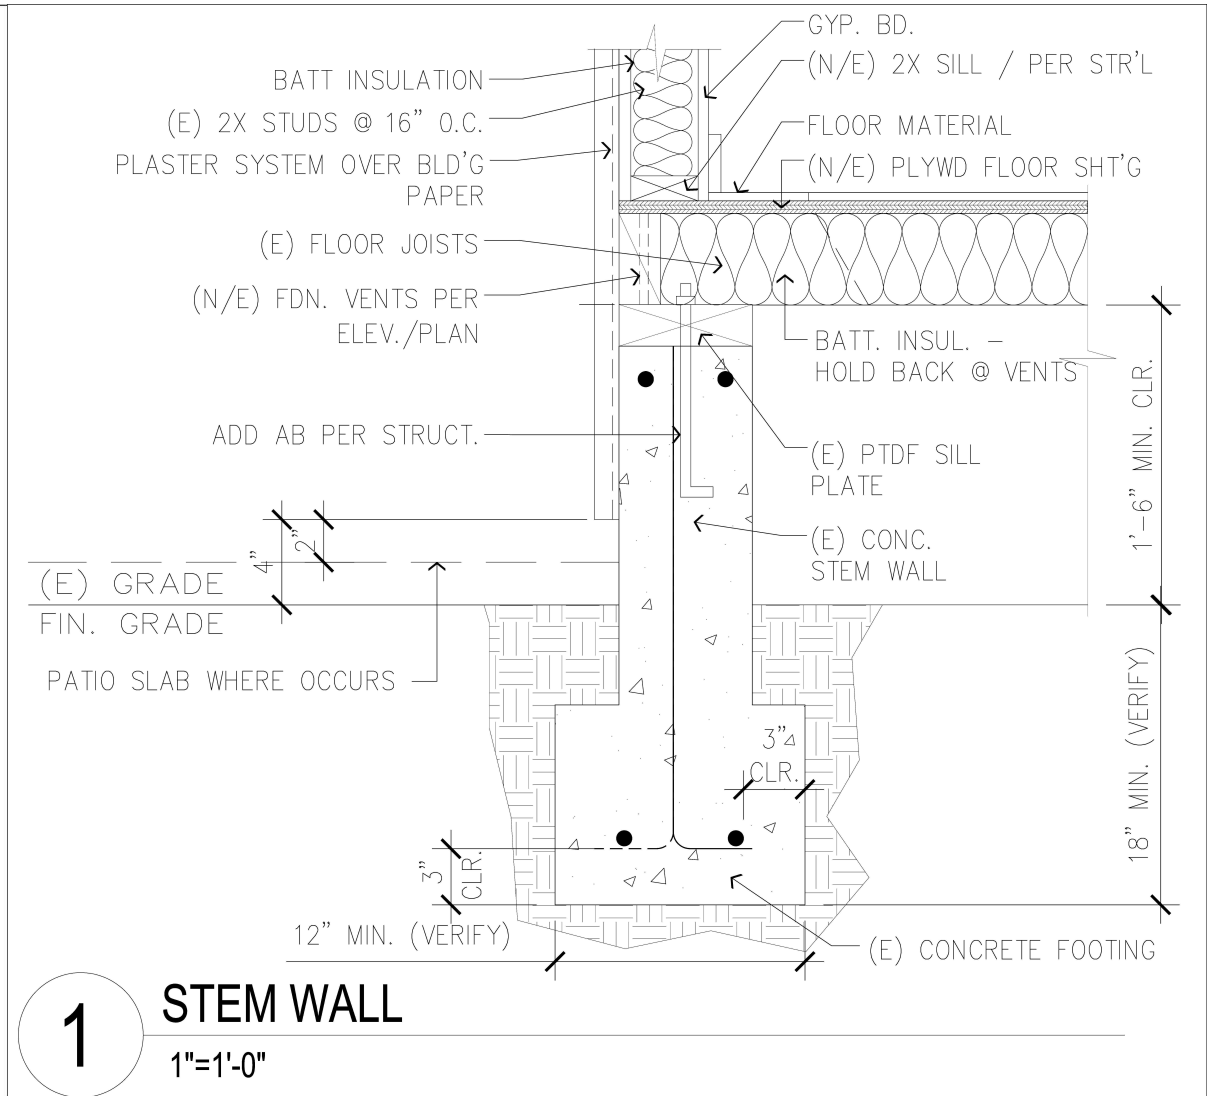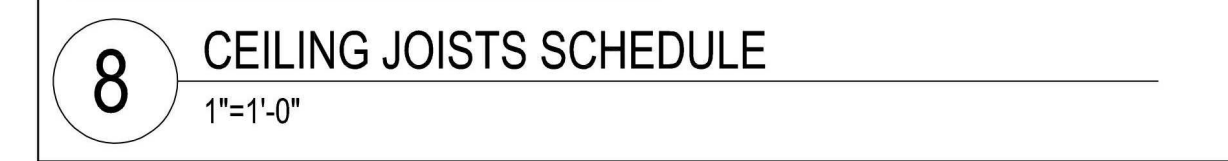




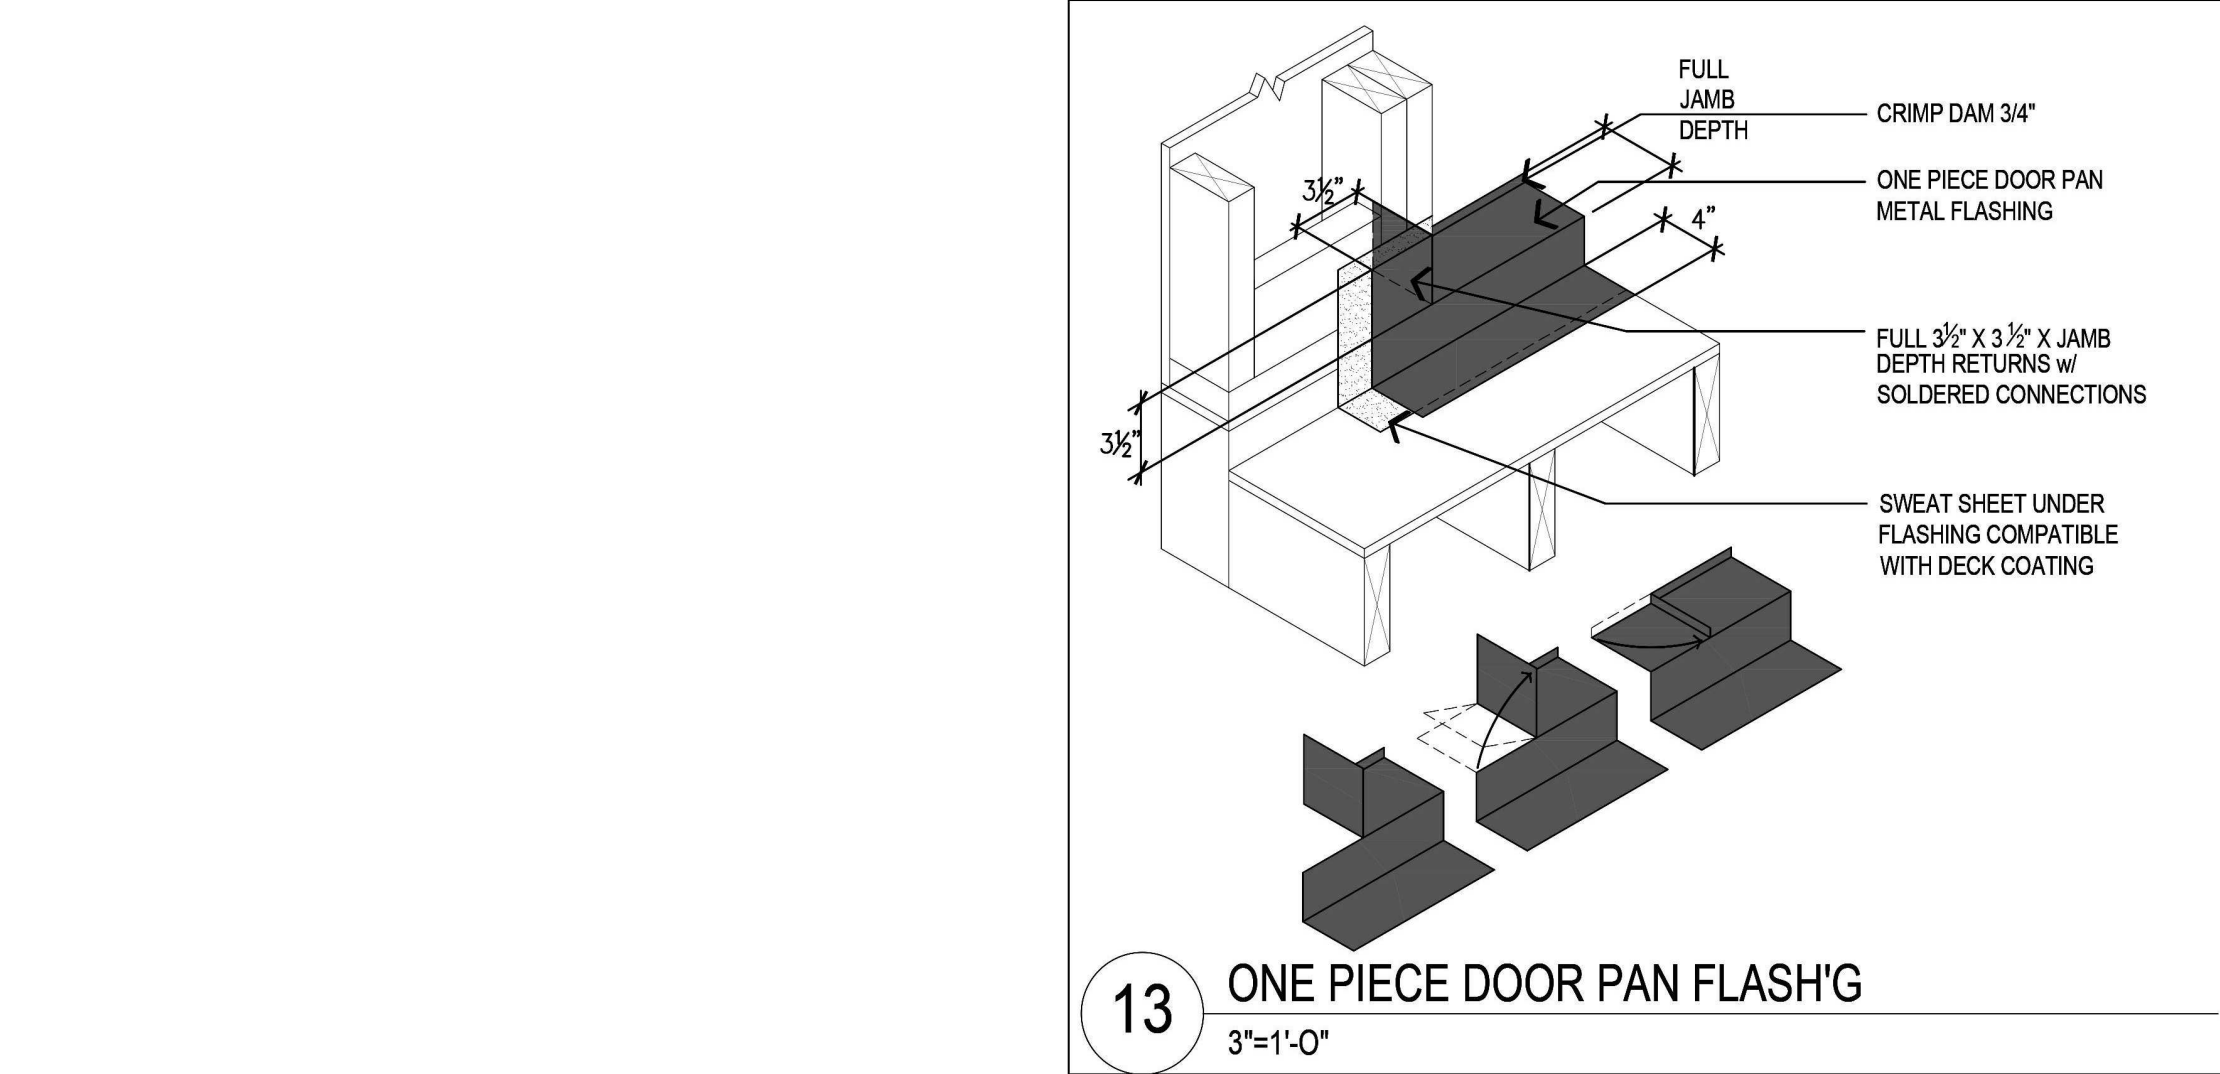


13 ONE PIECE DOOR PAN FLASH'G  
3"=1'-0"

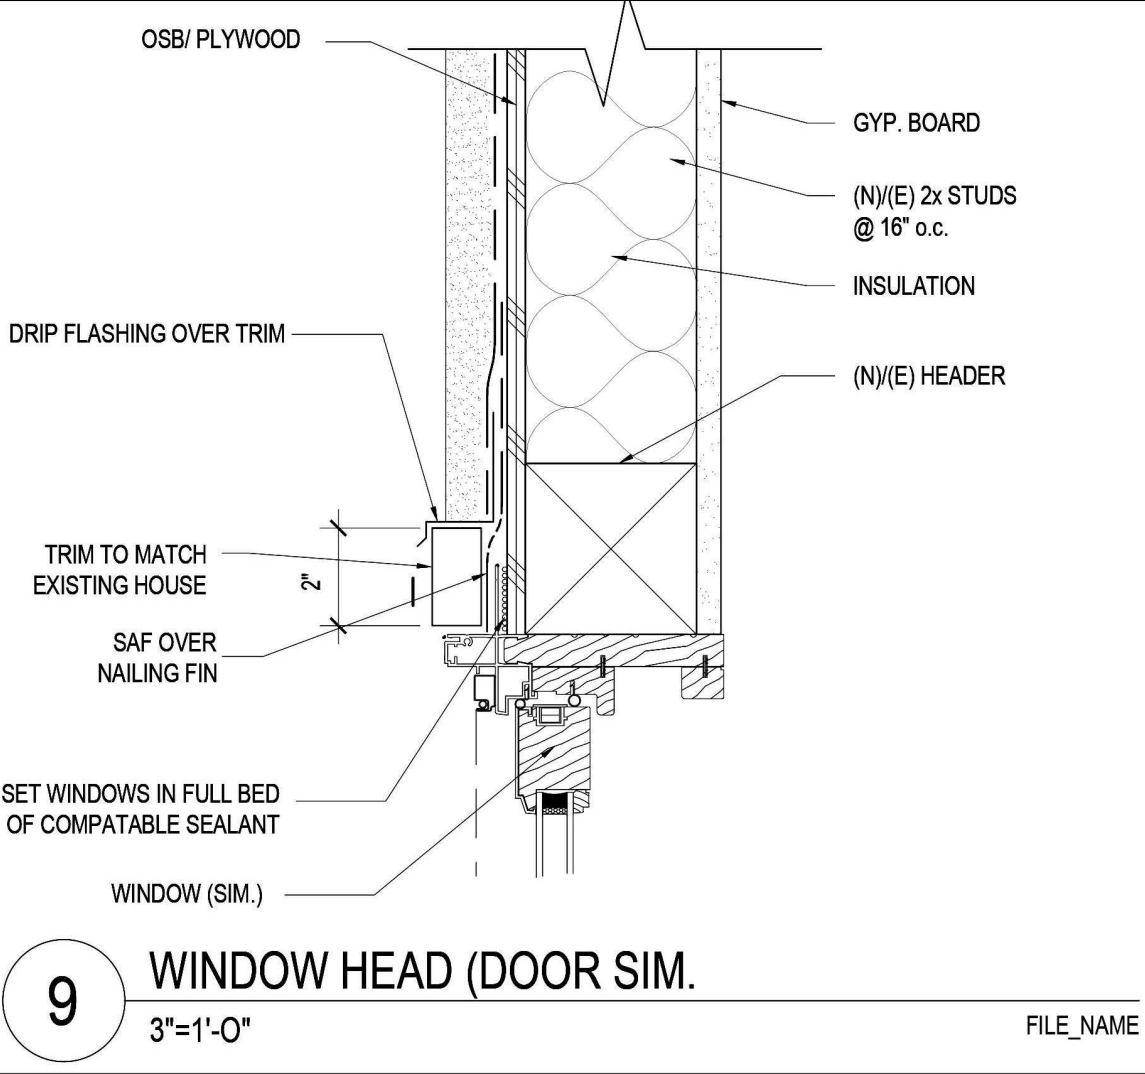


9 WINDOW HEAD (DOOR SIM.)  
3"=1'-0"

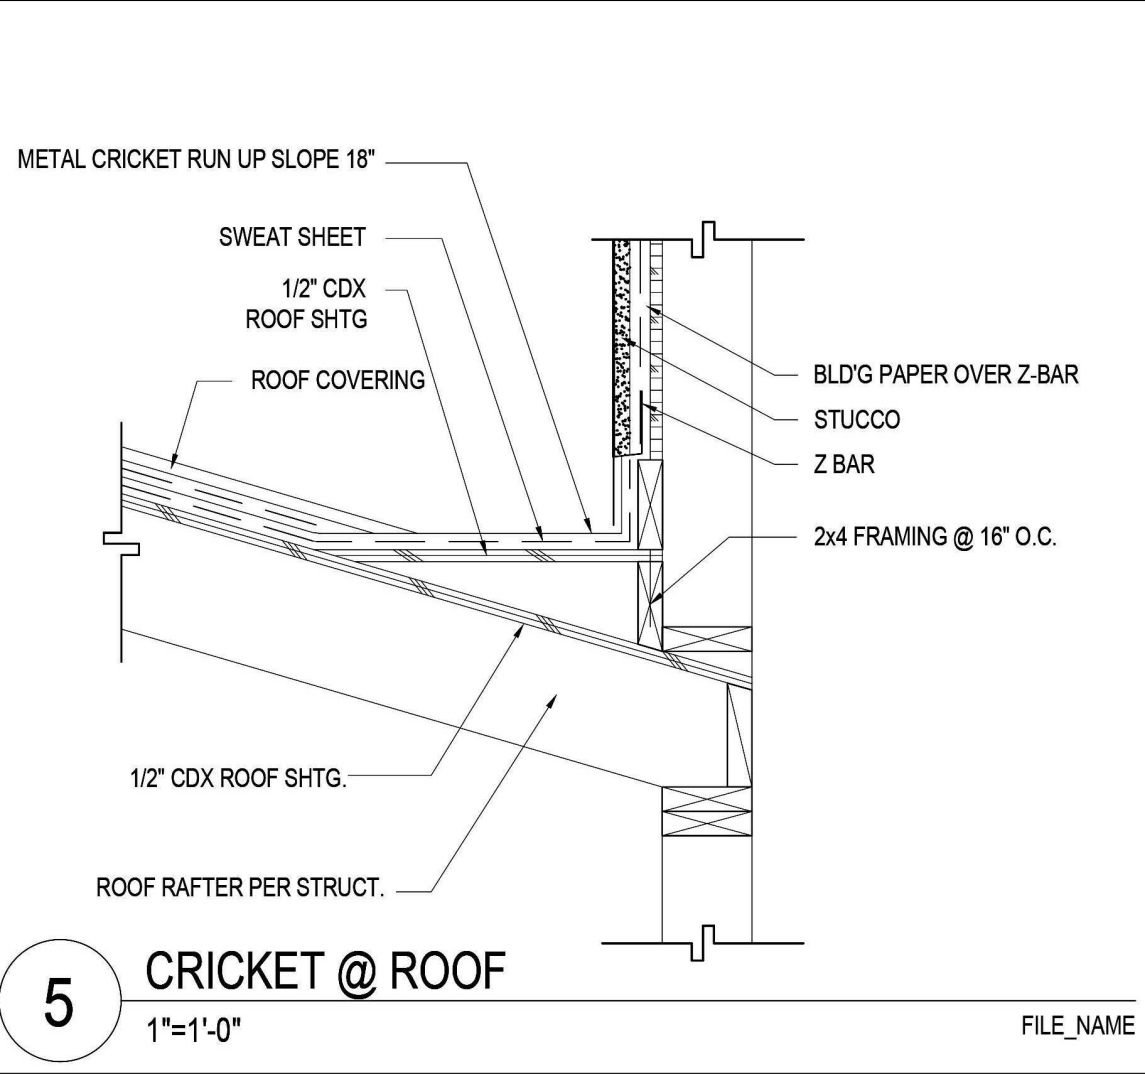


5 CRICKET @ ROOF  
1"=1'-0"

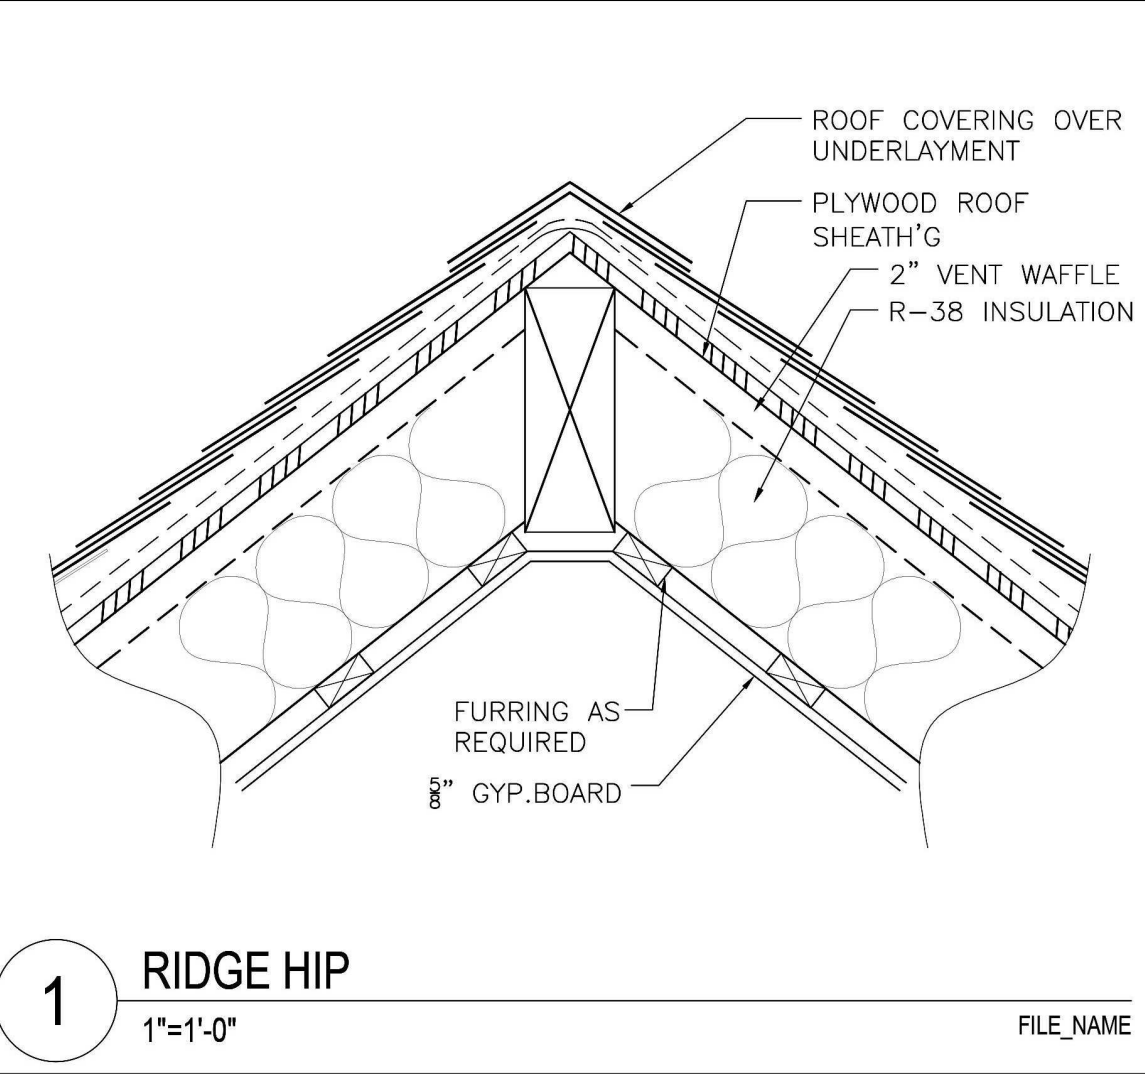


1 RIDGE HIP  
1"=1'-0"

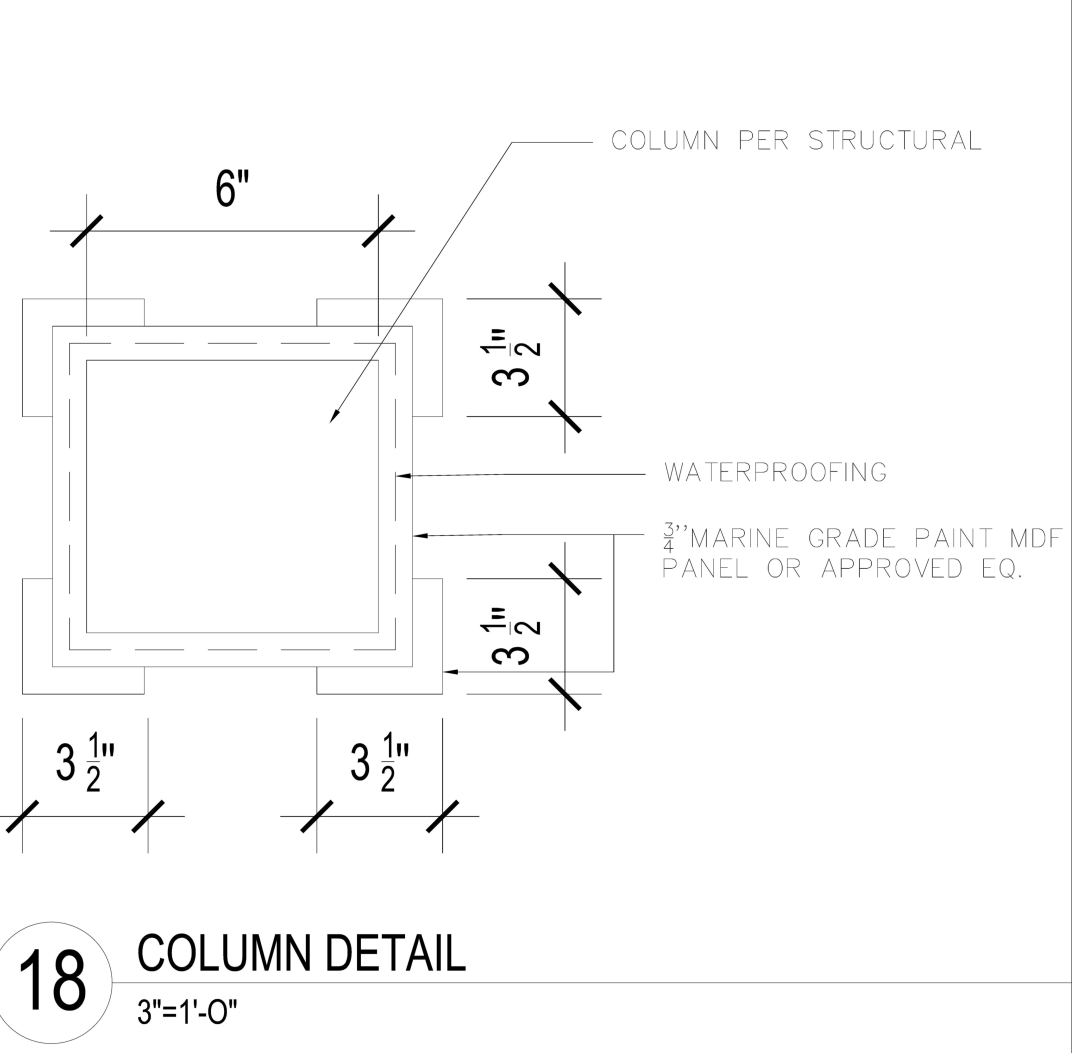


18 COLUMN DETAIL  
3"=1'-0"

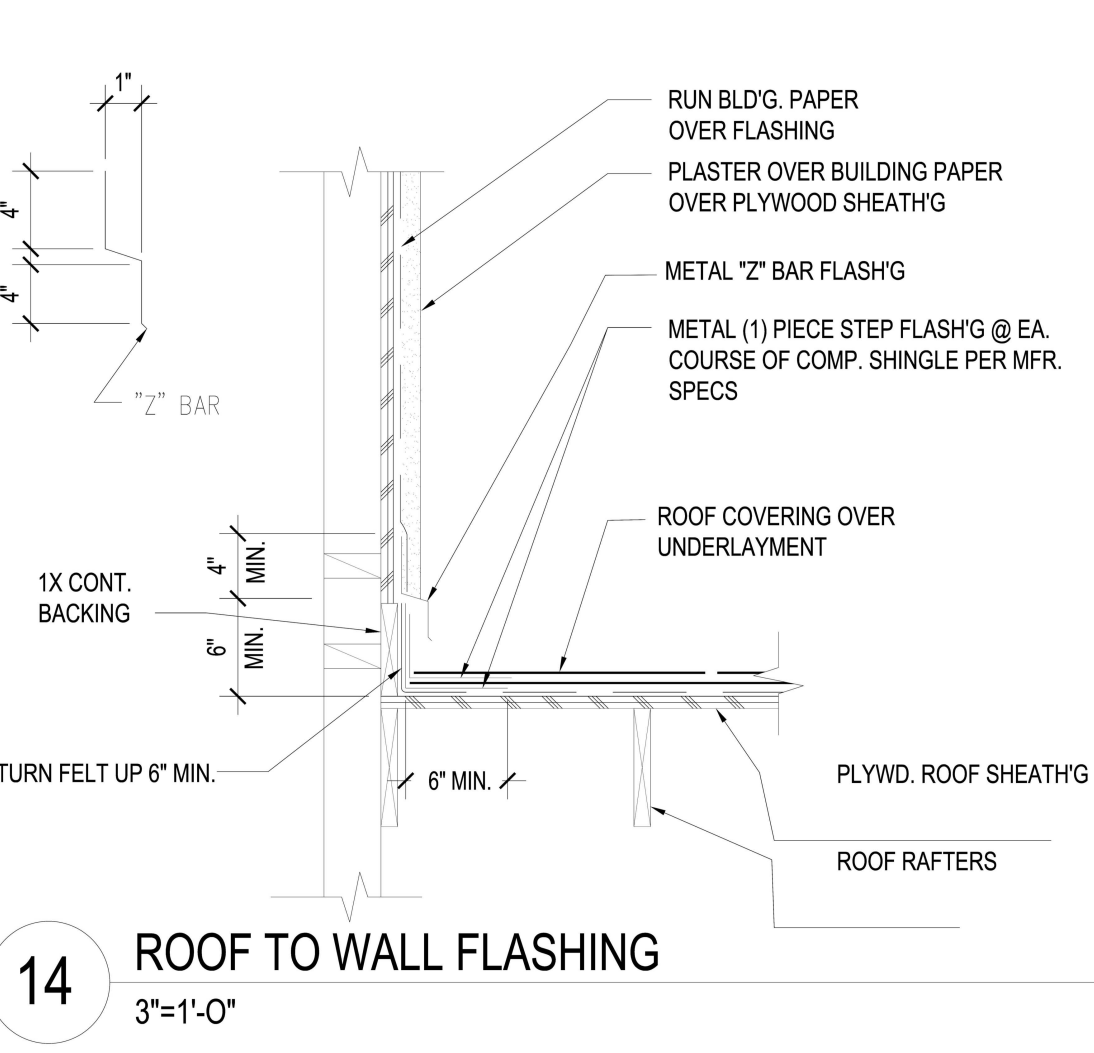


14 ROOF TO WALL FLASHING  
3"=1'-0"

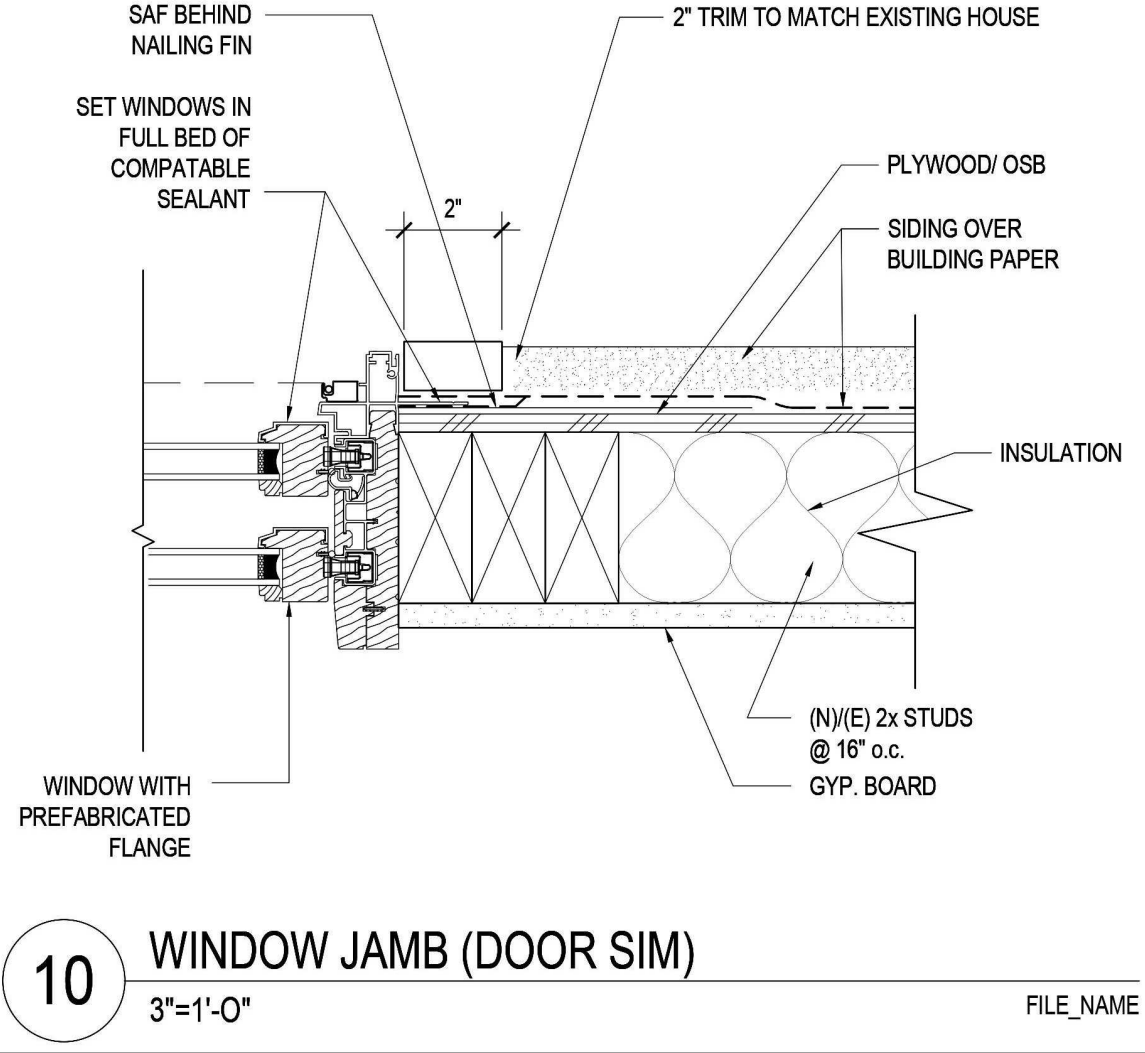


10 WINDOW JAMB (DOOR SIM.)  
3"=1'-0"

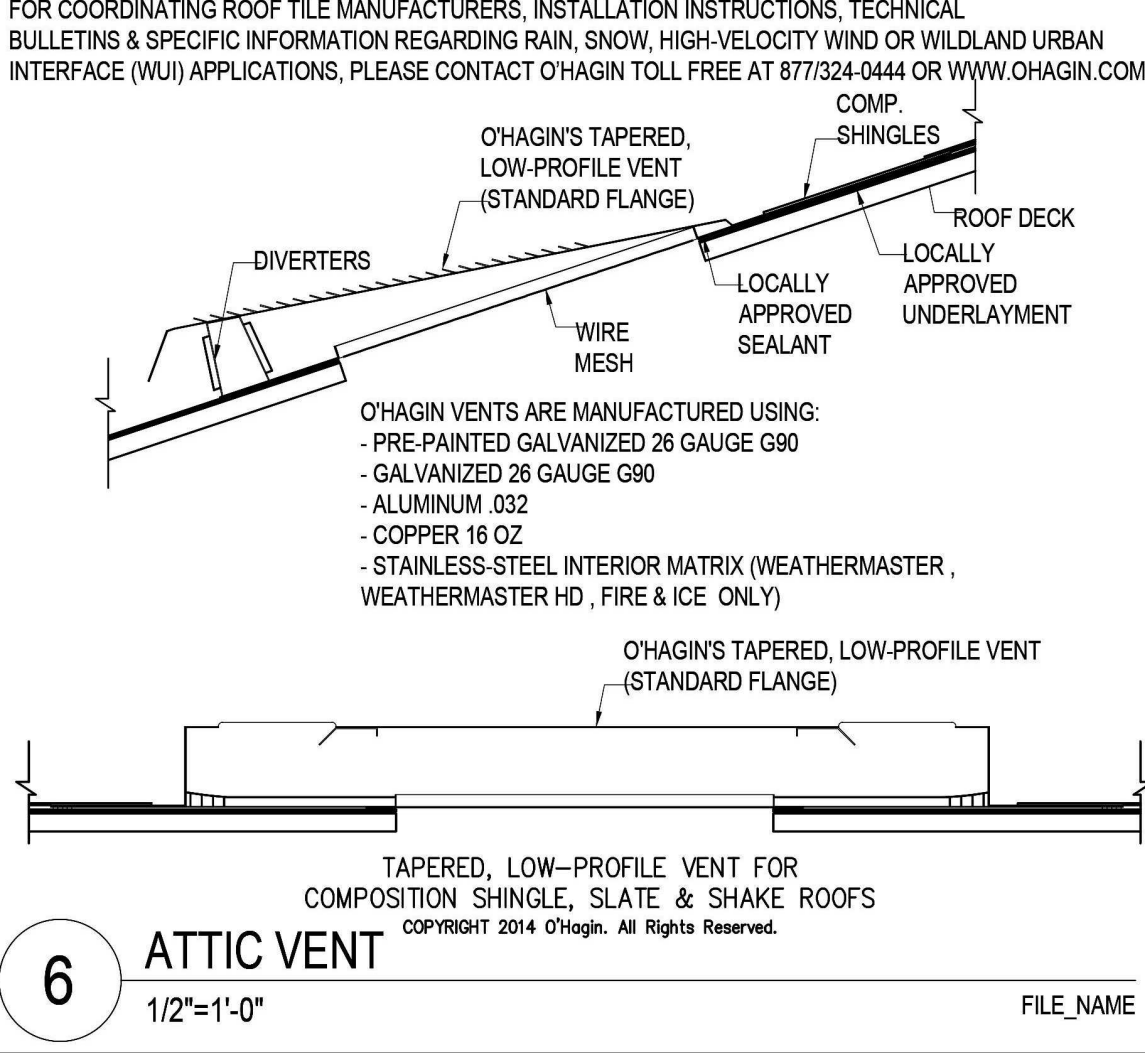


6 ATTIC VENT  
1/2"=1'-0"

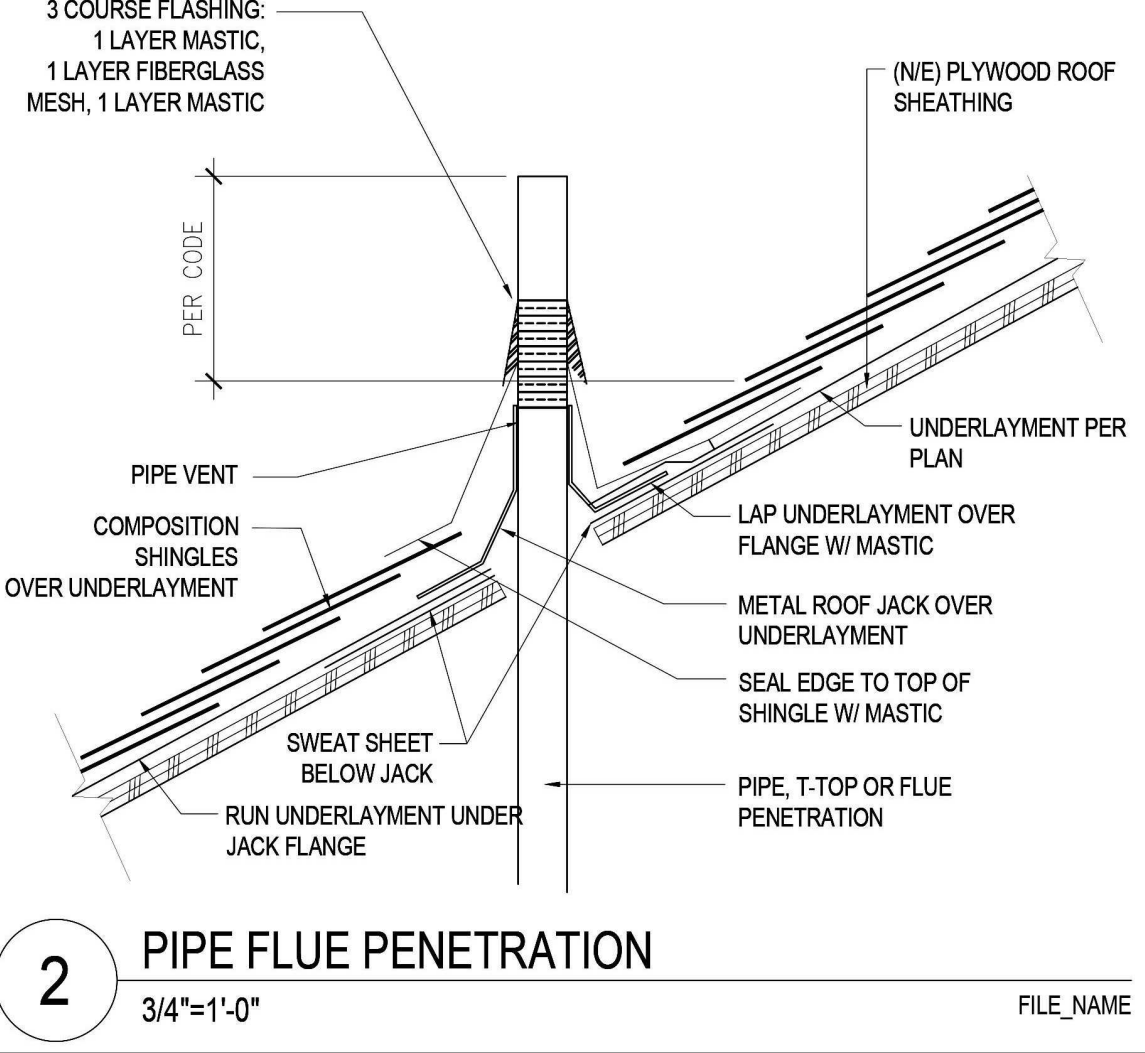


2 PIPE FLUE PENETRATION  
3/4"=1'-0"

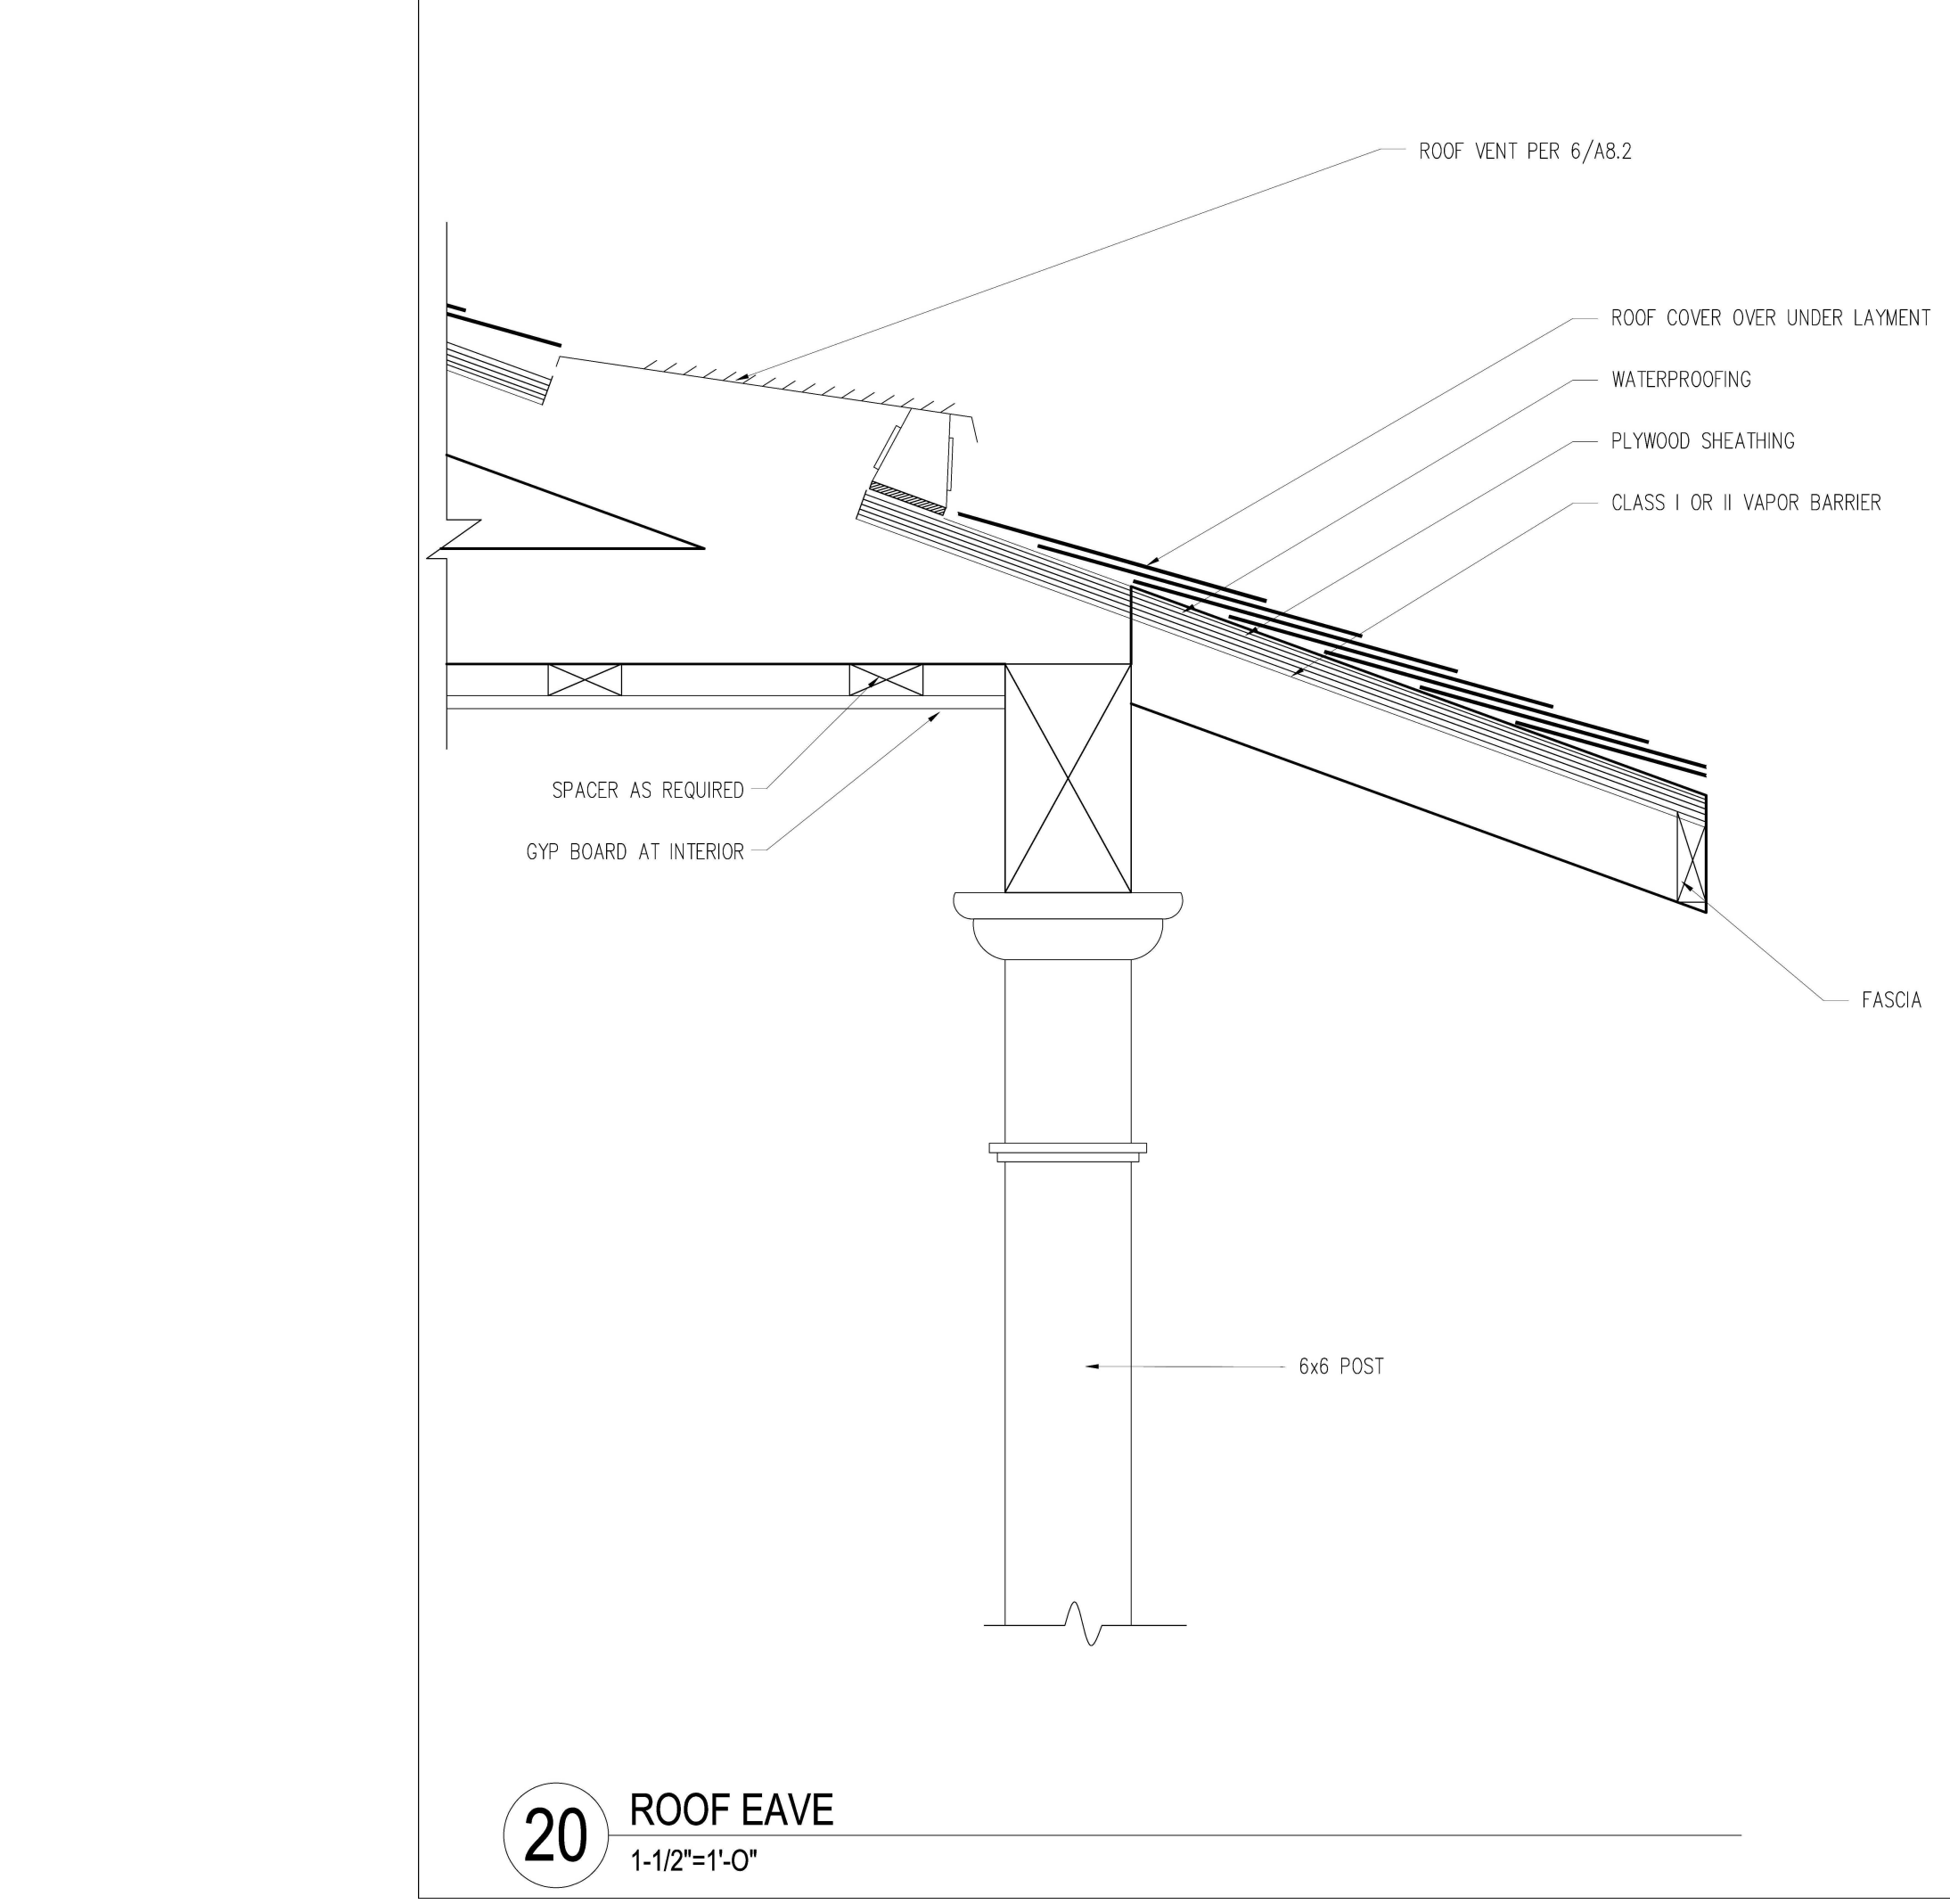


20 ROOF EAVE  
1-1/2"=1'-0"

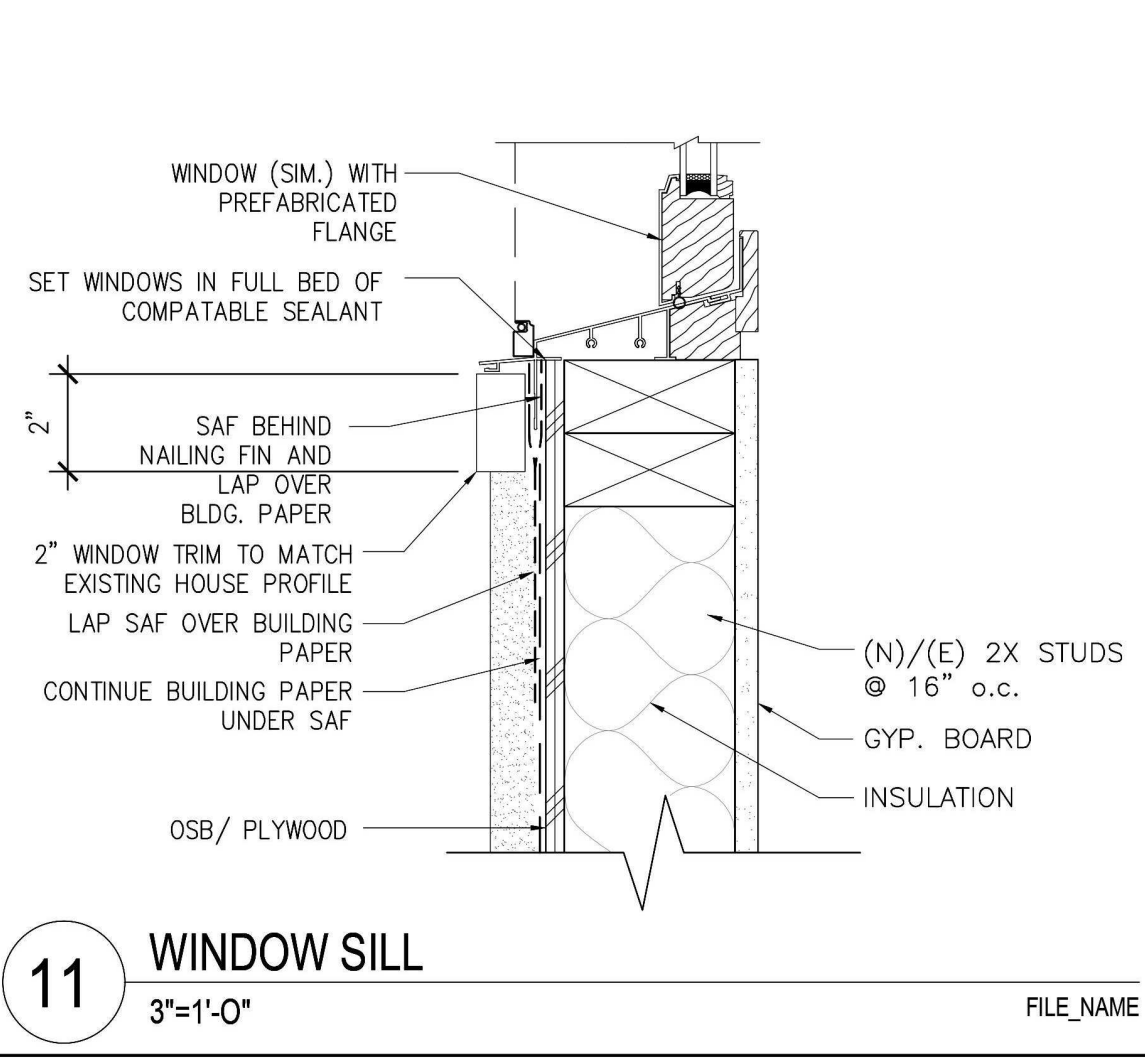

11 WINDOW SILL  
3"=1'-0"

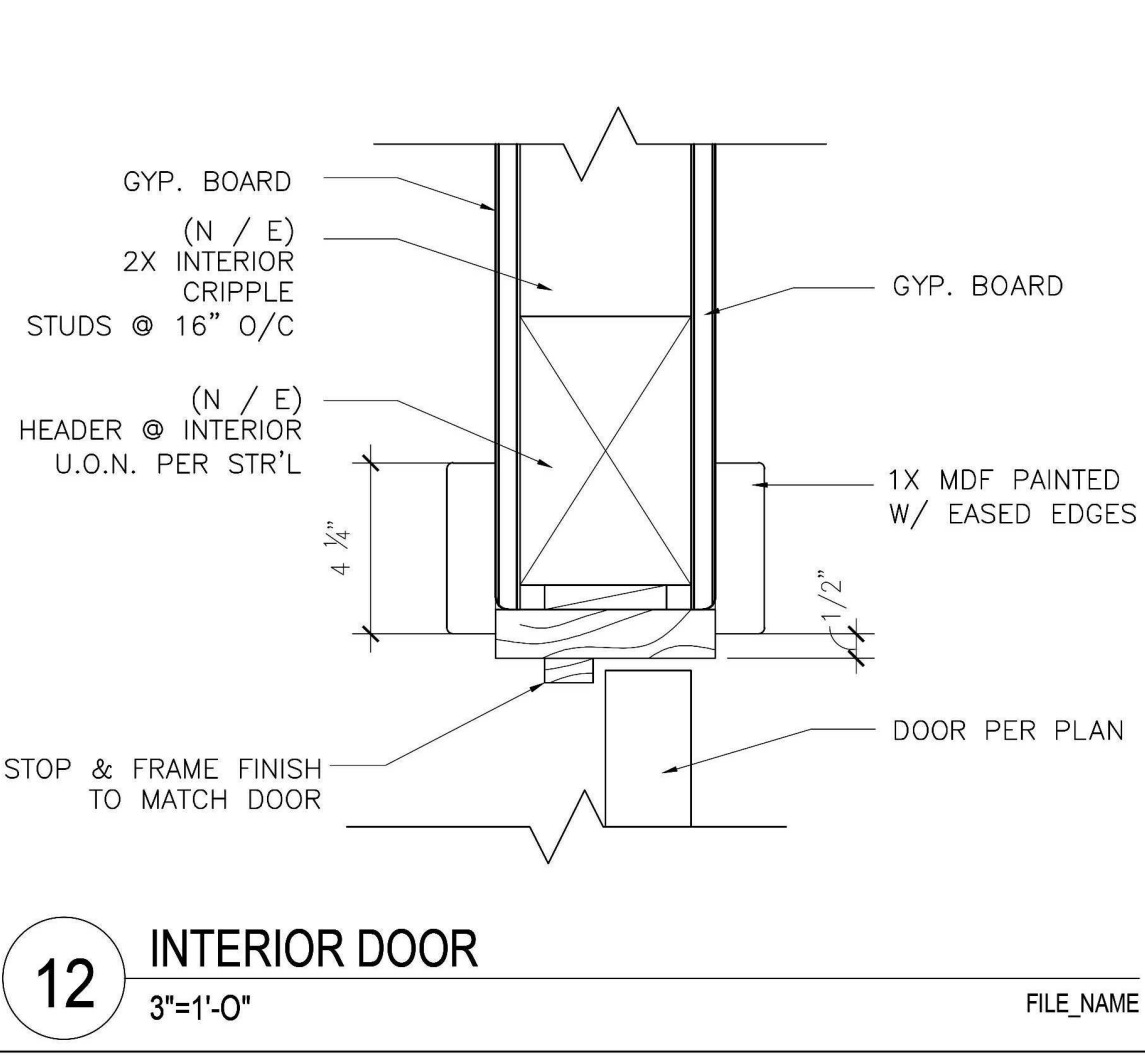

12 INTERIOR DOOR  
3"=1'-0"

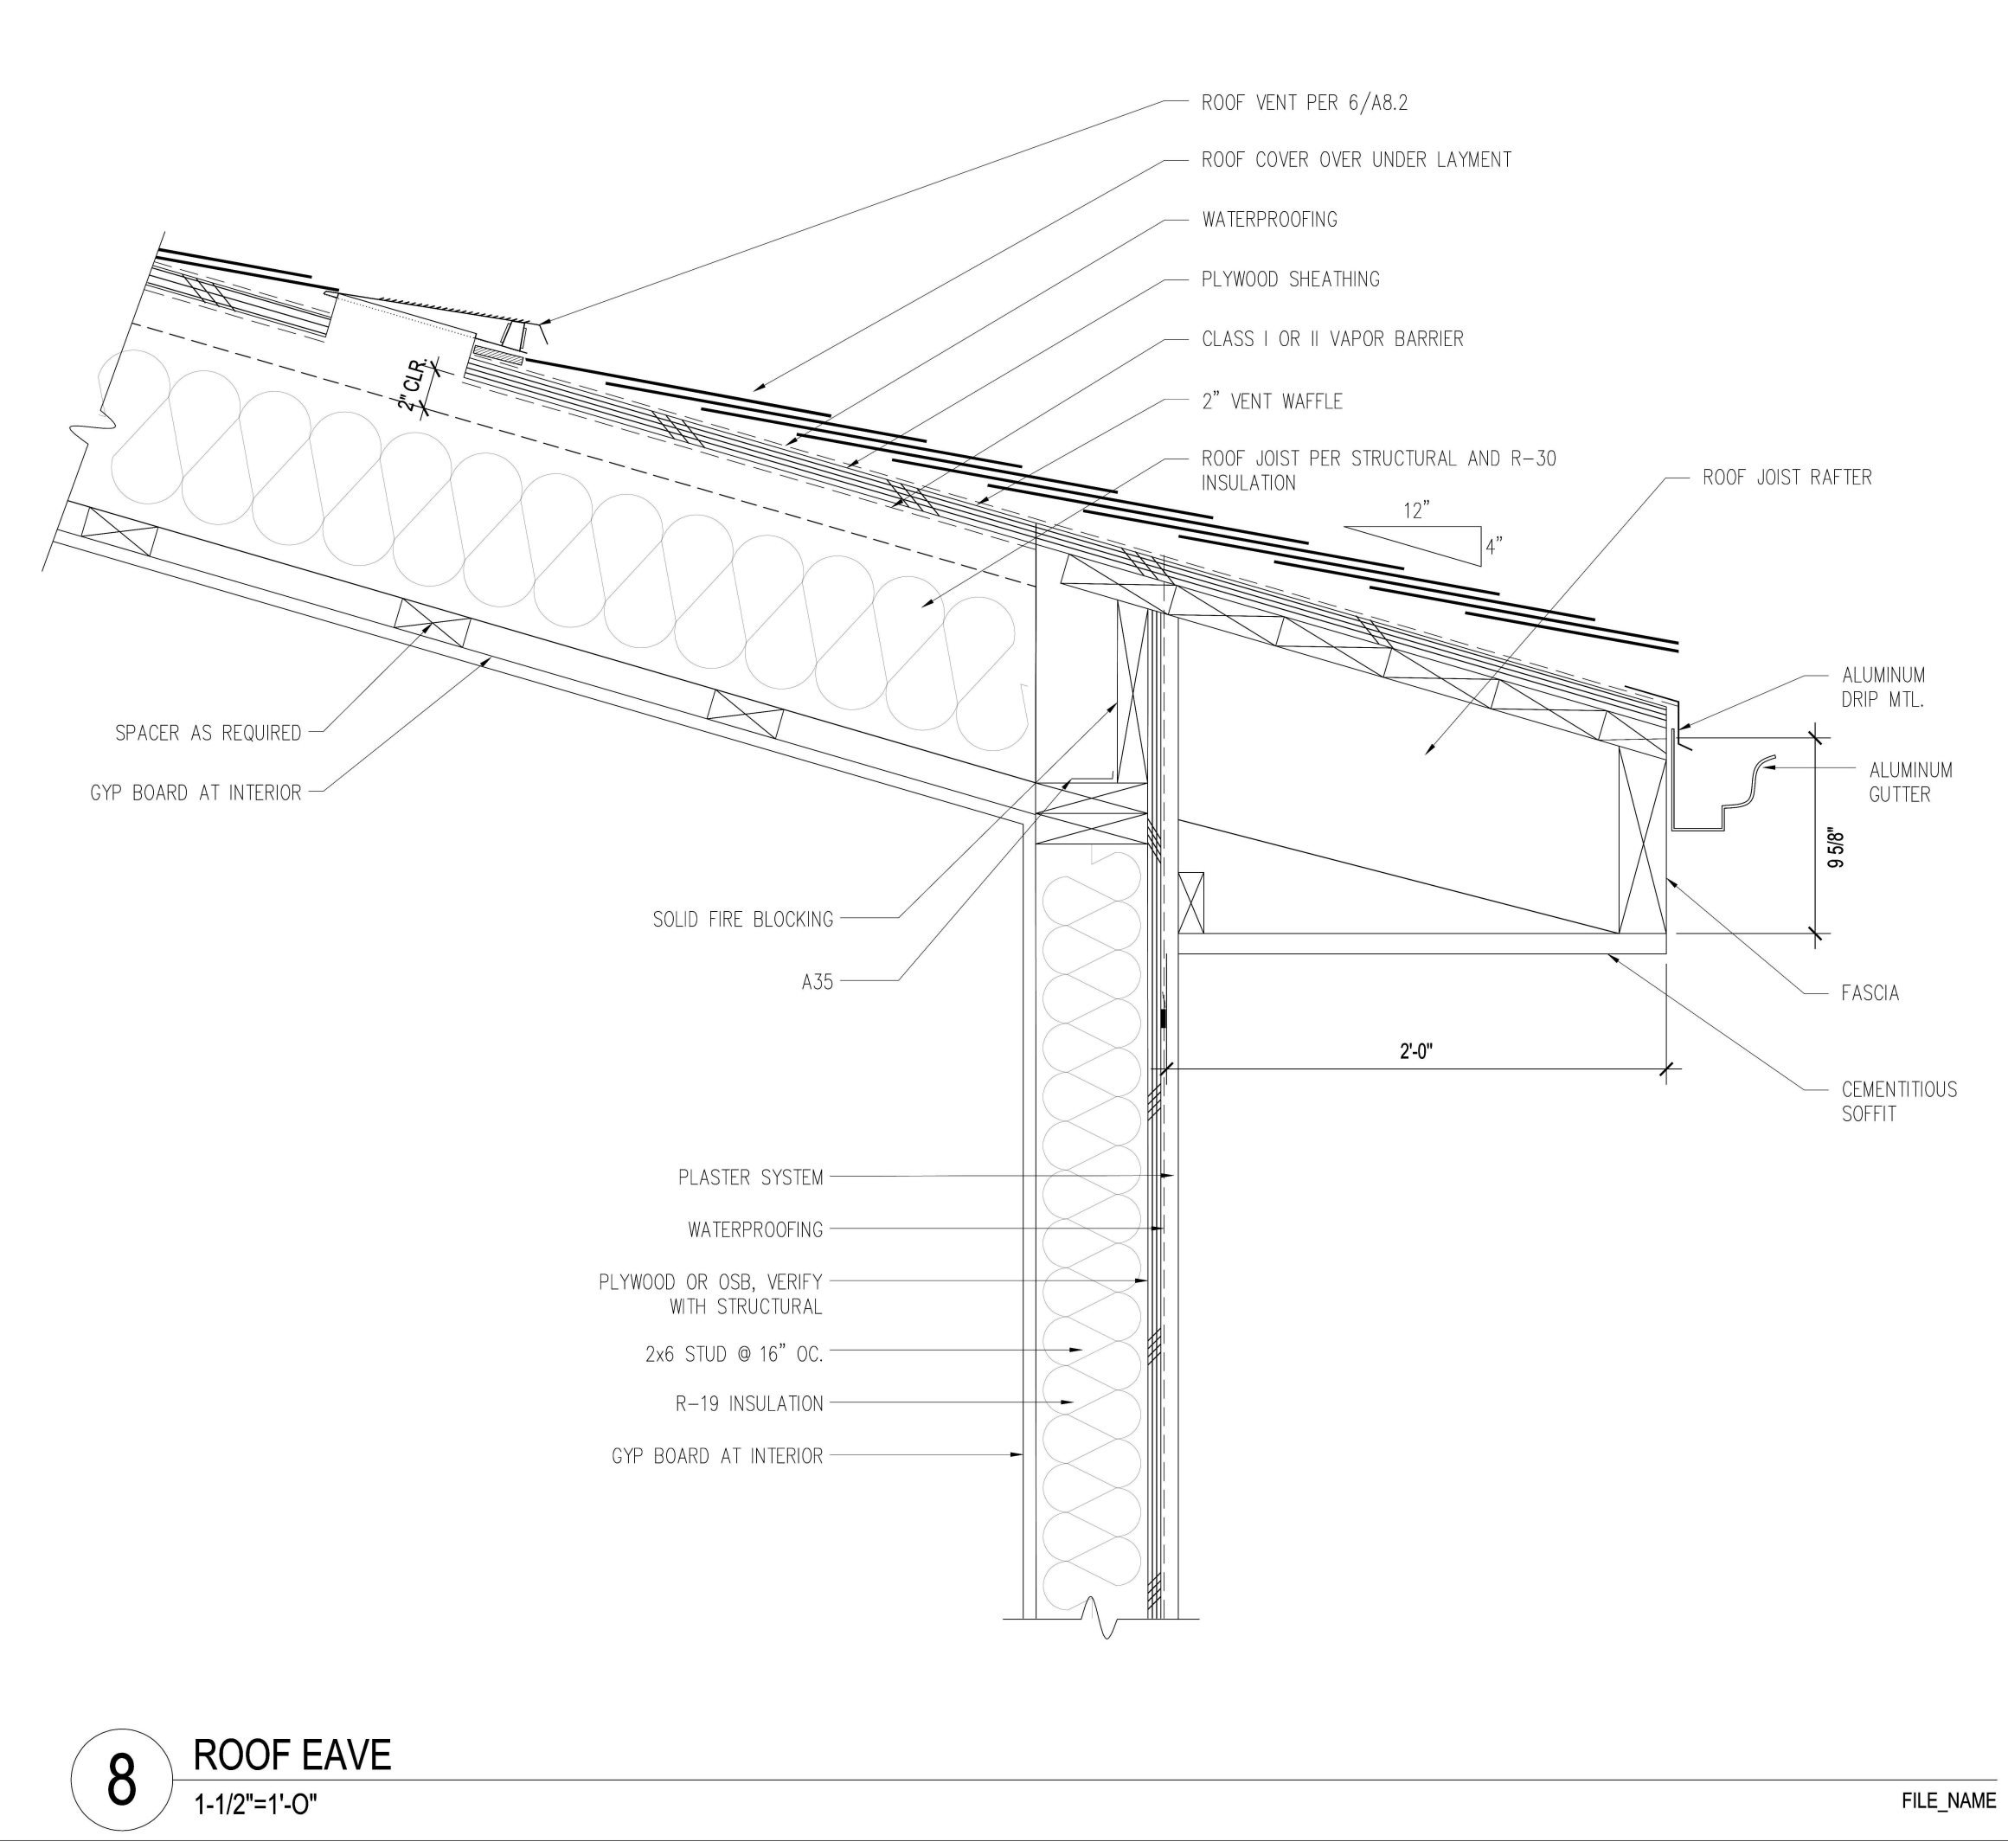


8 ROOF EAVE  
1-1/2"=1'-0"


No.	DELTA DESCRIPTION:	
	DATE:	CITY SUBMITTAL
1	22/09/17	
2		
3		
4		
5		

DATE: 22/09/17  
SCALE: 3" = 1'-0"  
DRAWN BY :  
CKD BY:  
PROJECT : 202107199




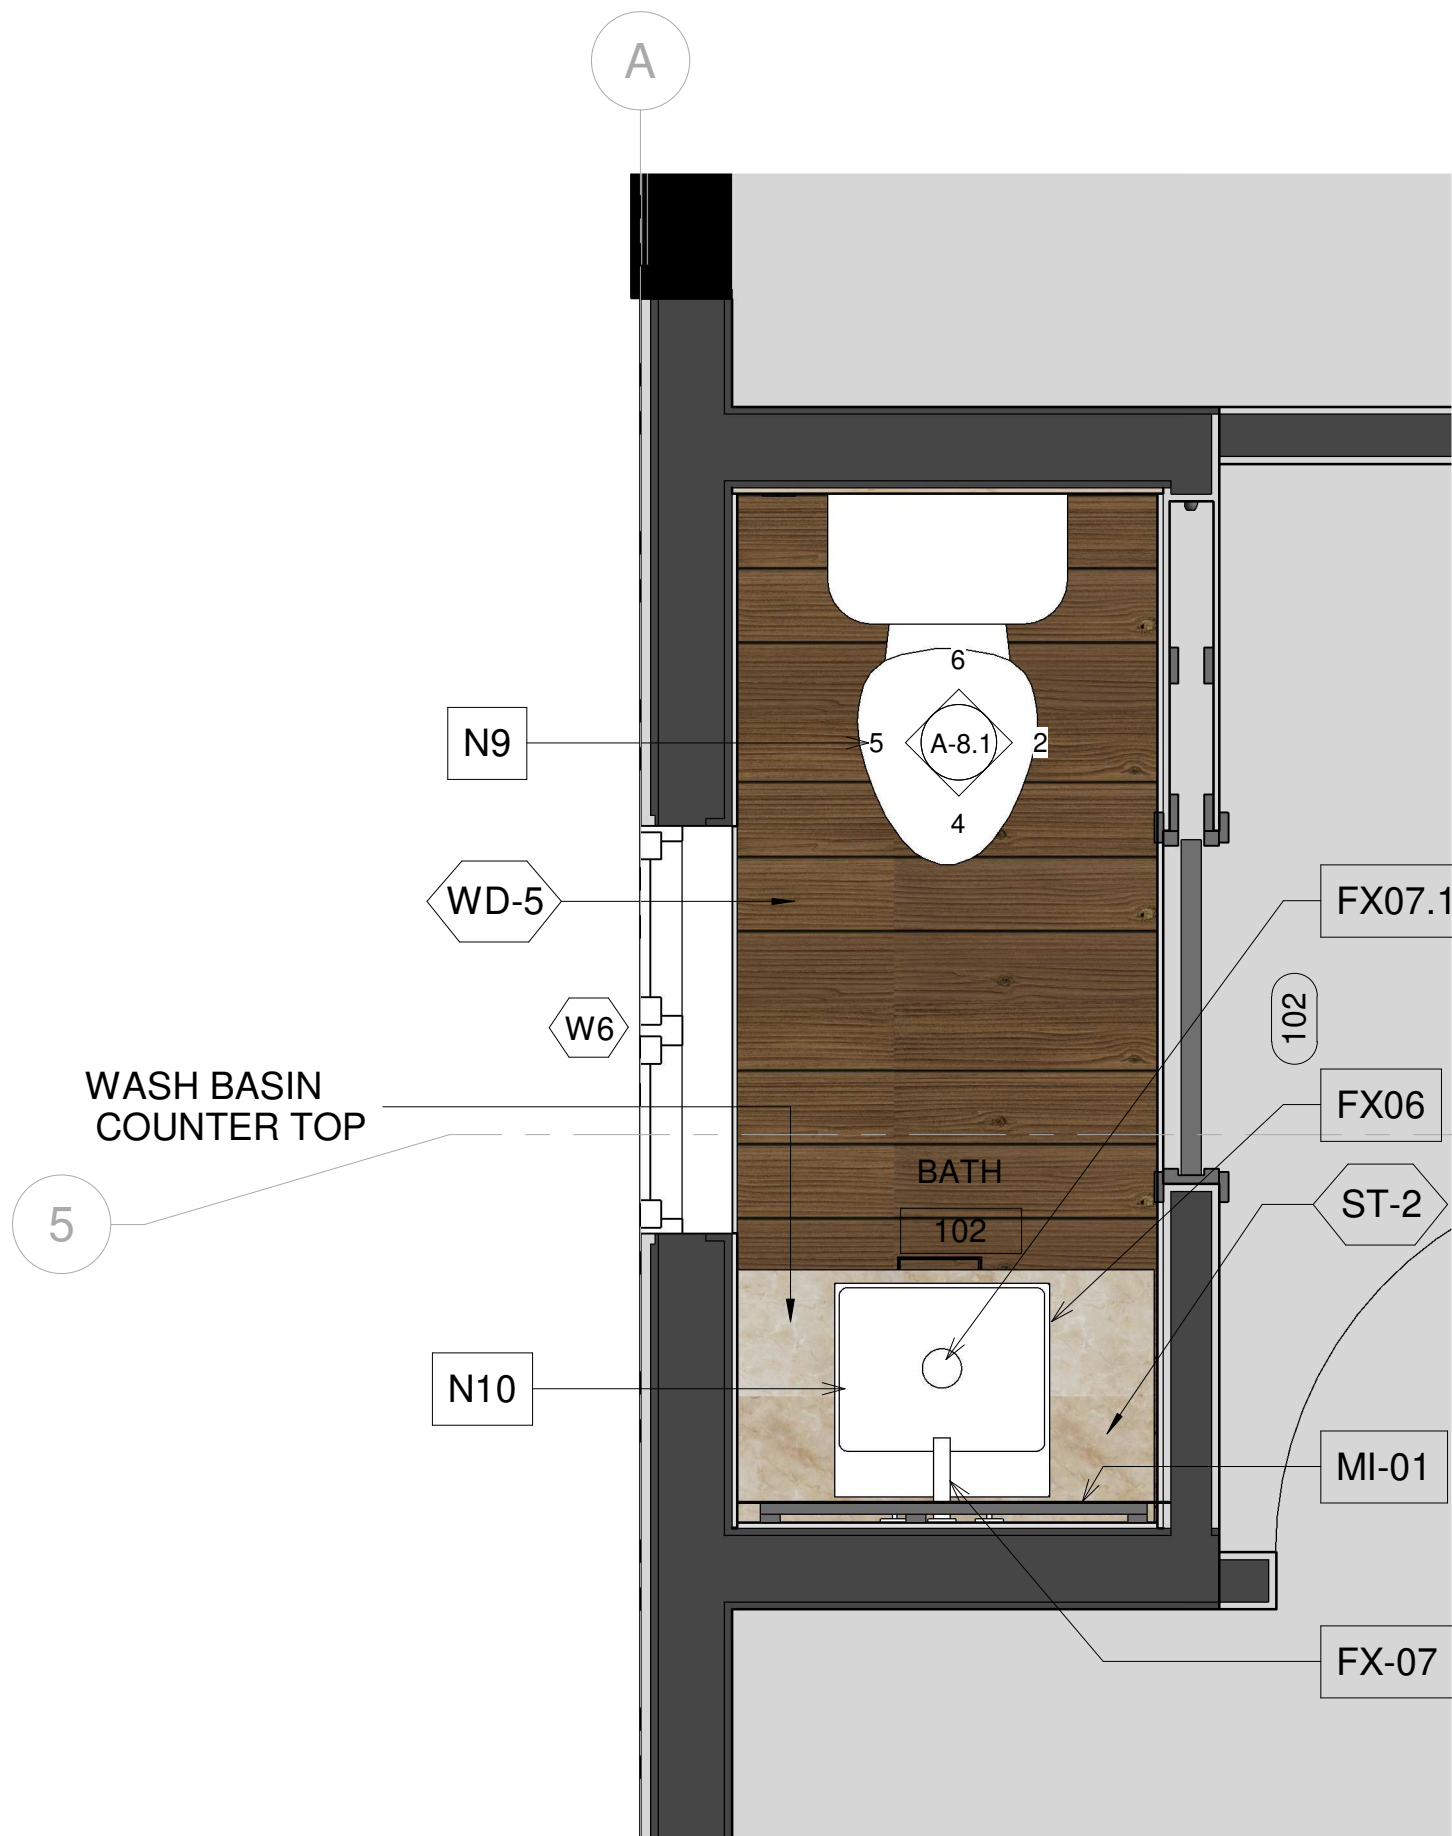


1 BATH 102 ENLARGED PLAN  
3/4" = 1'-0"

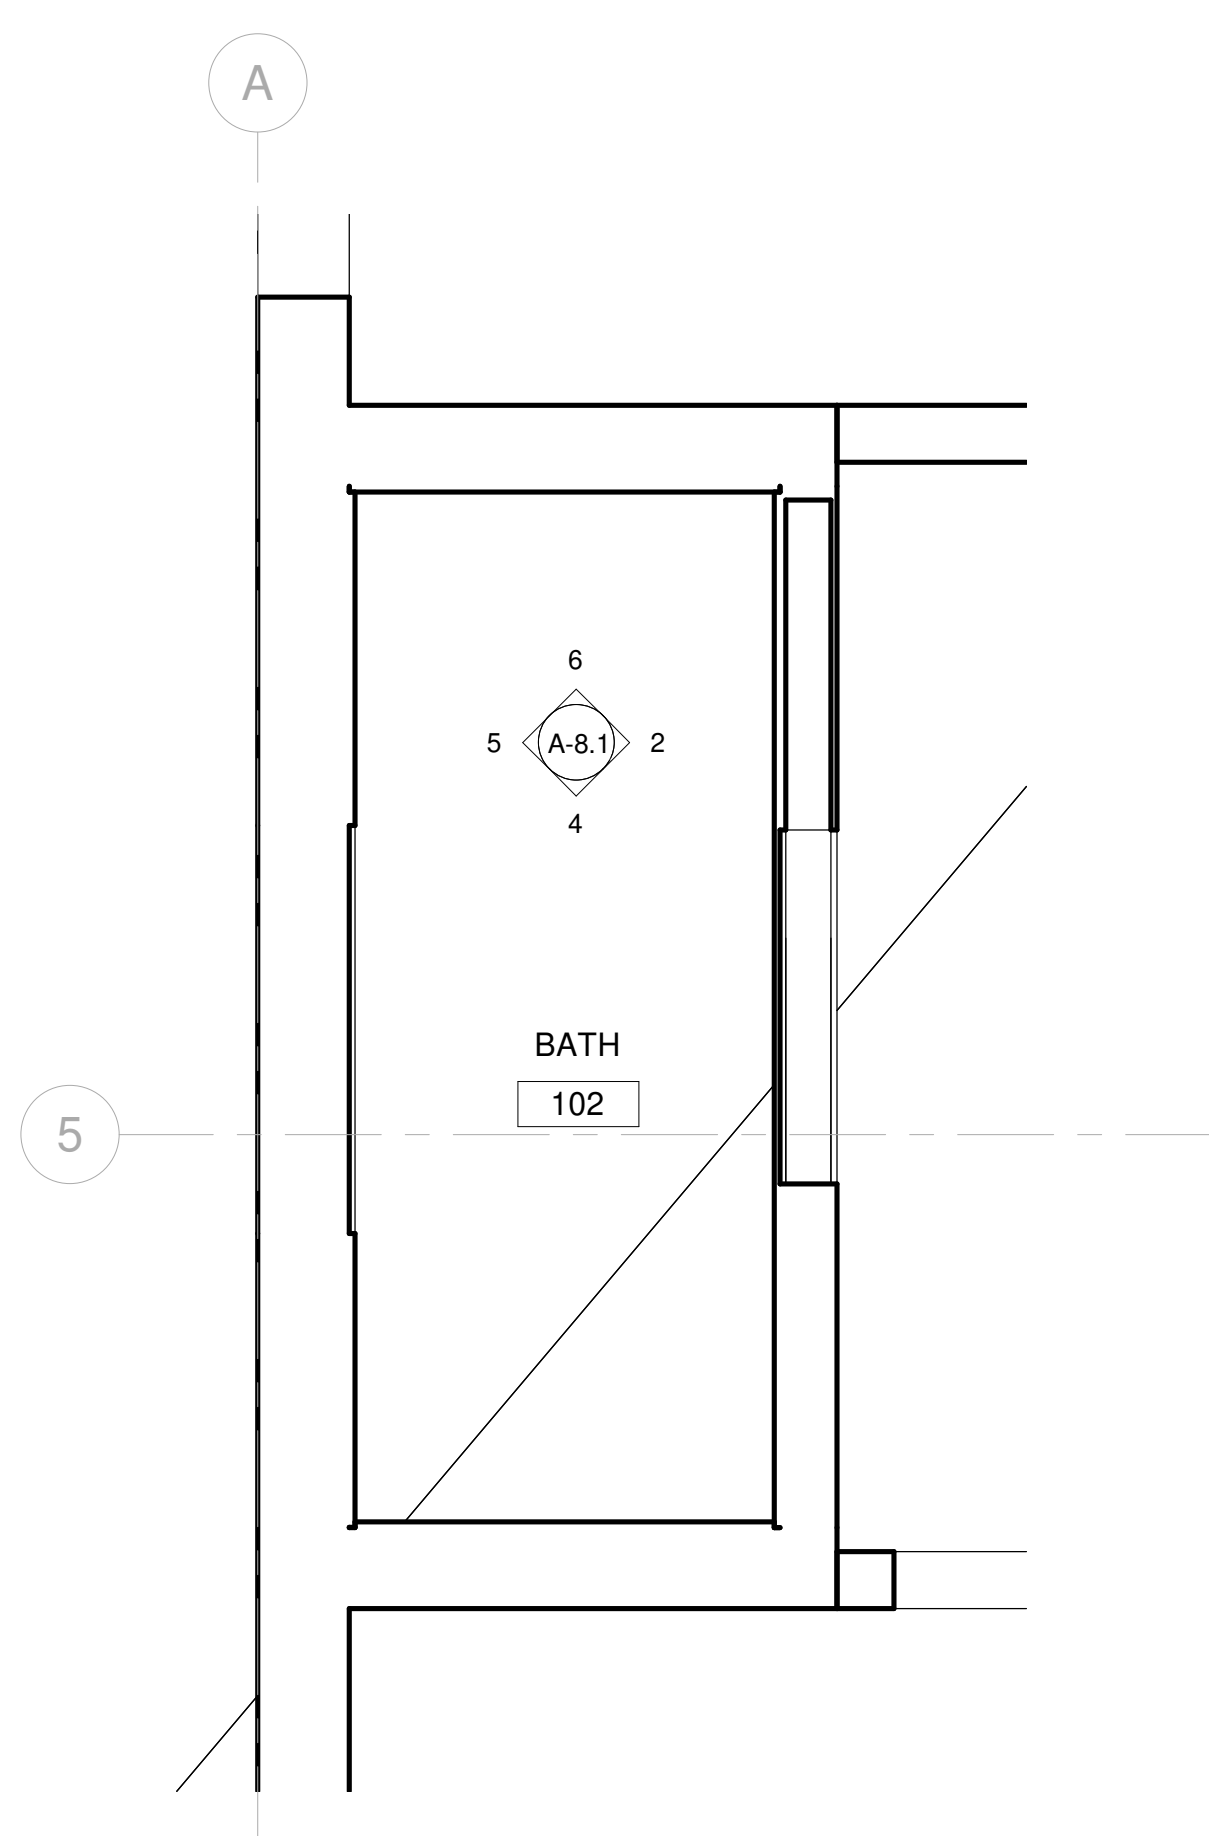


3 BATH 102 RCP  
3/4" = 1'-0"

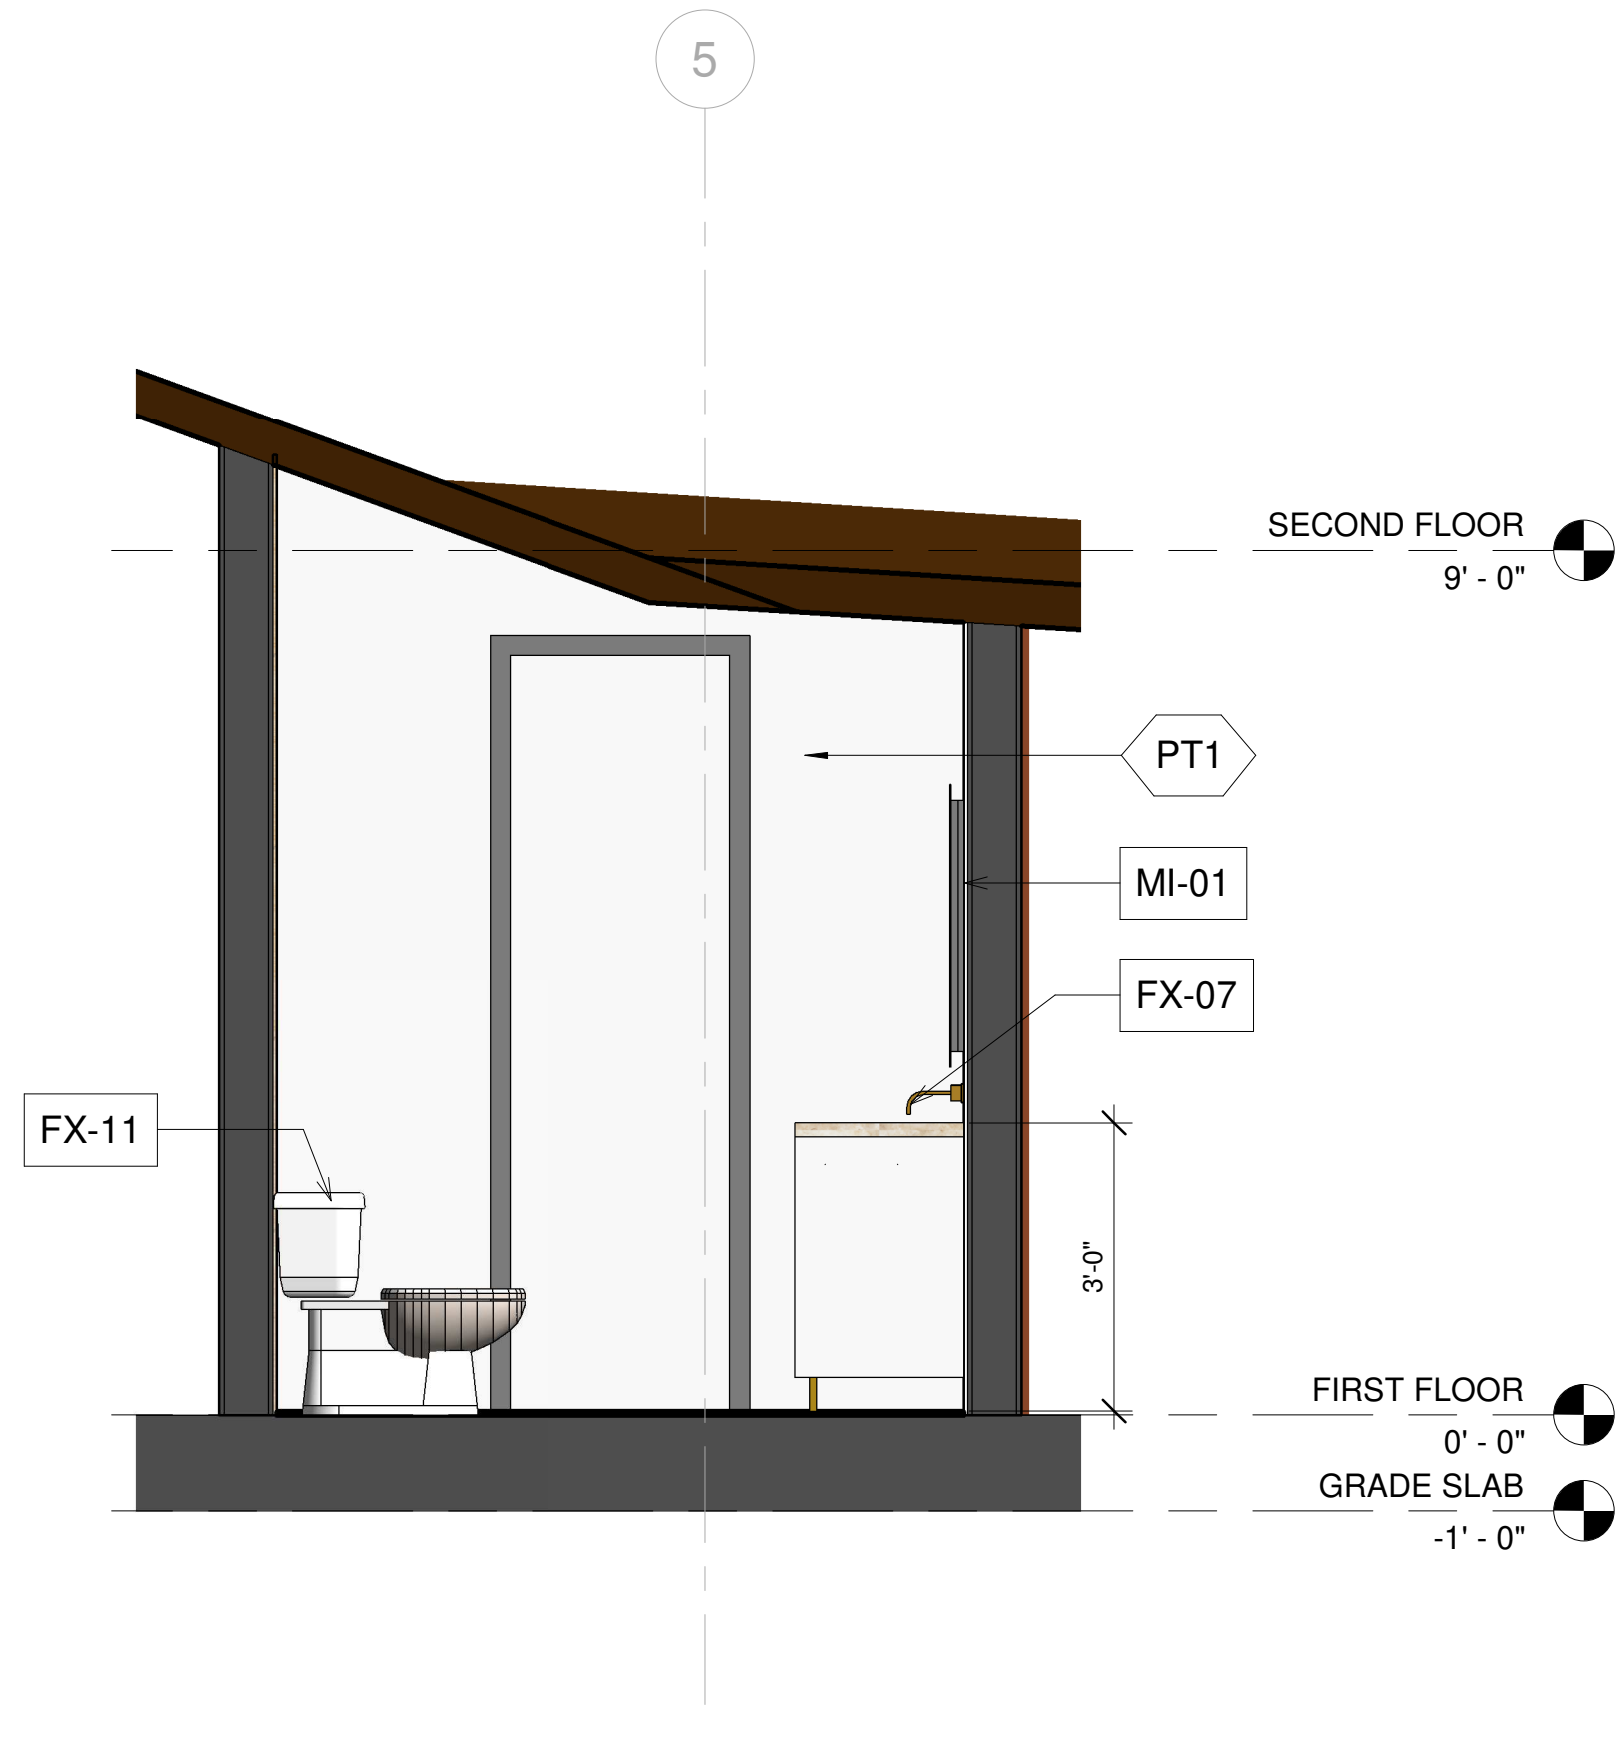


2 BATH 102 ELEVATION-A  
1/2" = 1'-0"

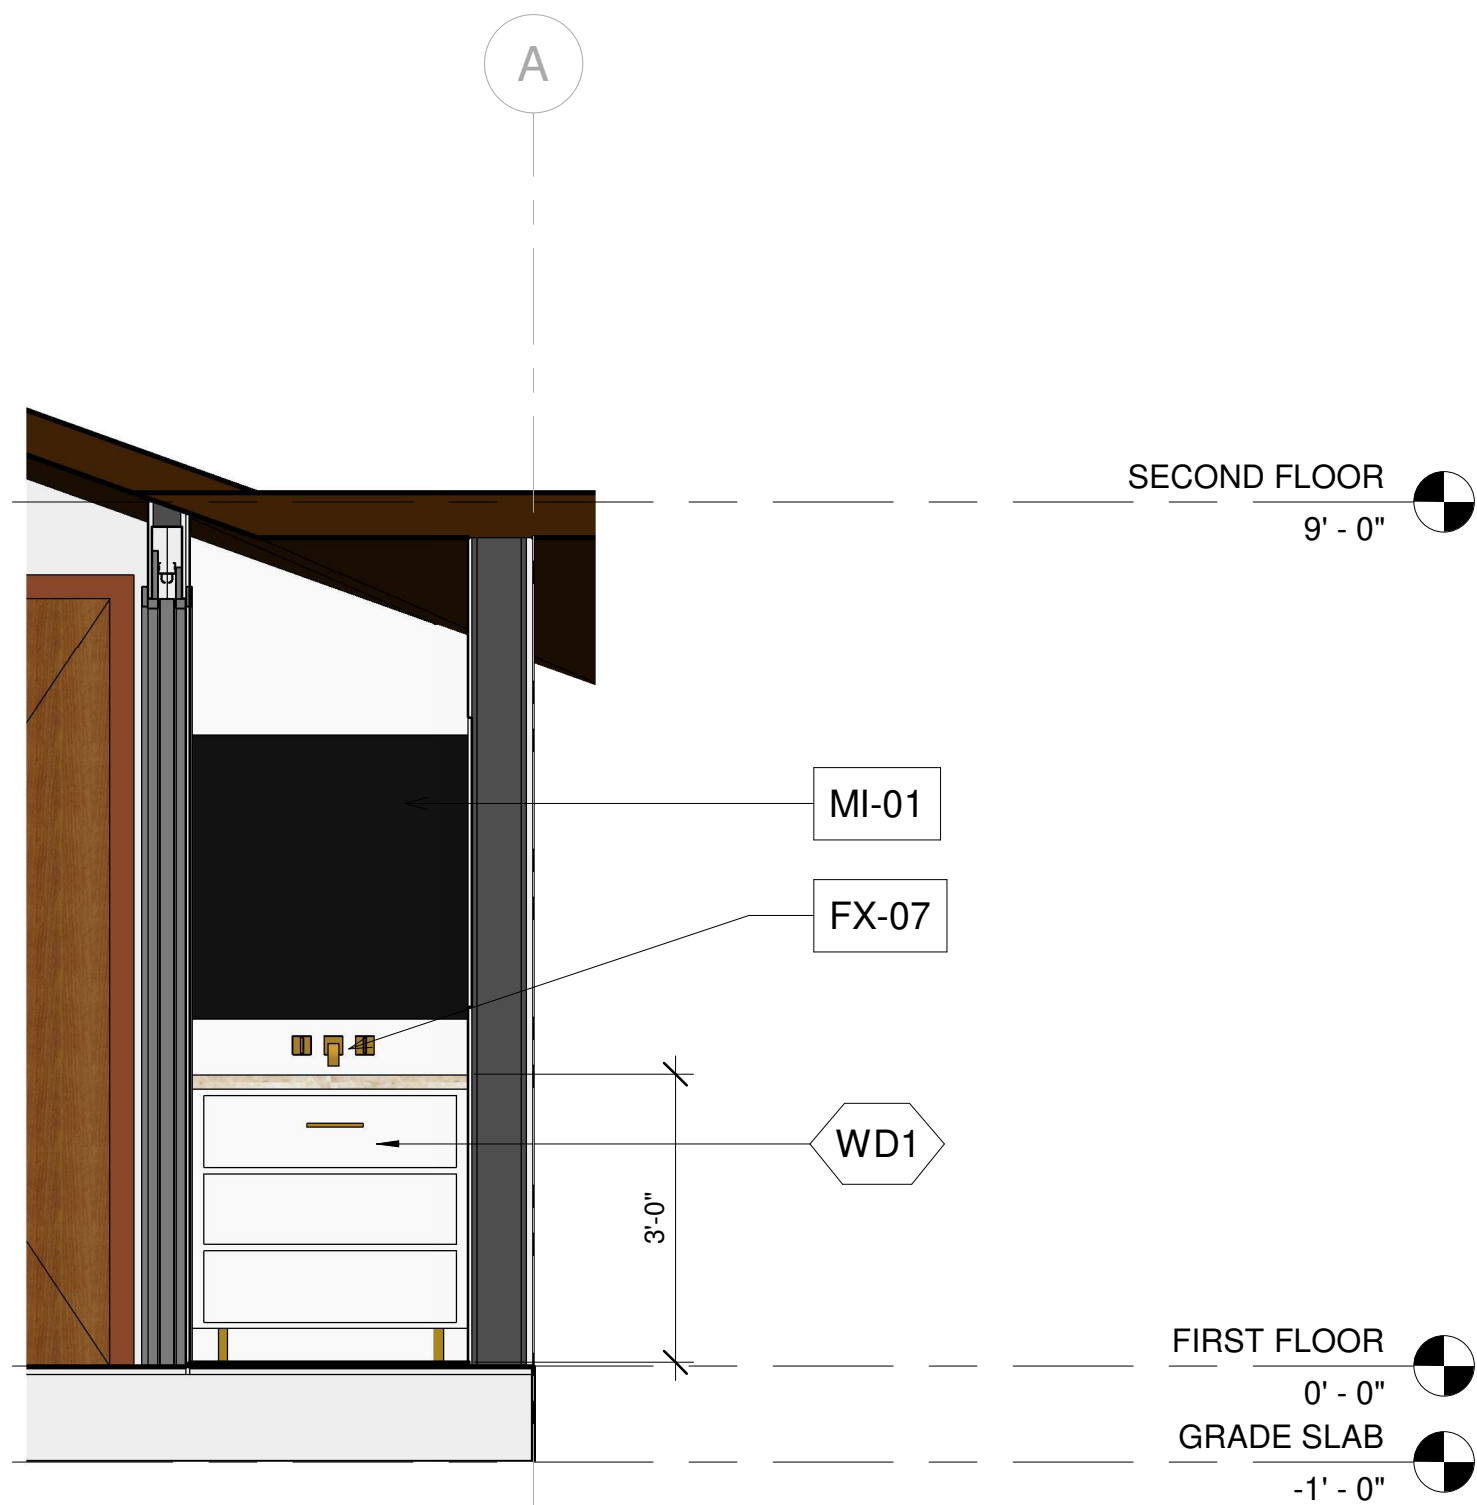

4 BATH 102 ELEVATION-B  
1/2" = 1'-0"

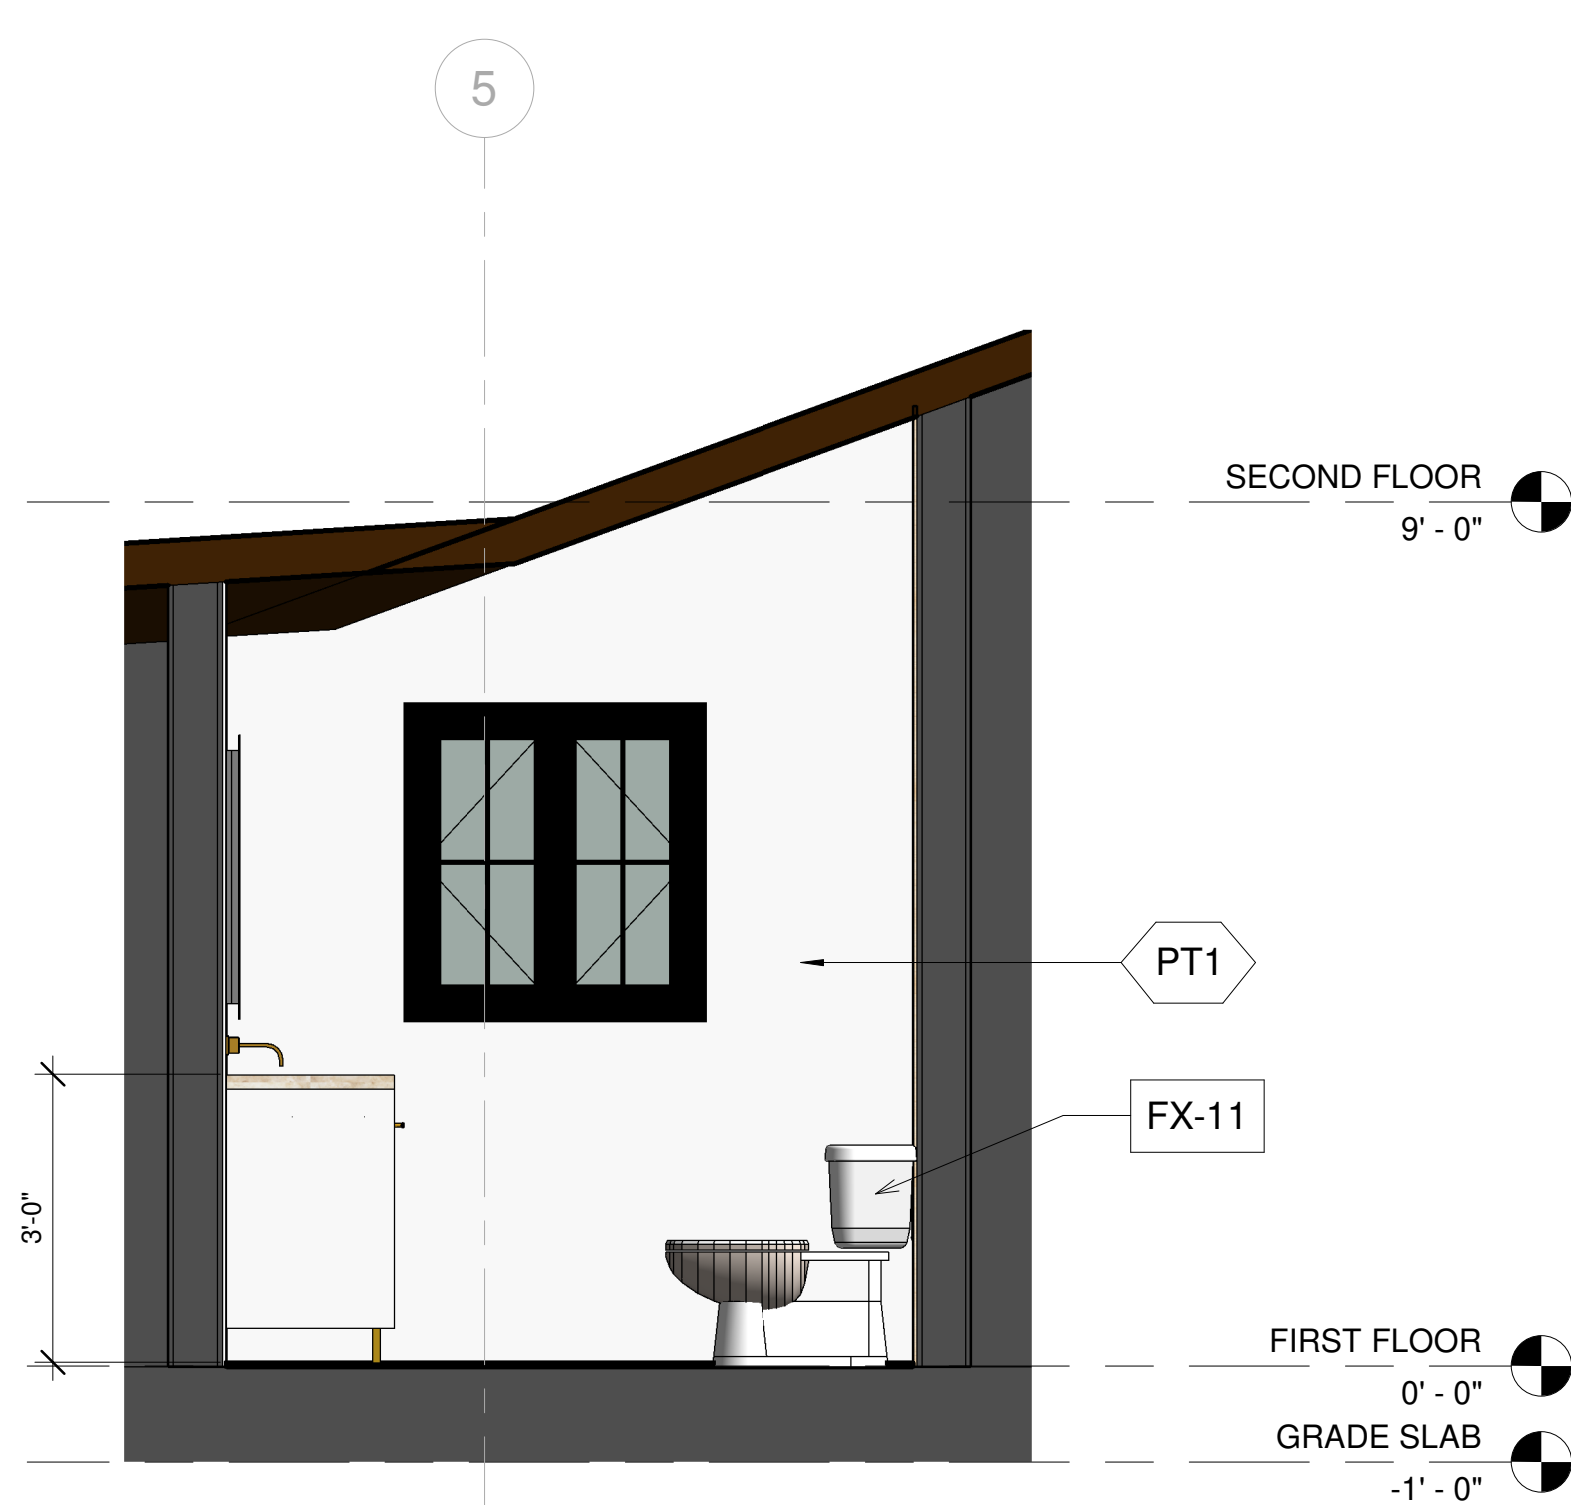

5 BATH 102 ELEVATION-C  
1/2" = 1'-0"

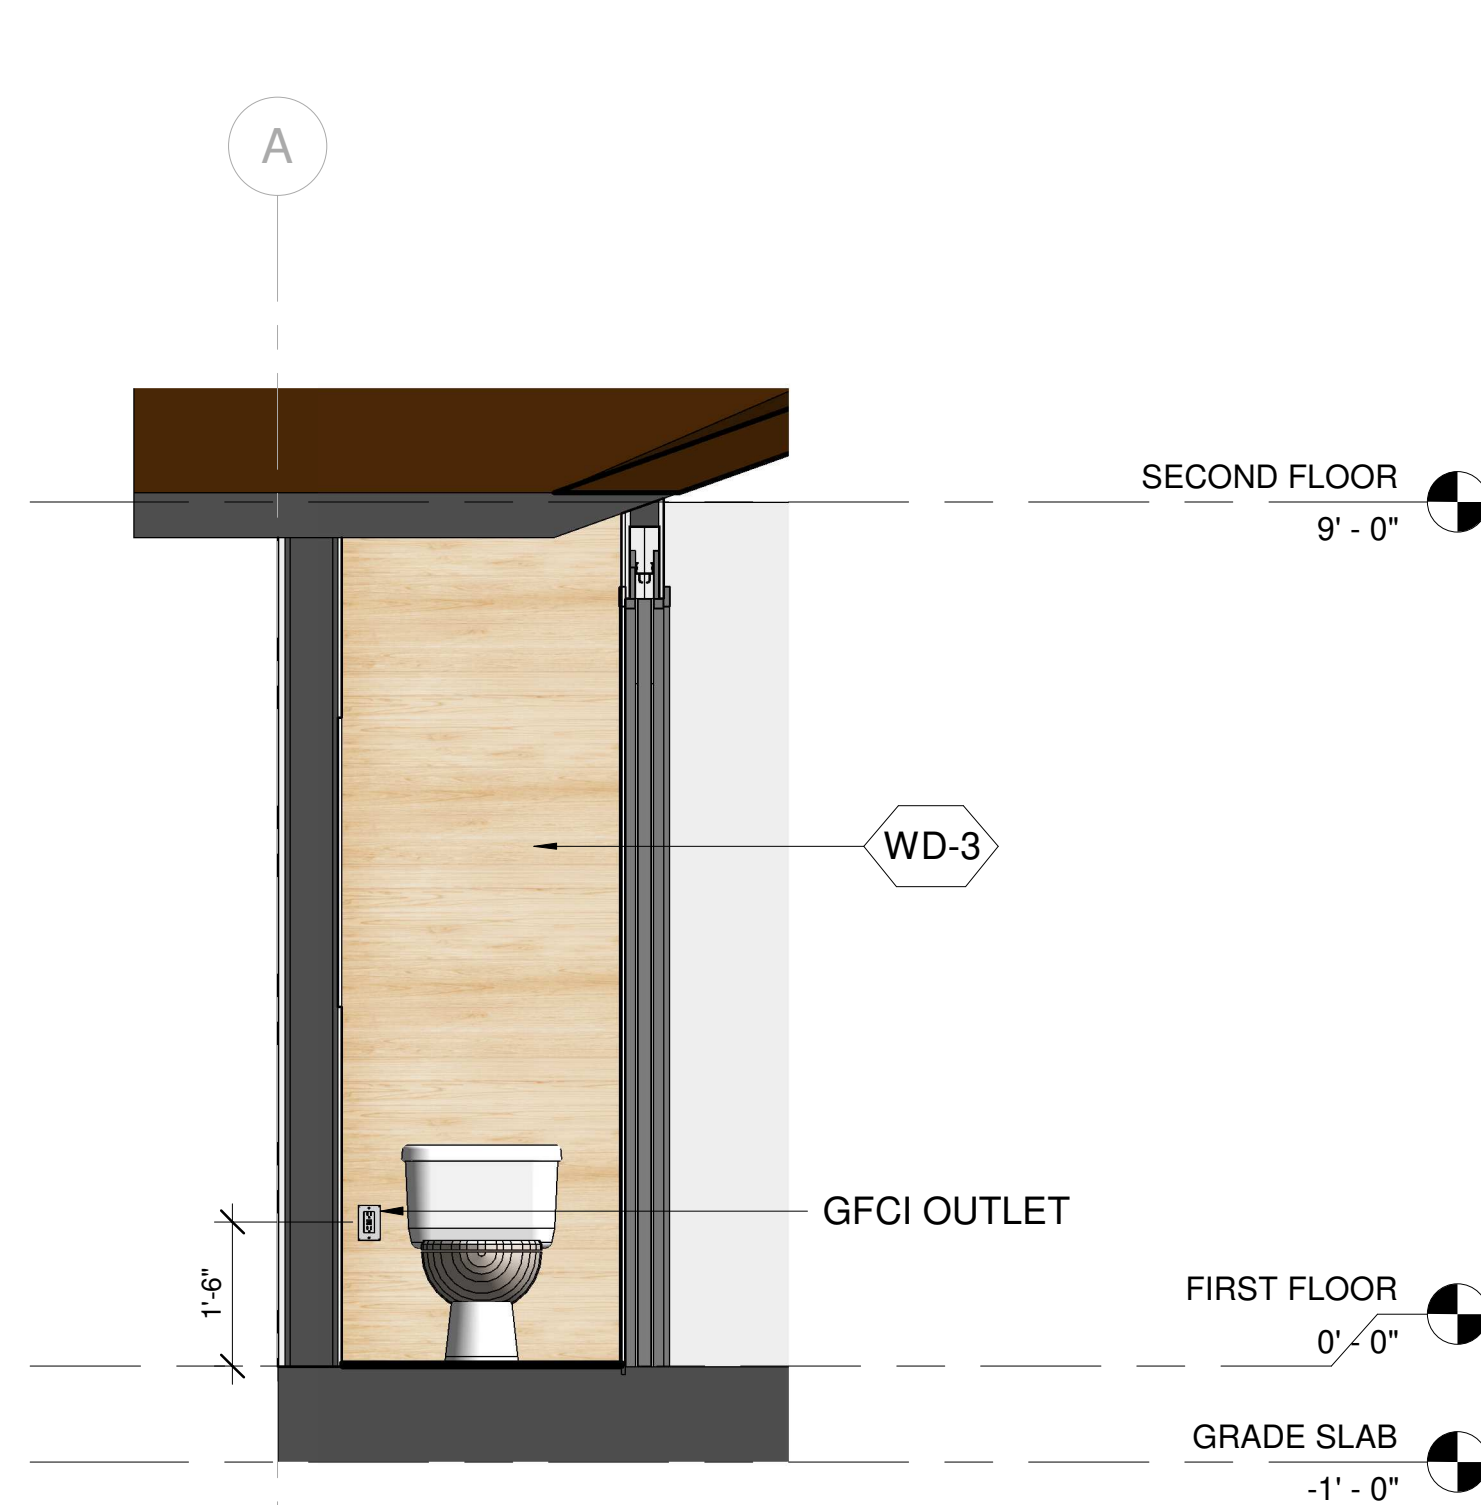

6 BATH 102 ELEVATION-D  
1/2" = 1'-0"

## KEY NOTE

N1	ADD GAS TO EXISTING FIRE PLACE
N2	REFURBISH EXISTING FIRE PLACE INTO 2 SIDED FIRE PLACE
N3	OUTDOOR BBQ
N4	NEW FLOORING
N5	REMOVE FLAT CEILING
N6	PROVIDE SKYLIGHT
N7	FLOATING SINK WITH VANITY
N8	NEW TUB
N9	NEW WATER CLOSET
N10	NEW SINK
N11	NEW BIDET
N12	GFCI OUTLET
N13	REFURBISH EXISTING WALL, PREP FOR NEW SHEAR WALL PER STRUCTURAL
N14	18" X 24" ROOF VENT 72 SQ.INCH EACH
E1	EXISTING SKYLIGHT TO REMAIN

## LEGEND

	FIXTURE TAG REFER TO A8.9 & A8.10
	FINISH TAG REFER TO A8.9

**DESIGN EVEREST**  
CONSULTING ENGINEERS

ENLARGED DETAILS - BATH 102  
AHMED RENOVATION  
ALINA AHMED  
LOT 15  
1081 NOTTINGHAM WAY  
LOS ALTOS, CA 94024

DELTA DESCRIPTION:  
CITY SUBMITTAL

DATE:  
22/09/17

No.

DATE: 22/09/17

SCALE: As indicated

DRAWN BY :

CKD BY:

PROJECT : 202107199

DRAWING NO.

A-8.1





1 BATH 102.1




2 BATH 102.2


No.	DATE:	DELTA DESCRIPTION:
1	22/09/17	CITY SUBMITTAL
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3		
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DATE: 22/09/17  
SCALE:  
DRAWN BY :  
CKD BY:  
PROJECT : 202107199




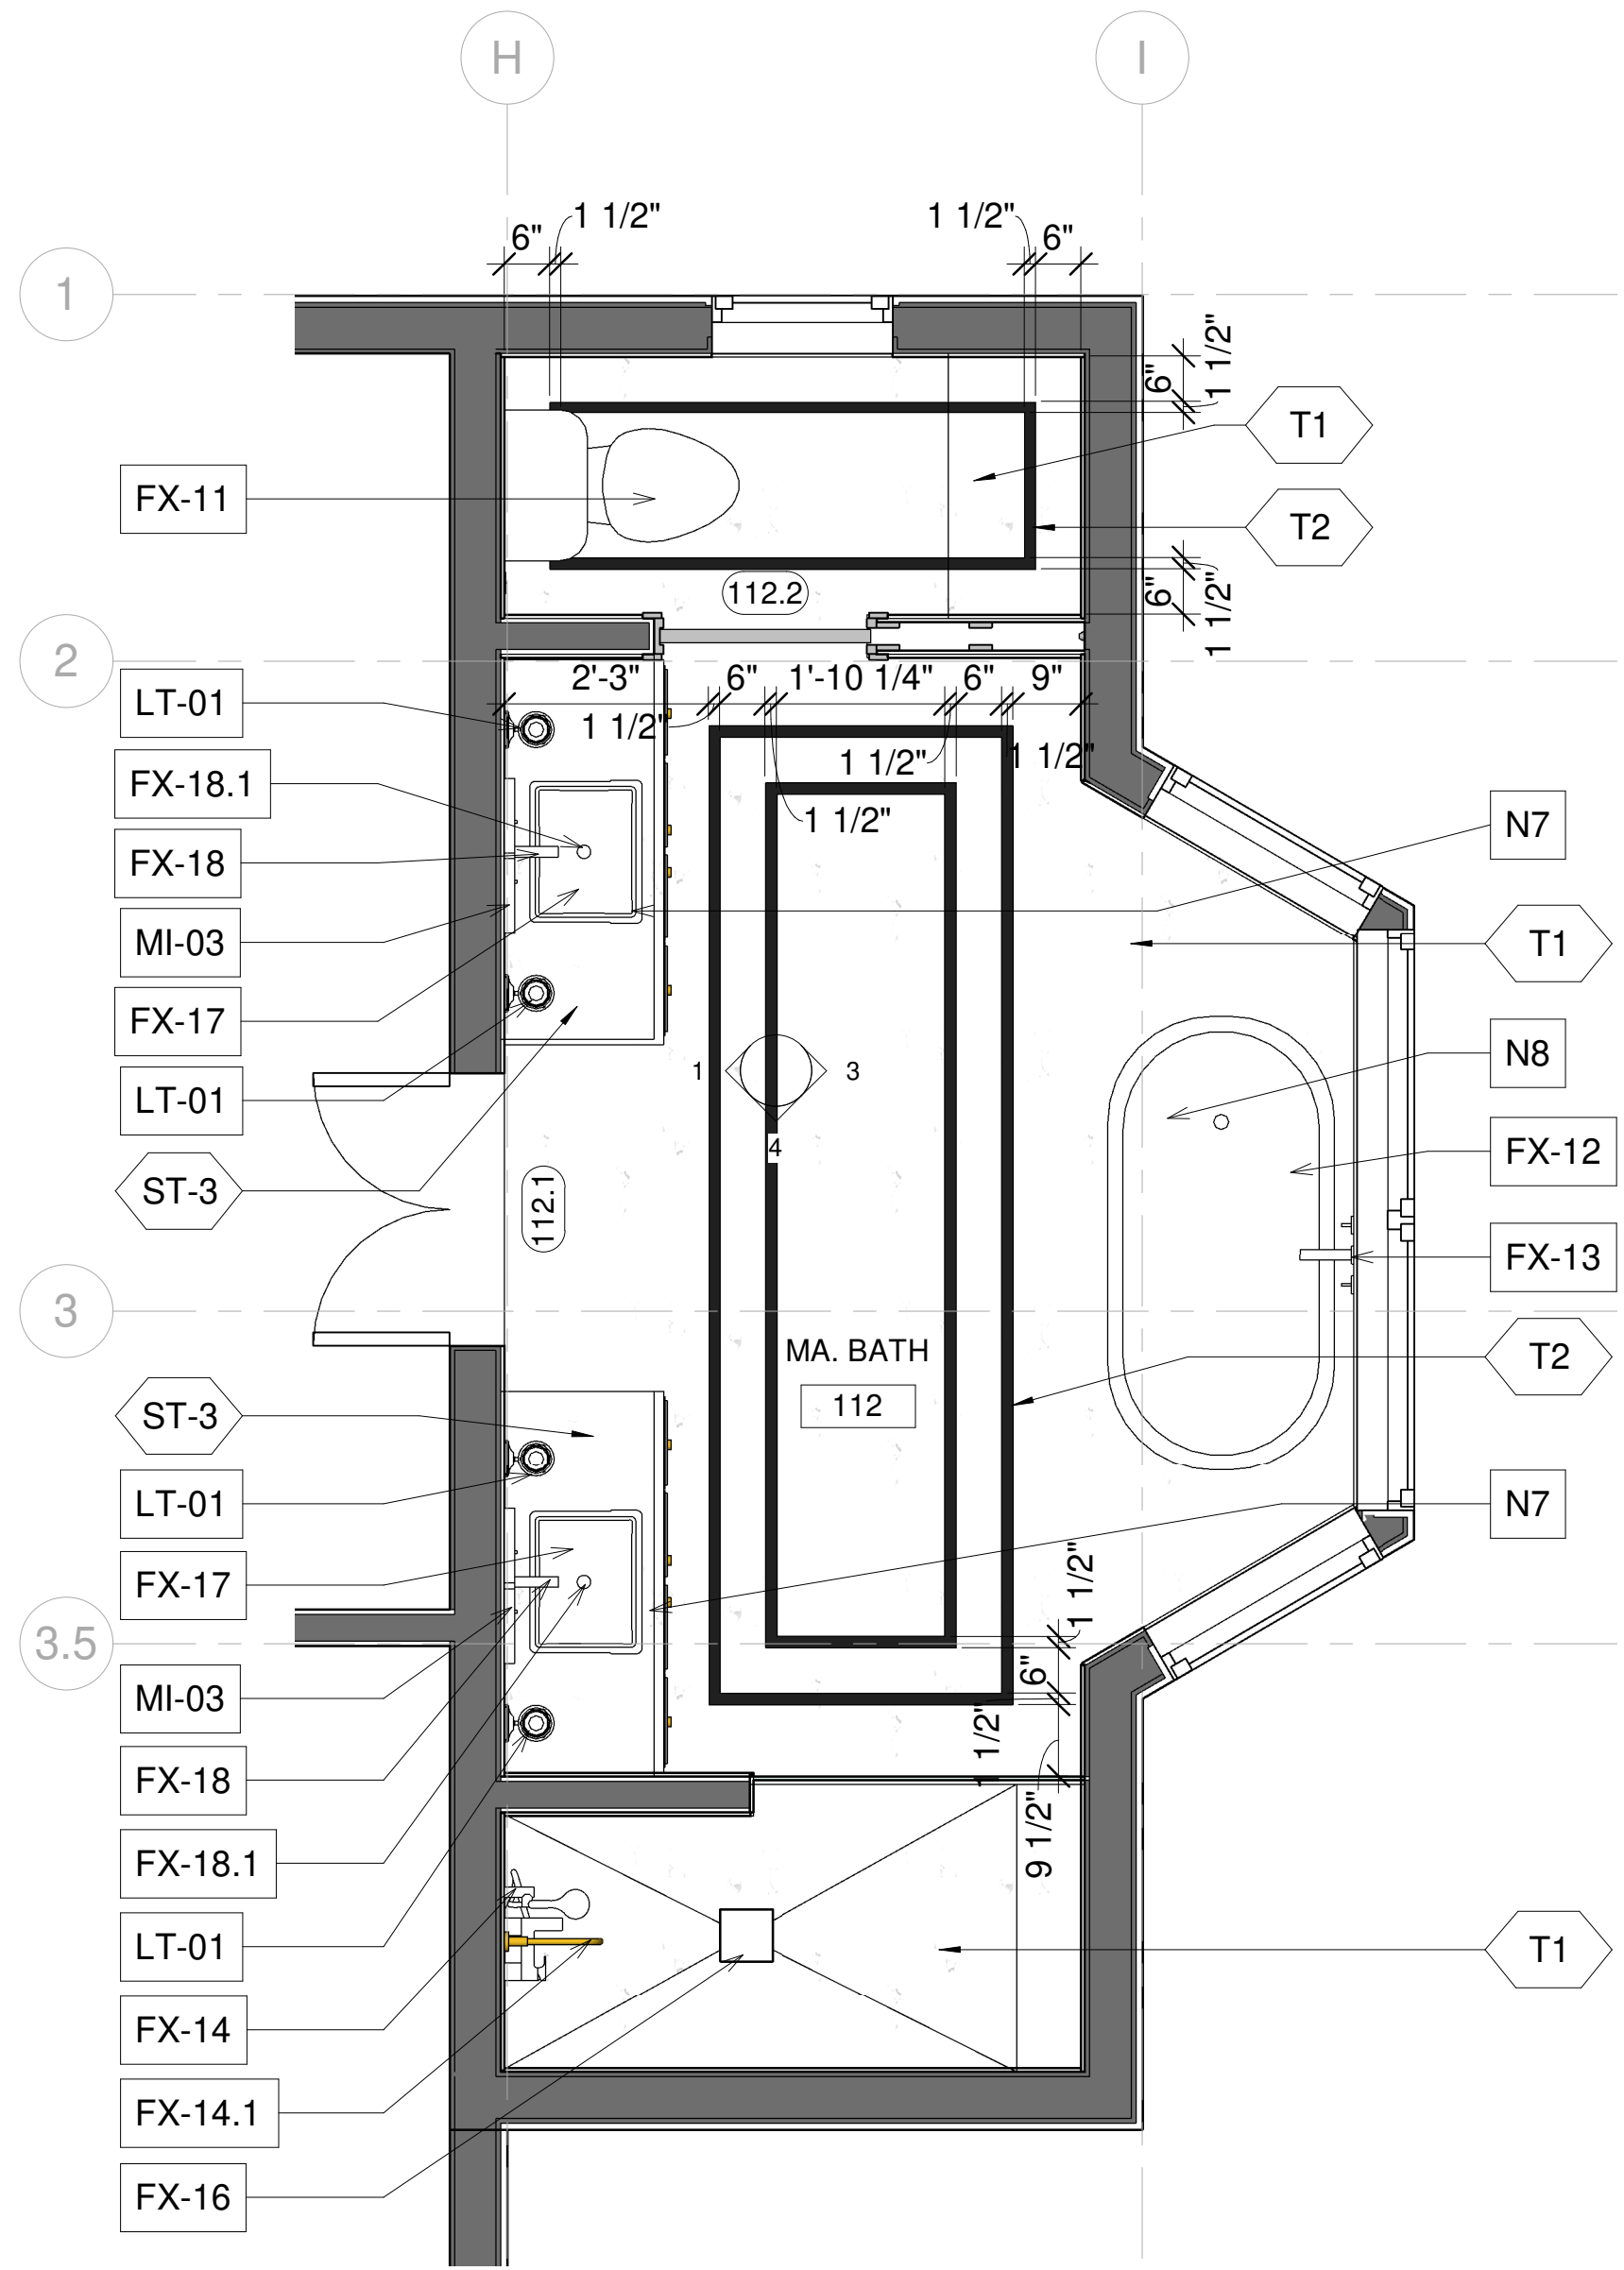


1 BATH 112 ENLARGED PLAN  
1/2" = 1'-0"

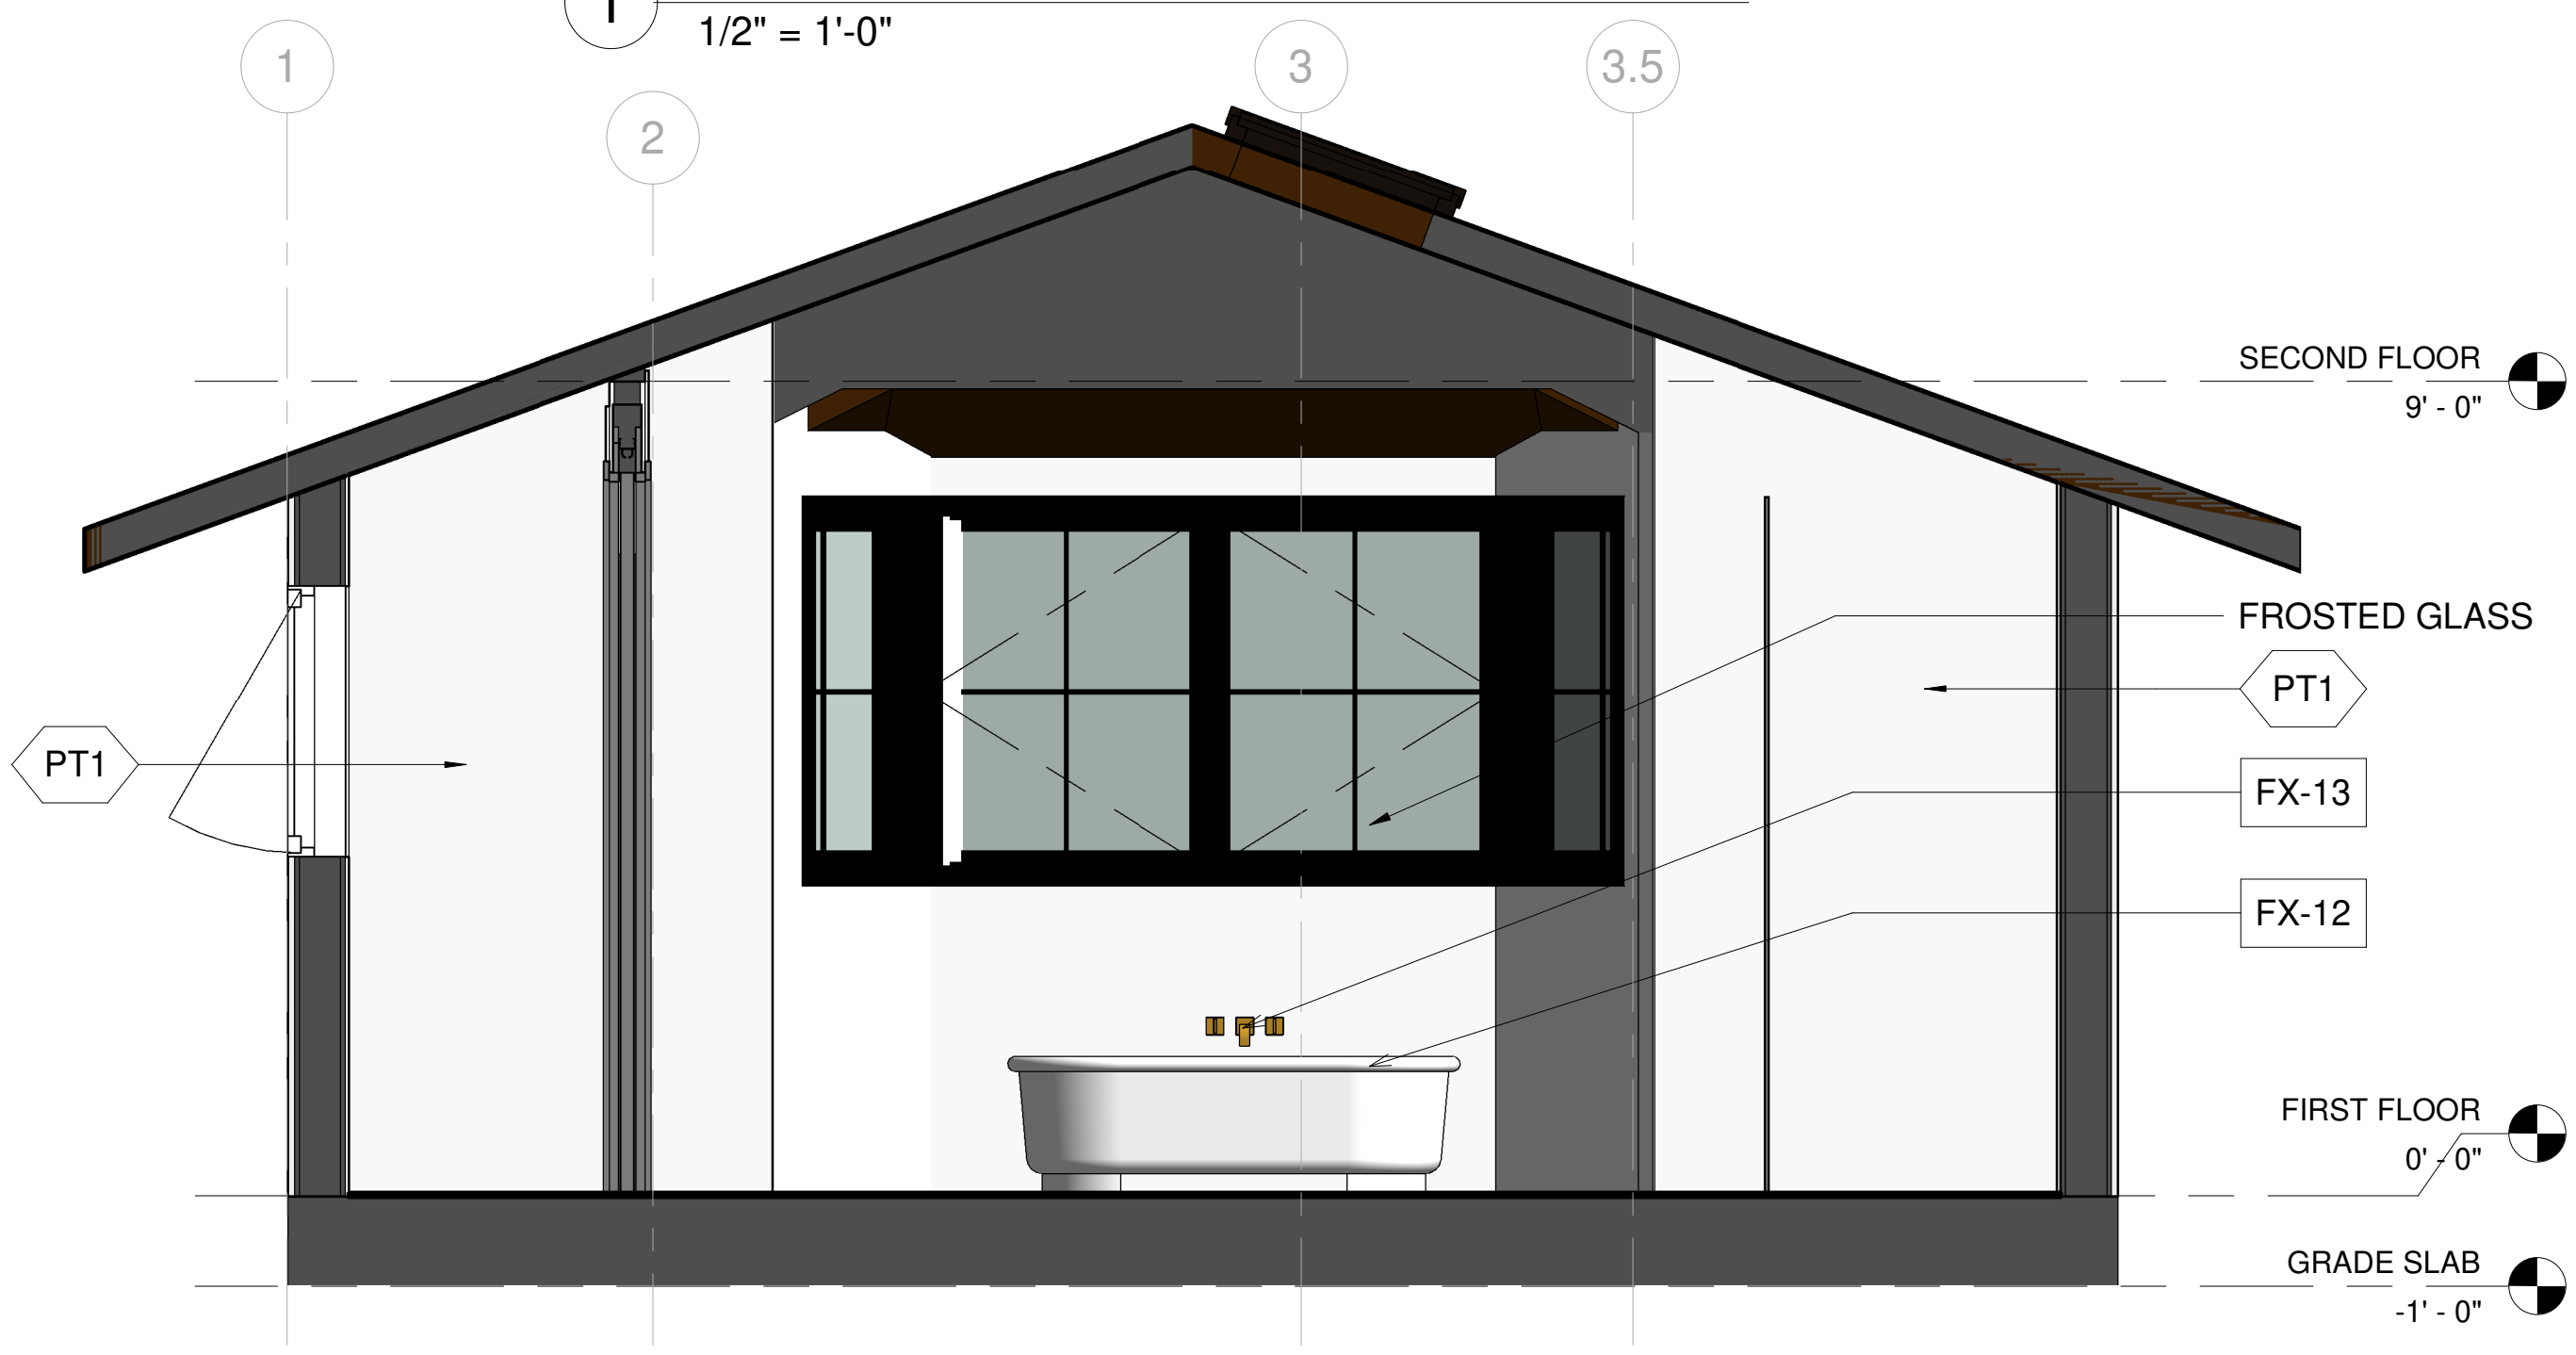

3 MA.BATH ELEVATION - A  
1/2" = 1'-0"

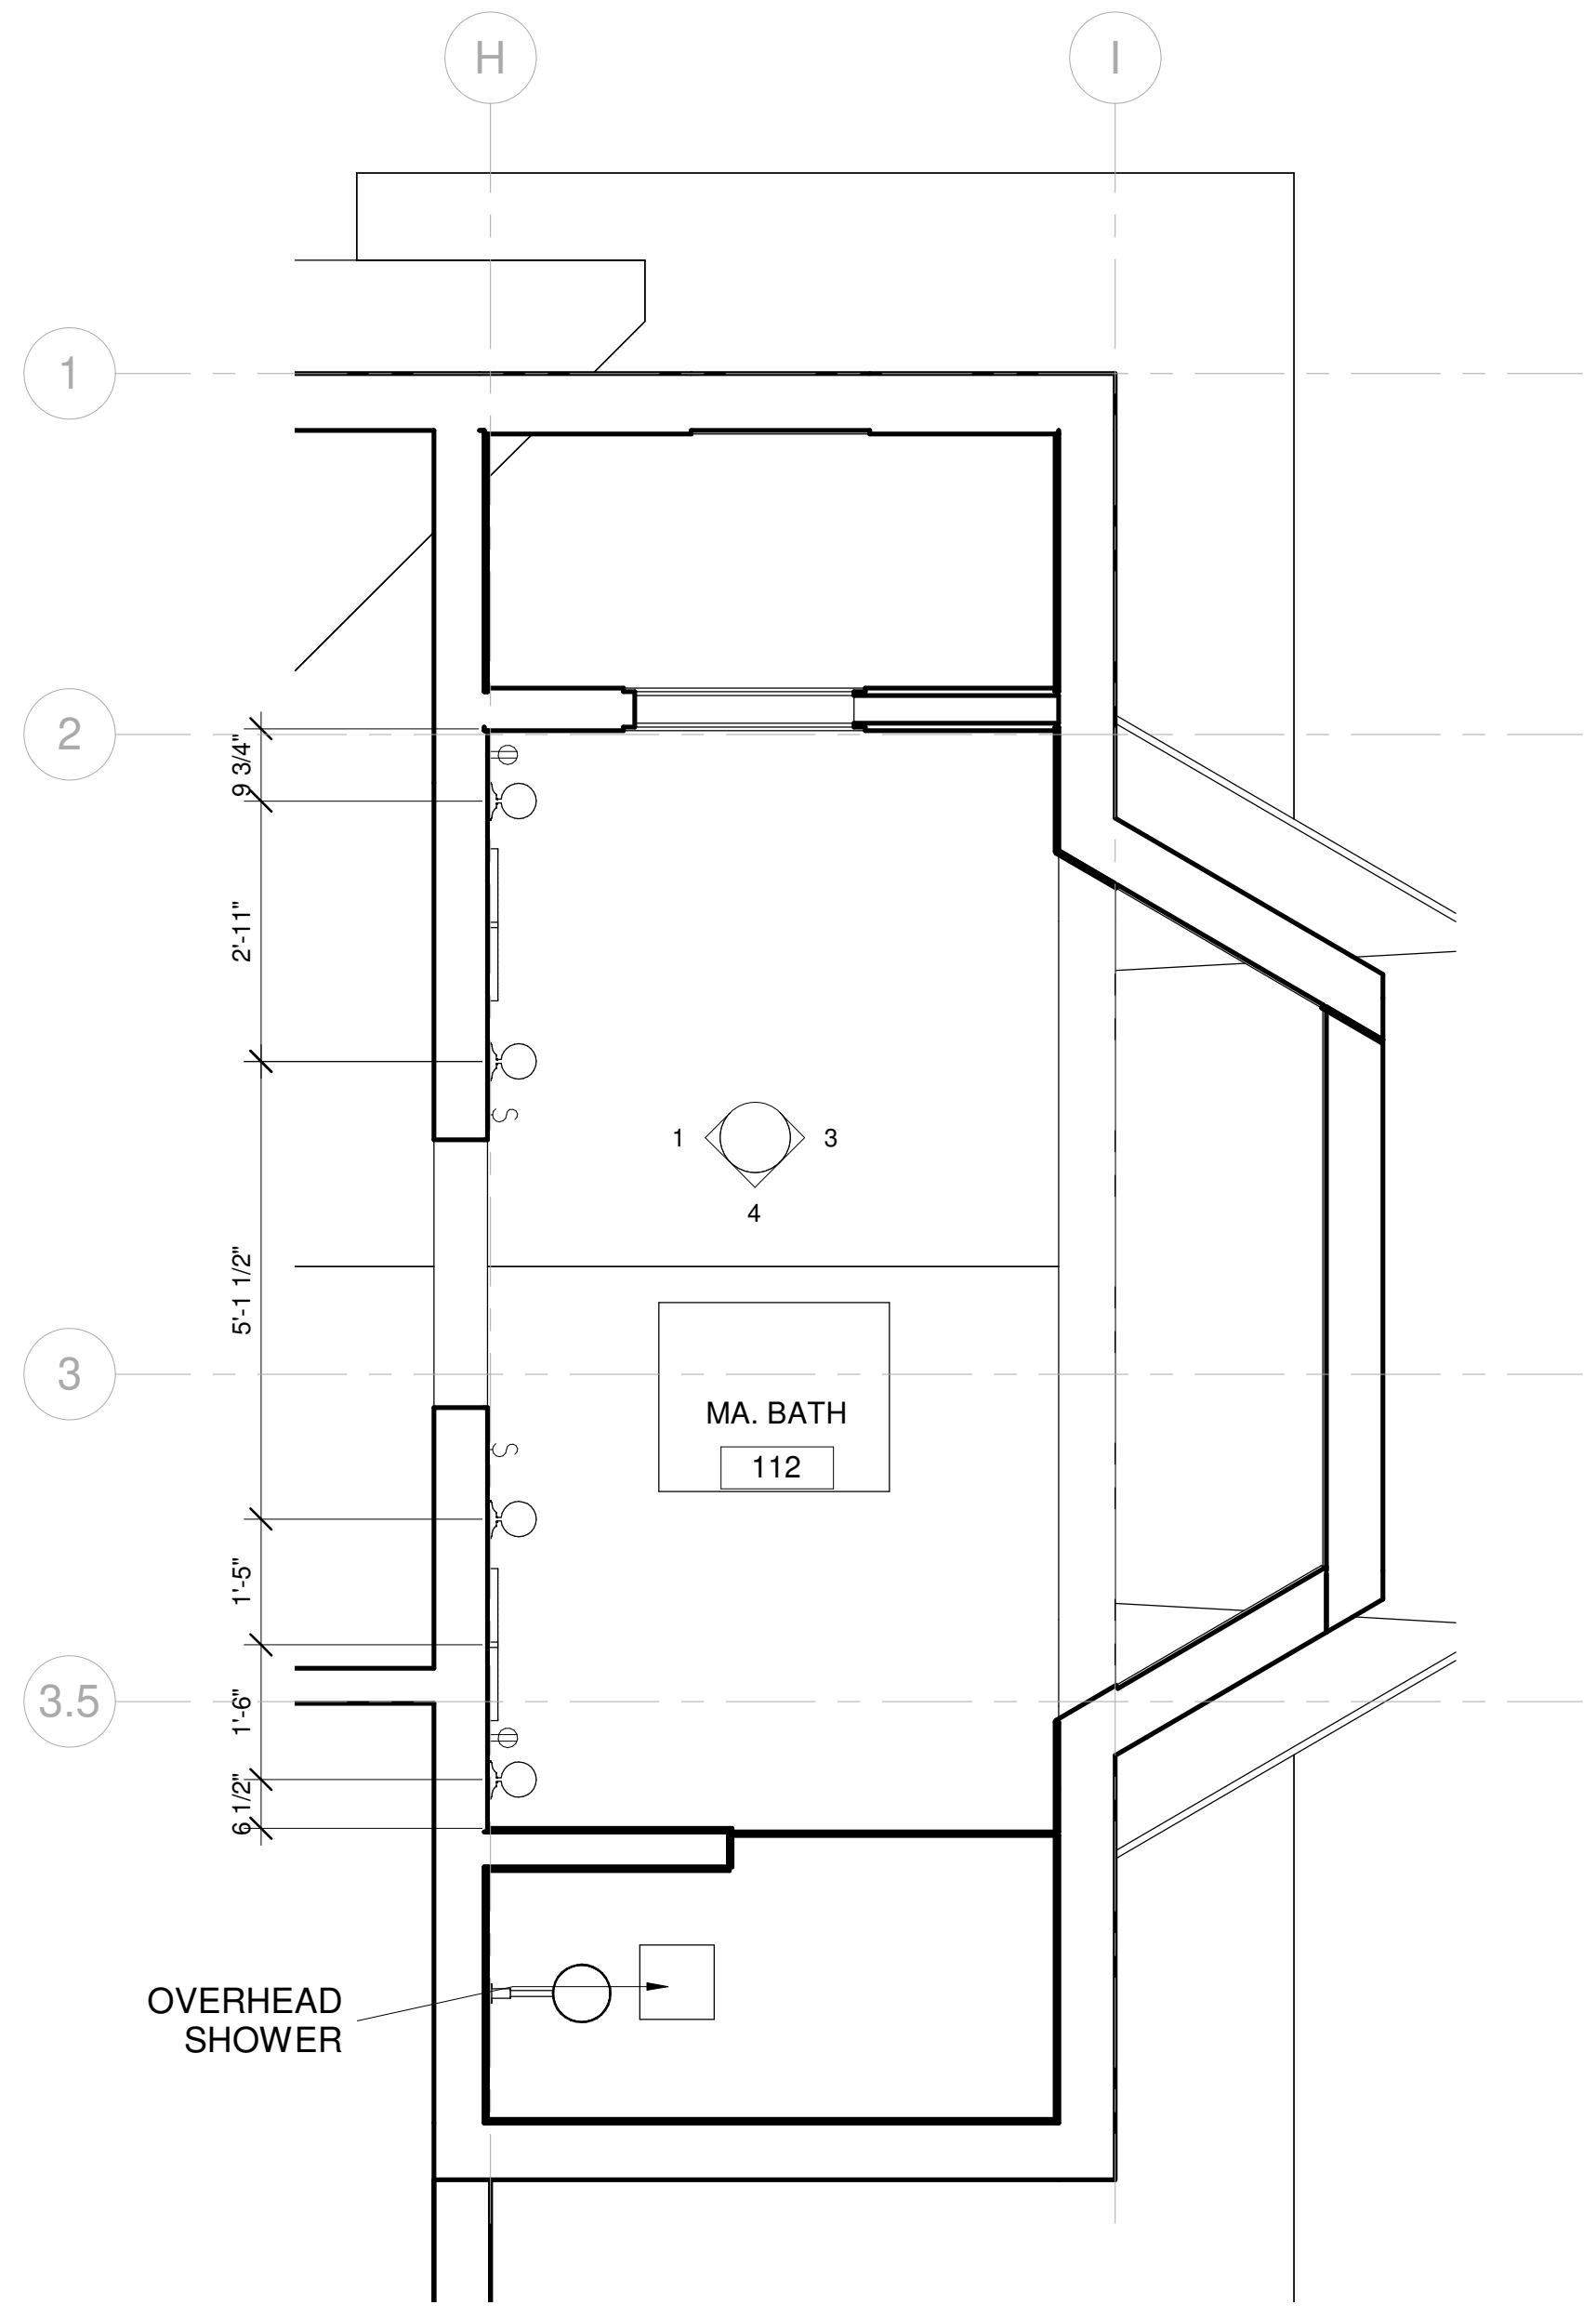

2 BATH 112 RCP  
1/2" = 1'-0"

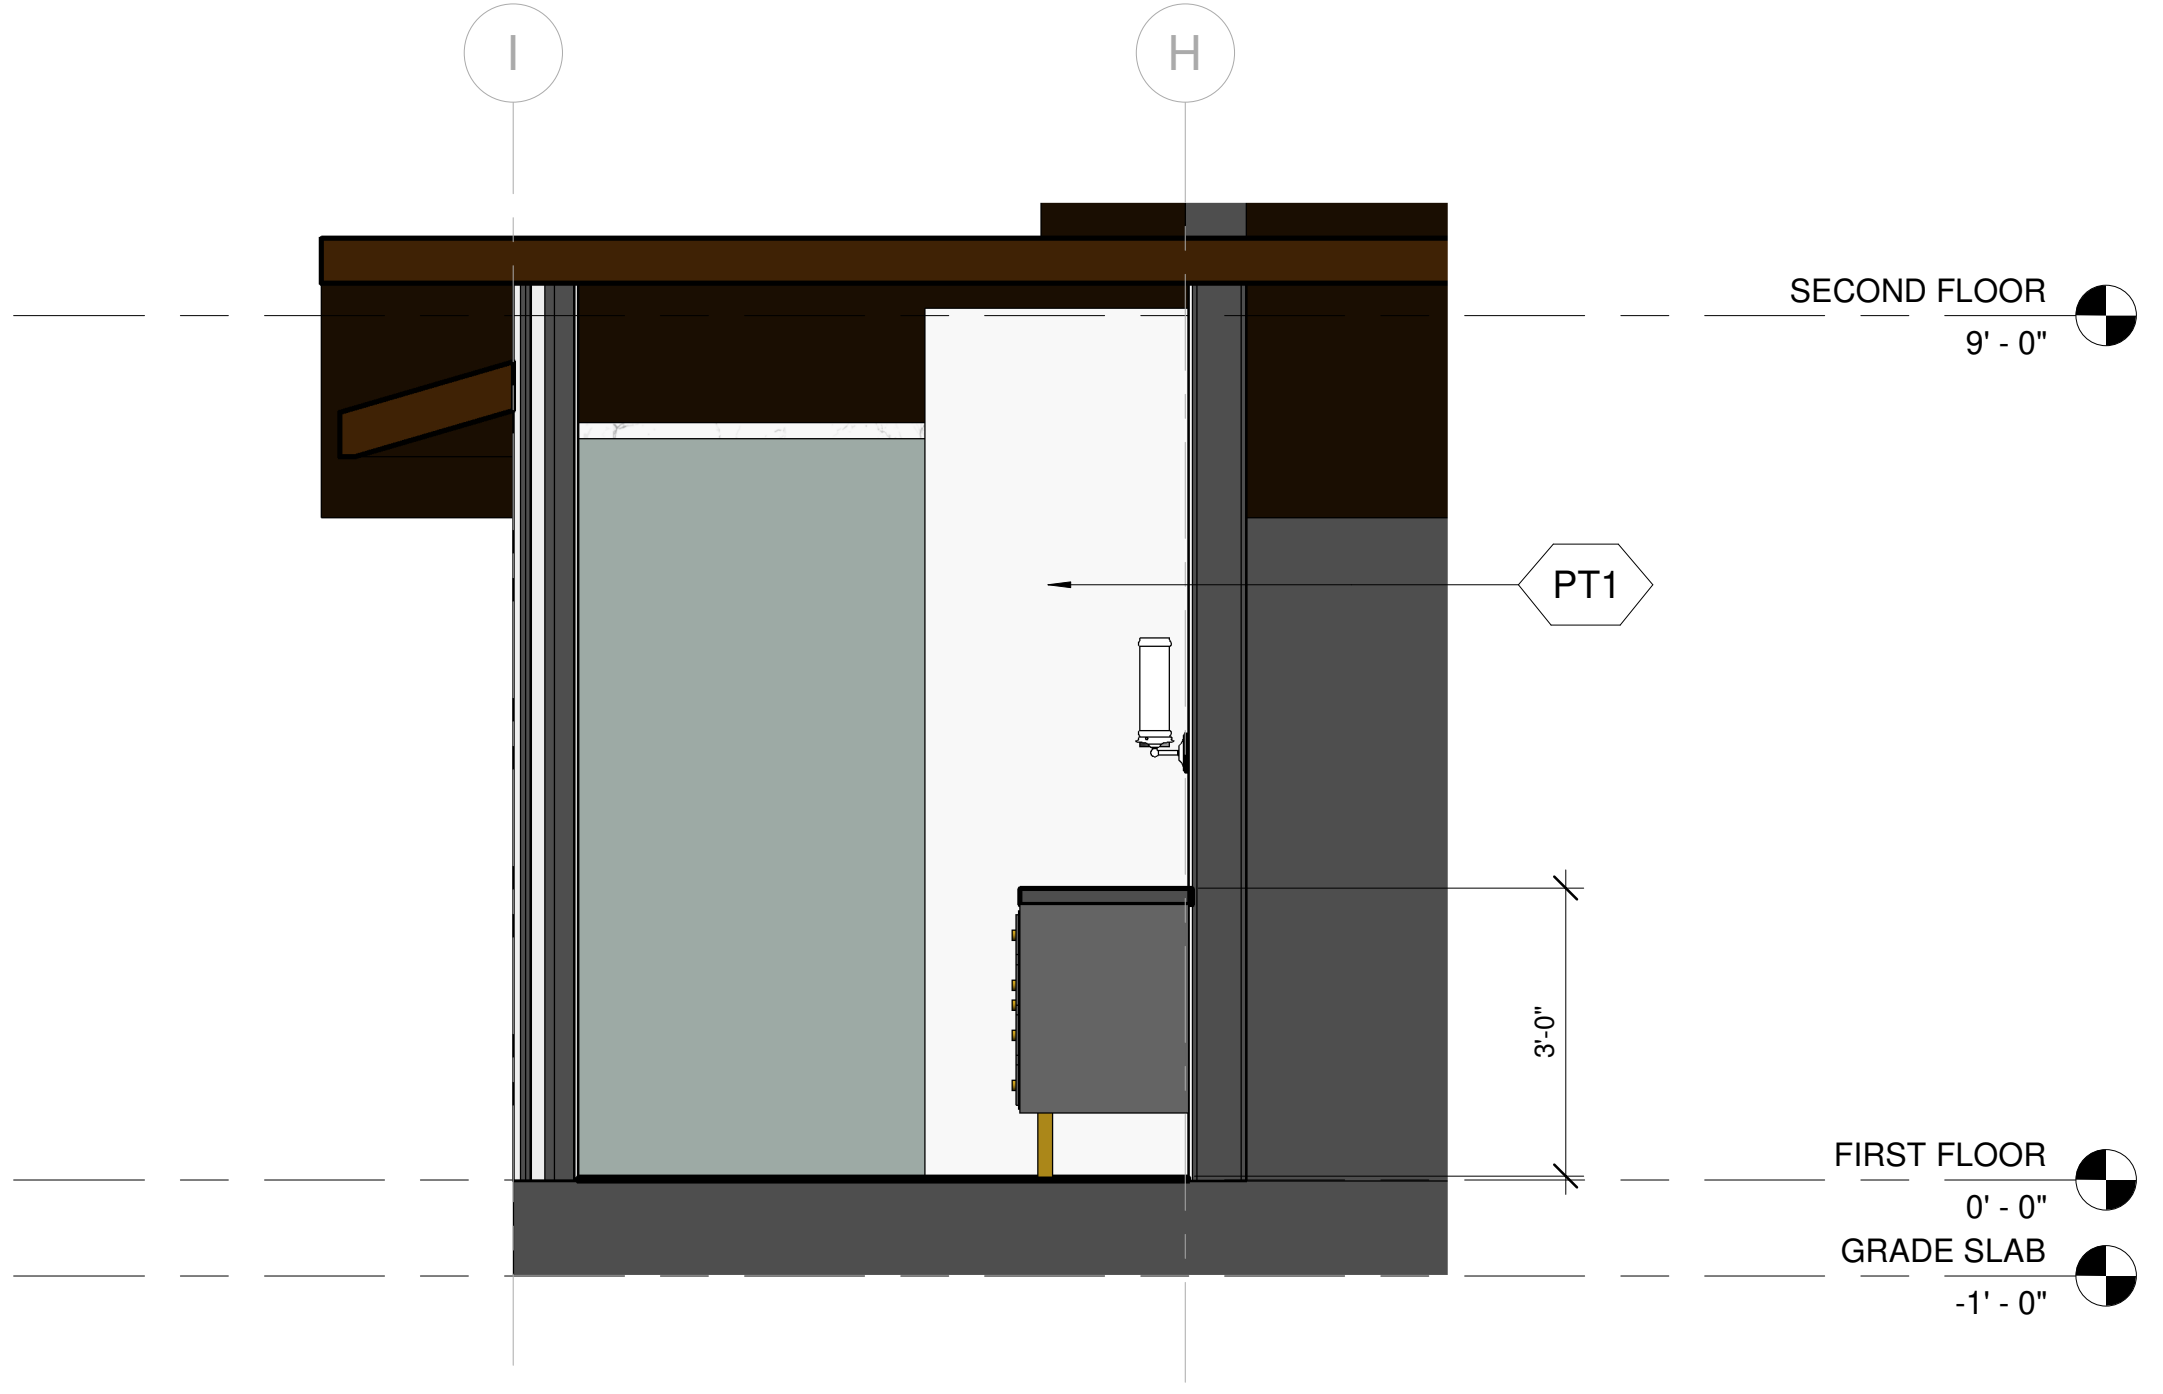

4 MA.BATH ELEVATION-B  
1/2" = 1'-0"

KEY NOTE

N1

ADD GAS TO EXISTING FIRE PLACE

N2

REFURBISH EXISTING FIRE PLACE INTO 2 SIDED FIRE PLACE

N3

OUTDOOR BBQ

N4

NEW FLOORING

N5

REMOVE FLAT CEILING

N6

PROVIDE SKYLIGHT

N7

FLOATING SINK WITH VANITY

N8

NEW TUB

N9

NEW WATER CLOSET

N10

NEW SINK

N11

NEW BIDET

N12

GFCI OUTLET

N13

REFURBISH EXISTING WALL, PREP FOR NEW SHEAR WALL PER STRUCTURAL

N14

18" X 24" ROOF VENT 72 SQ. INCH EACH

E1

EXISTING SKYLIGHT TO REMAIN

LEGEND

FIXTURE TAG REFER TO A8.9 & A8.10

FINISH TAG REFER TO A8.9

DESIGN EVEREST

CONSULTING ENGINEERS

365 FLOWER LANE

MOUNTAIN VIEW, CA 94043

PHONE: (888) 311-3015 FAX: (650) 695-1801

ENLARGED DETAILS - BATH 112

AHMED RENOVATION

ALINA AHMED

LOT 15

1081 NOTTINGHAM WAY

LOS ALTOS, CA 94024

DELTA DESCRIPTION:

CITY SUBMITTAL

DATE:

22/09/17

No.

A

A

A

A

A

DATE:

22/09/17

SCALE:

As indicated

DRAWN BY :


CKD BY:

PROJECT : 202107199


DRAWING NO.

A-8.2




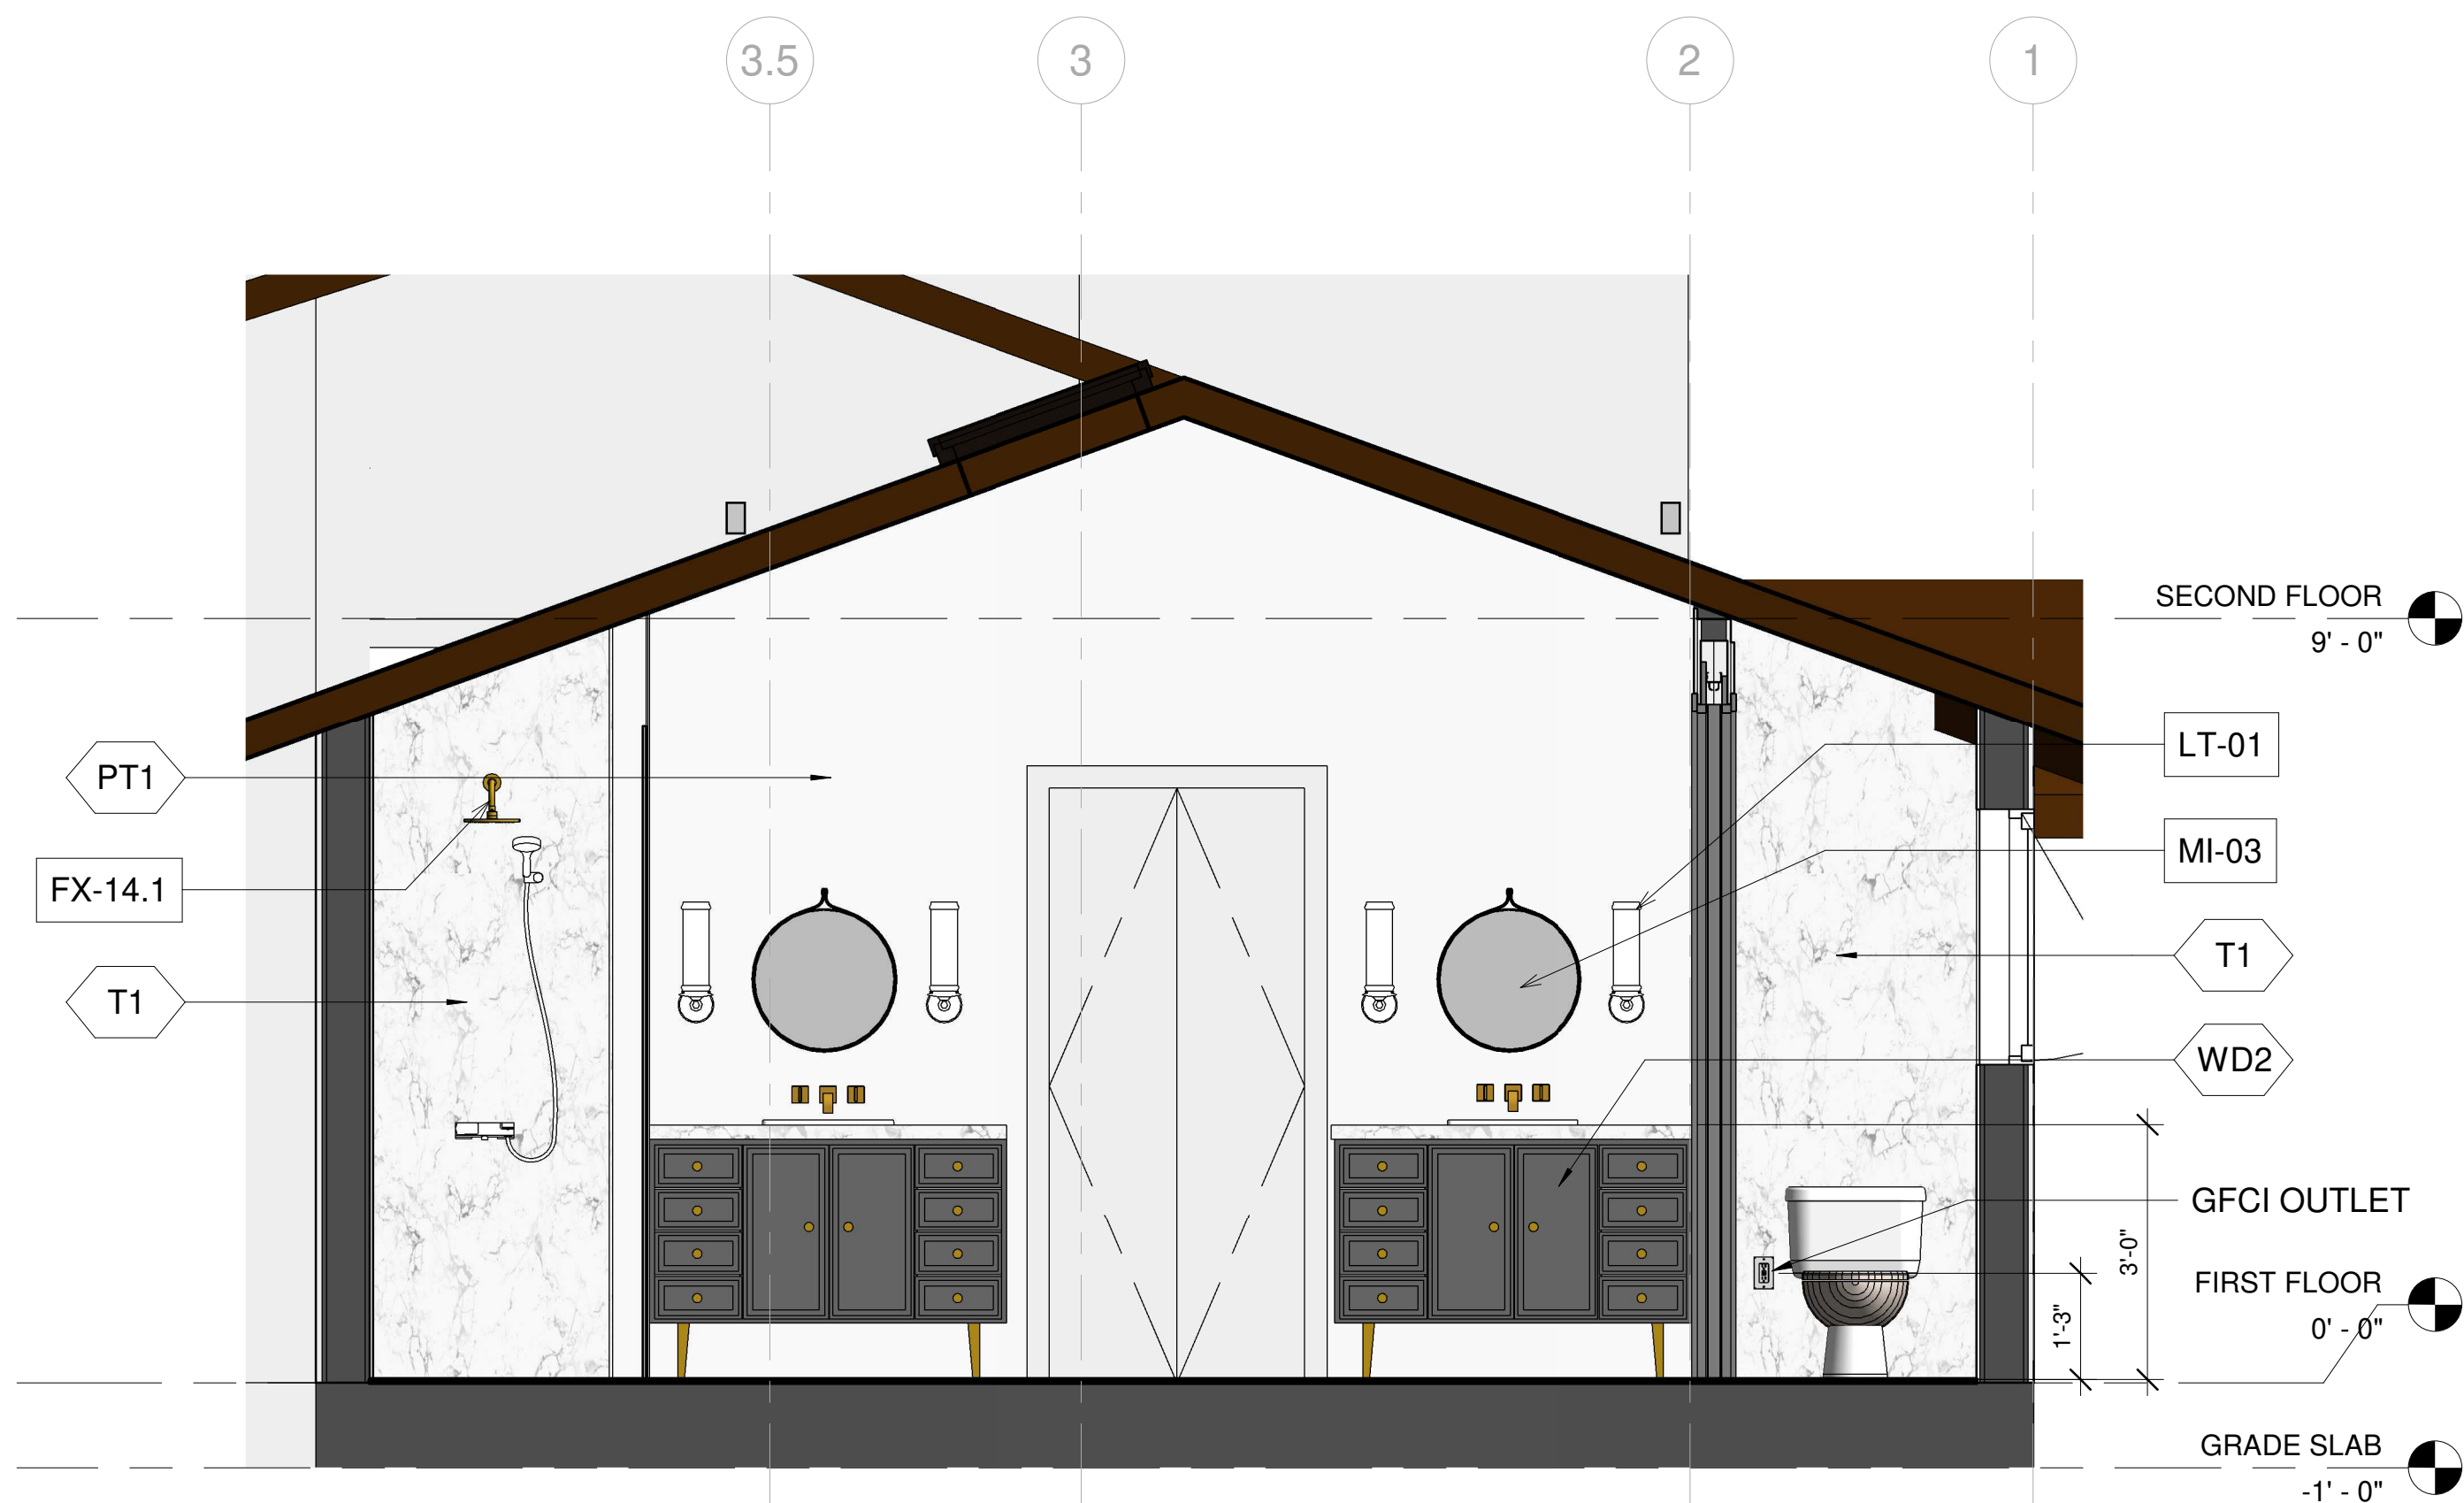


1 MA. BATH ELELVATION- C  
1/2" = 1'-0"

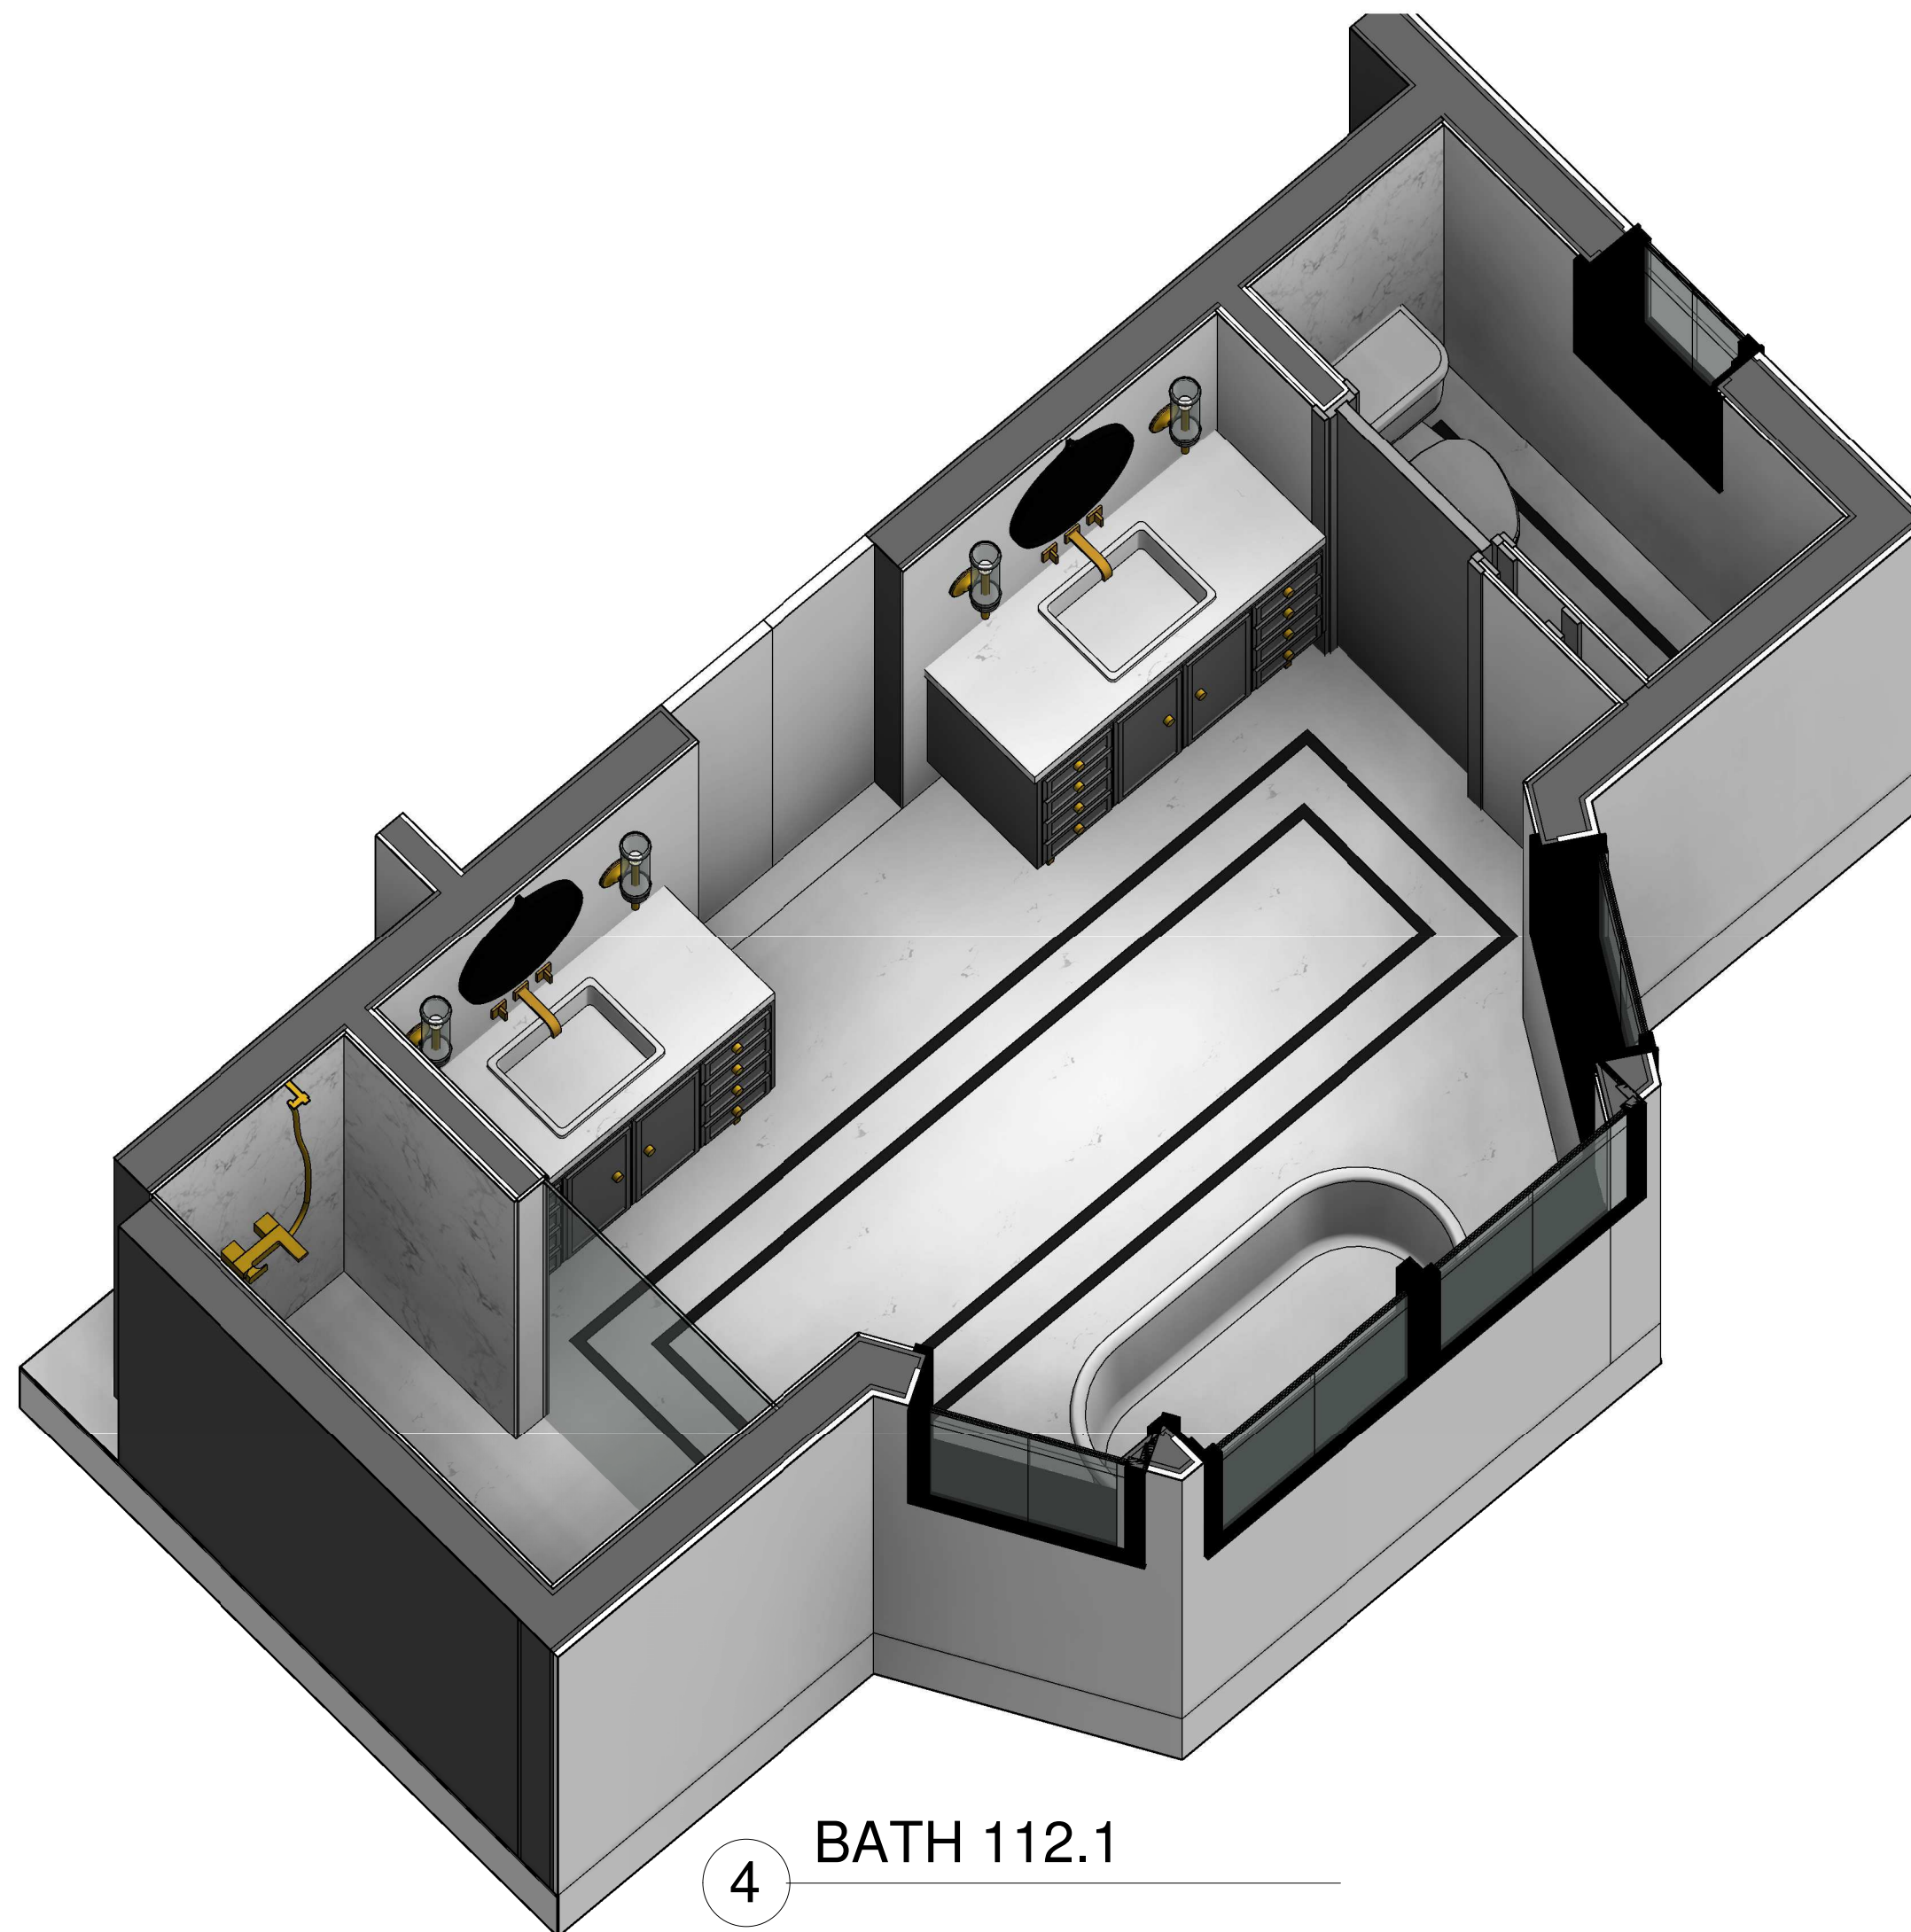

4 BATH 112.1

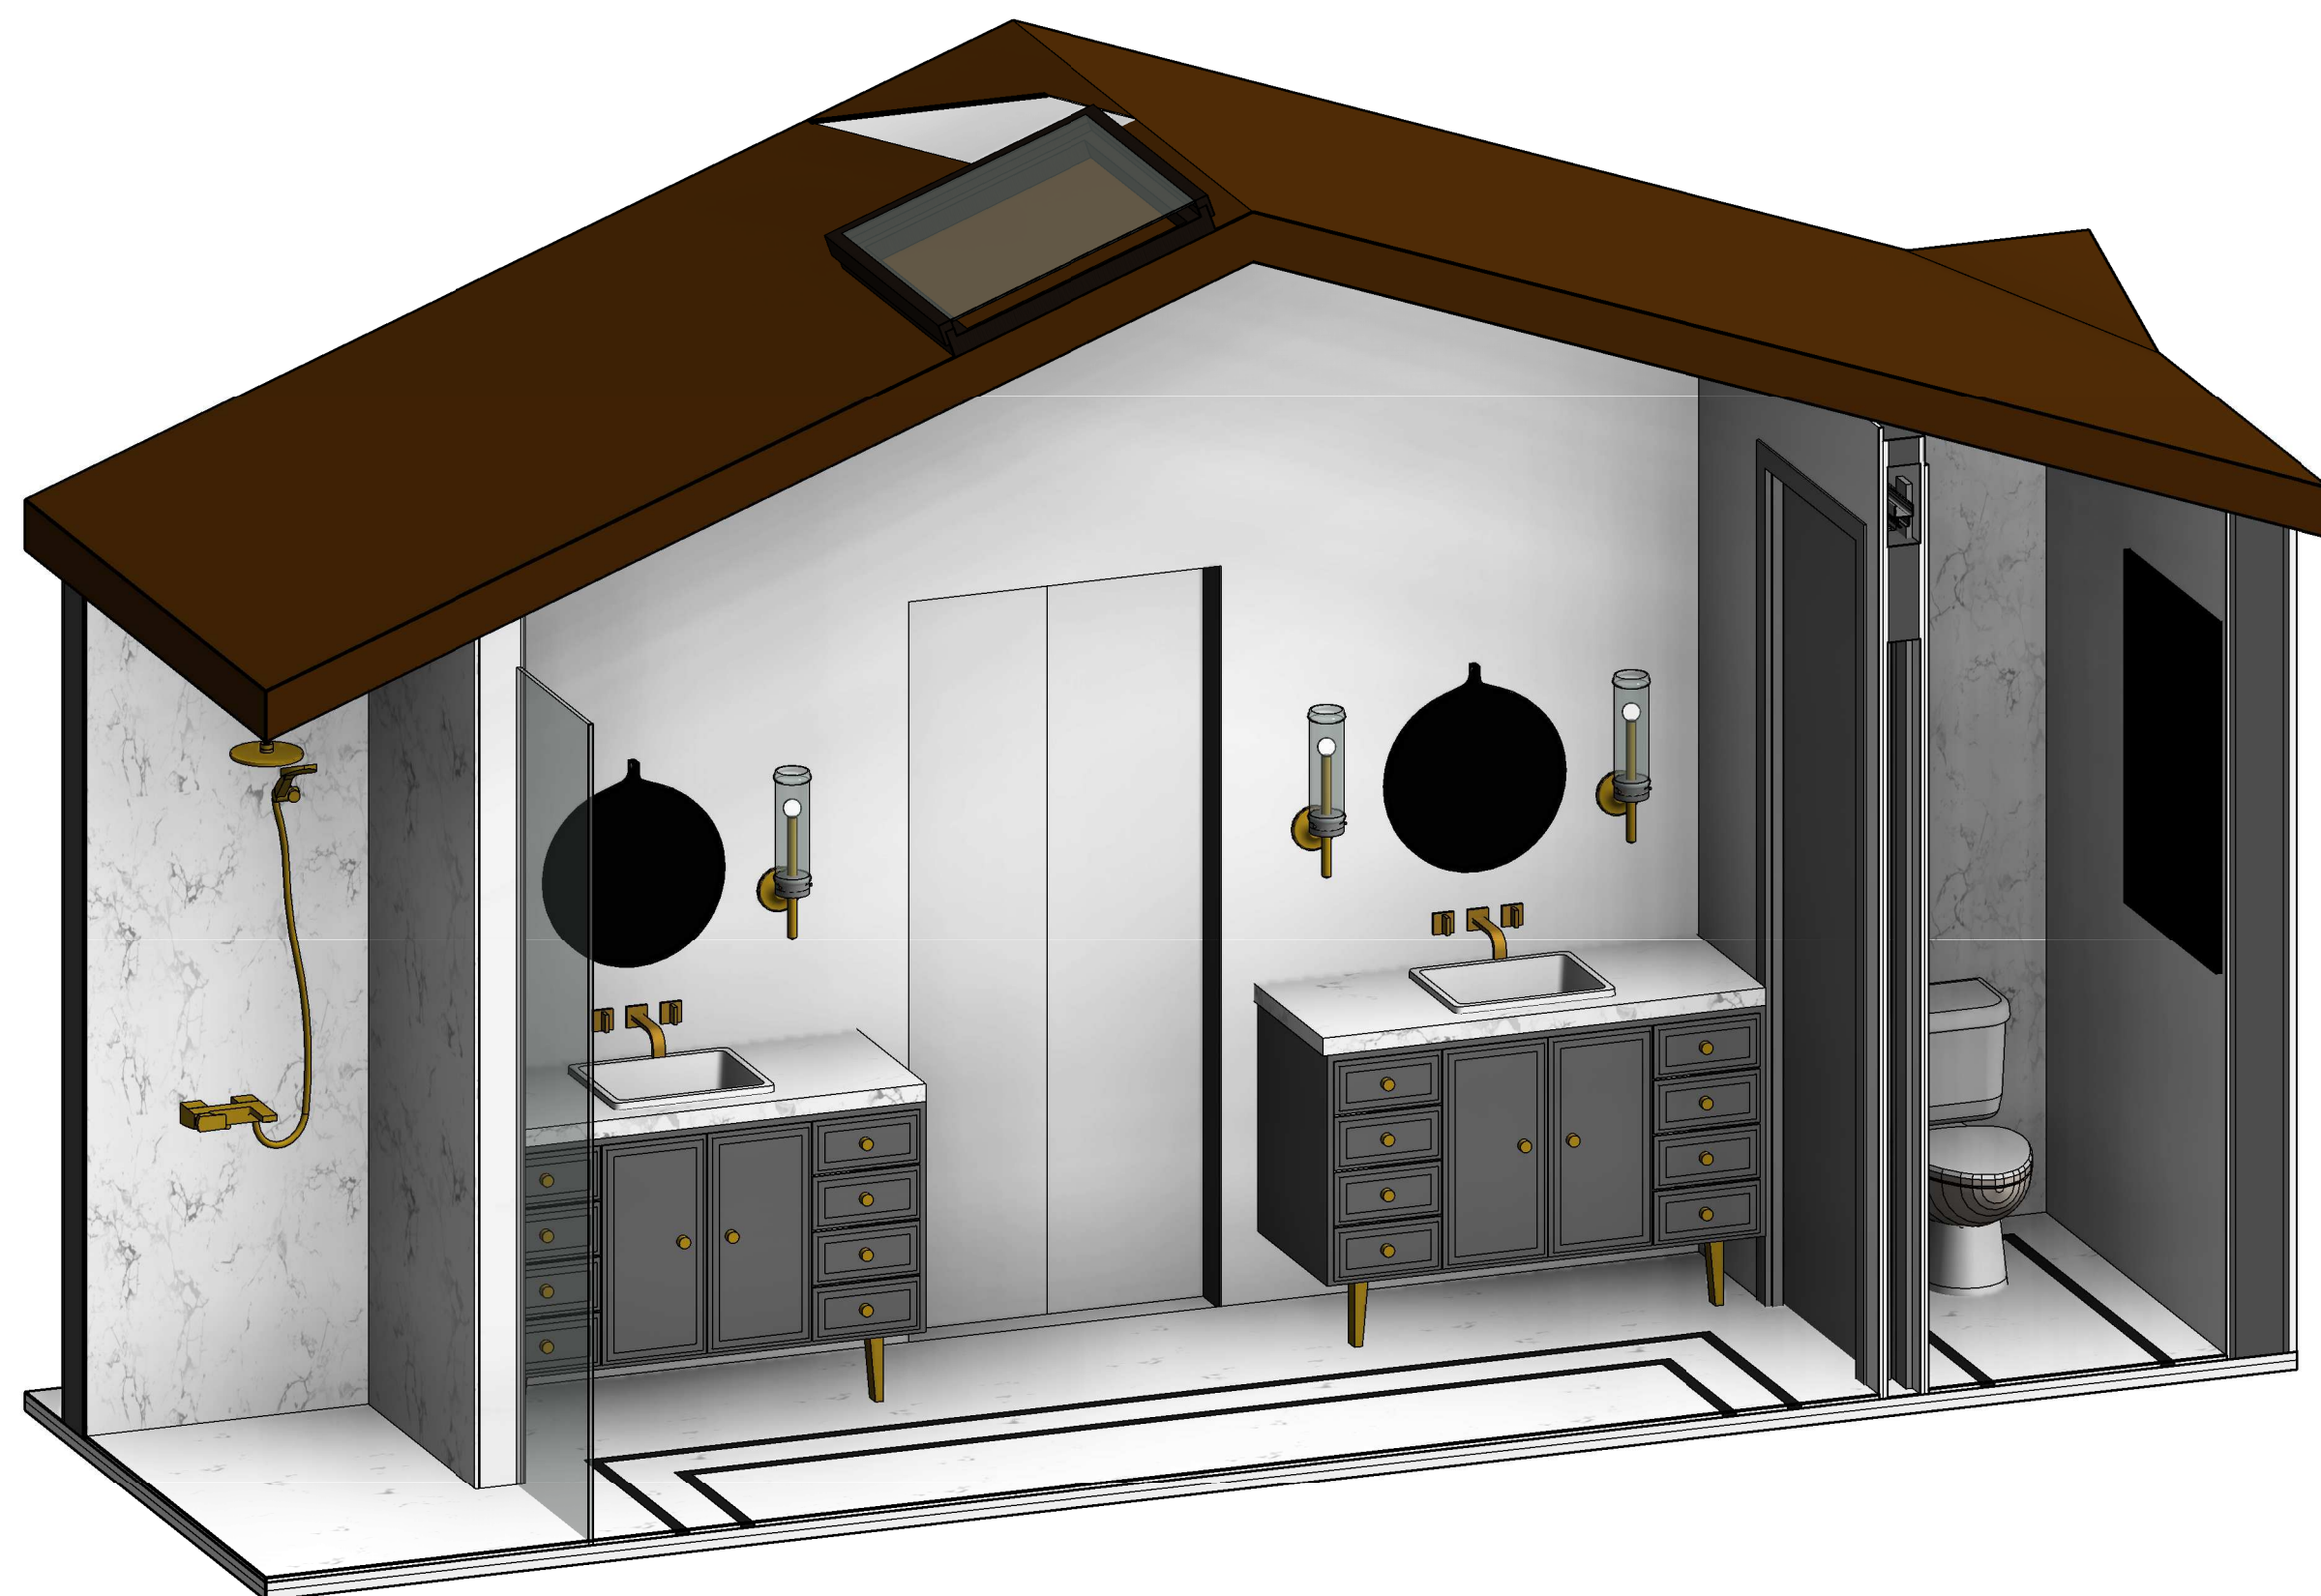

2 BATH 112.2

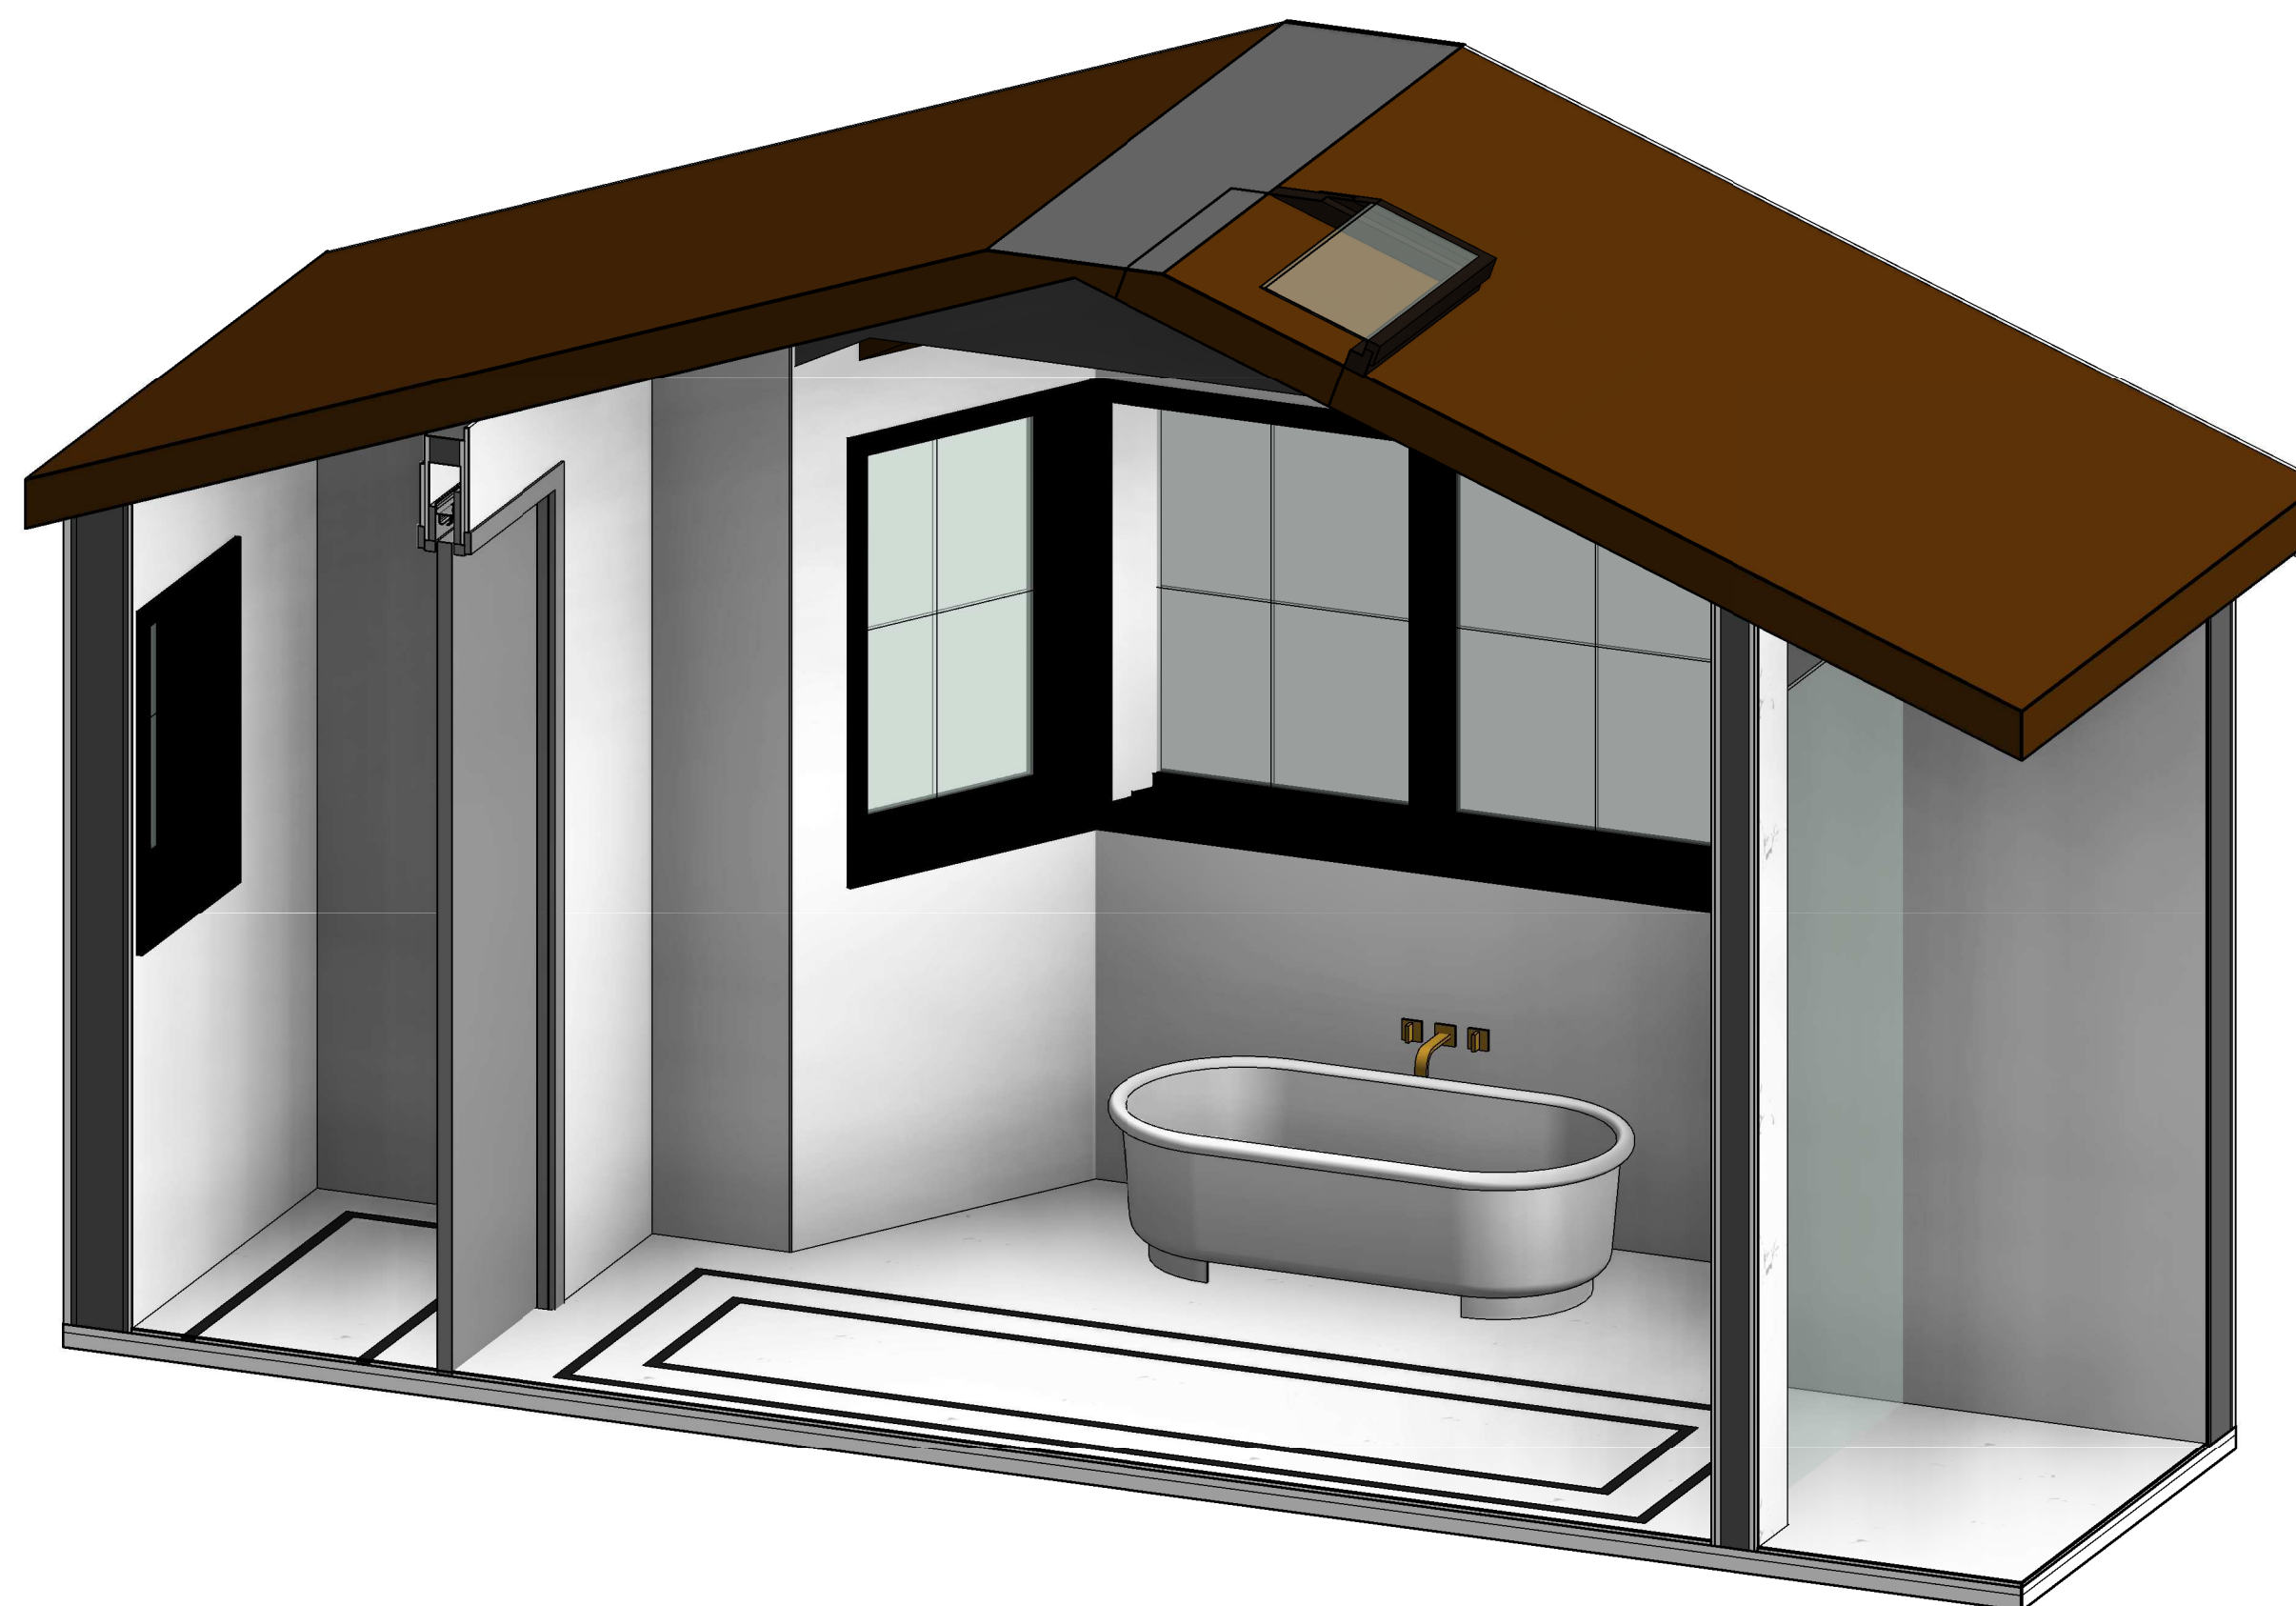

3 BATH 112.3


## KEY NOTE

- |     |   |
|-----|---|
| N1  | ADD GAS TO EXISTING FIRE PLACE                                  |
| N2  | REFURBISH EXISTING FIRE PLACE INTO 2 SIDED FIRE PLACE           |
| N3  | OUTDOOR BBQ   |
| N4  | NEW FLOORING  |
| N5  | REMOVE FLAT CEILING   |
| N6  | PROVIDE SKYLIGHT  |
| N7  | FLOATING SINK WITH VANITY                                       |
| N8  | NEW TUB   |
| N9  | NEW WATER CLOSET  |
| N10 | NEW SINK  |
| N11 | NEW BIDET   |
| N12 | GFCI OUTLET   |
| N13 | REFURBISH EXISTING WALL, PREP FOR NEW SHEAR WALL PER STRUCTURAL |
| N14 | 18" X 24" ROOF VENT 72 SQ.INCH EACH                             |
| E1  | EXISTING SKYLIGHT TO REMAIN                                     |


## LEGEND

- |  |                                   |
|--|-----------------------------------|
|  | FIXTURE TAG REFER TO A8.9 & A8.10 |
|  | FINISH TAG REFER TO A8.9          |




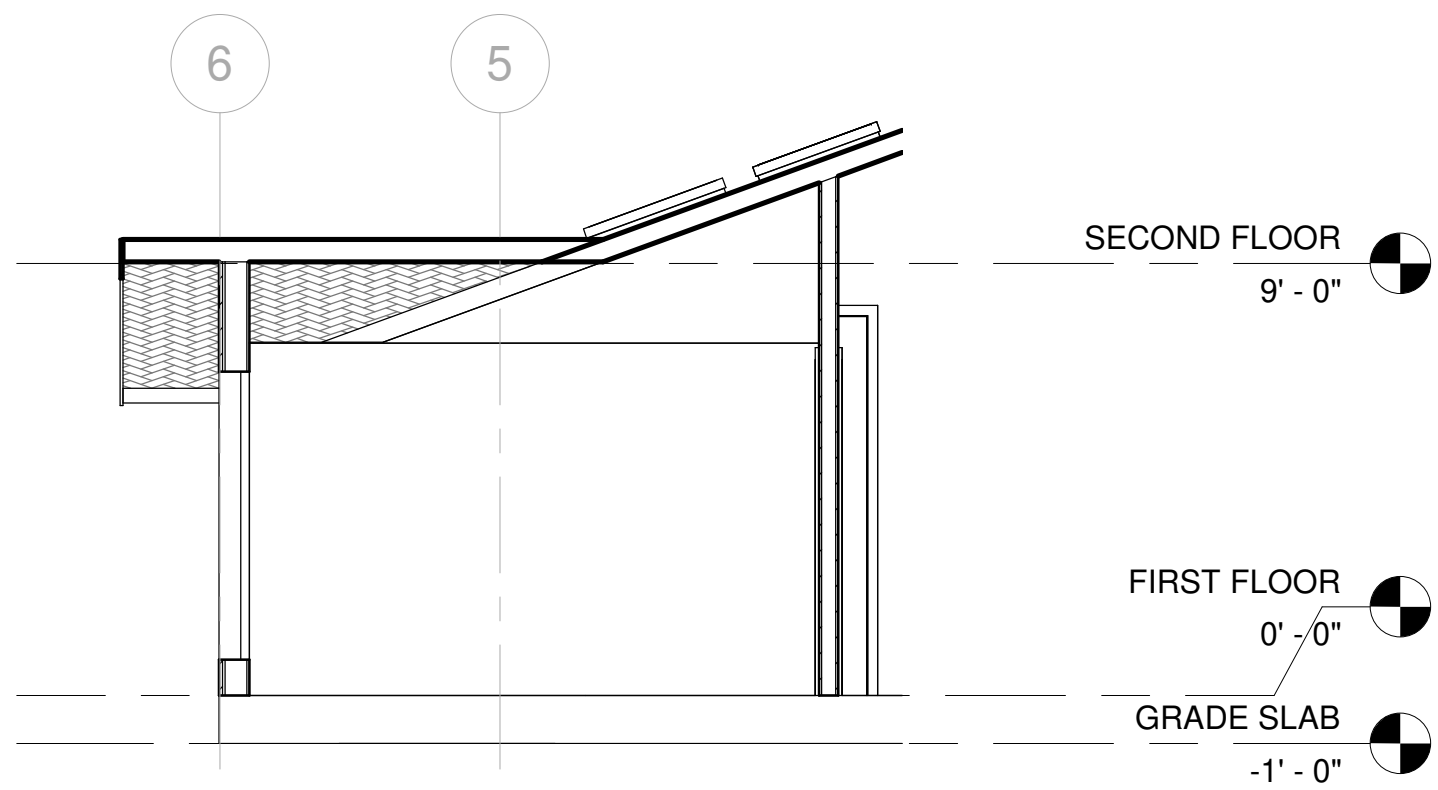


2 OFFICE ELEVATION - A  
1/4" = 1'-0"

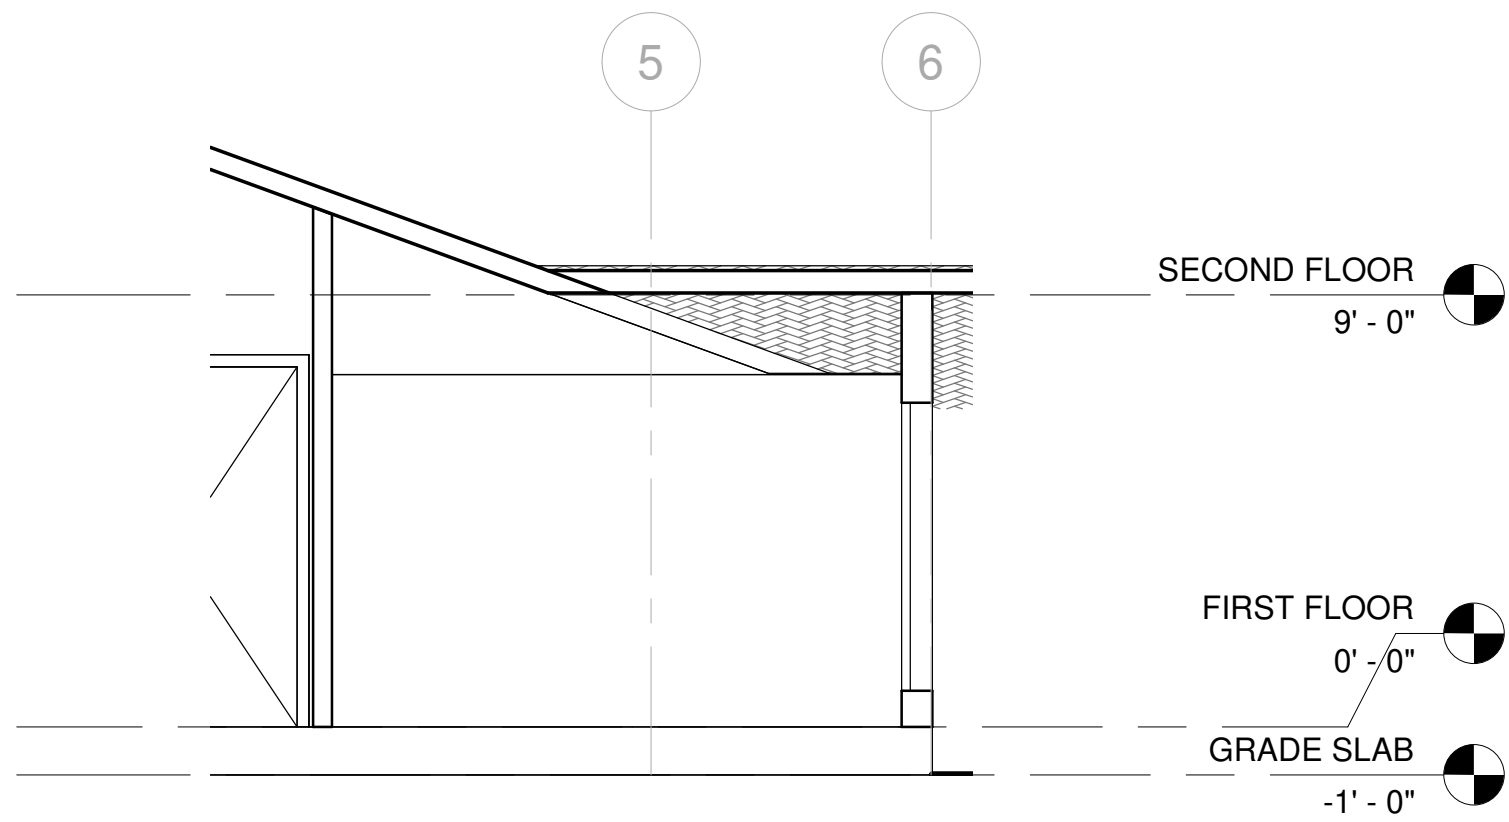


4 OFFICE ELEVATION - C  
1/4" = 1'-0"

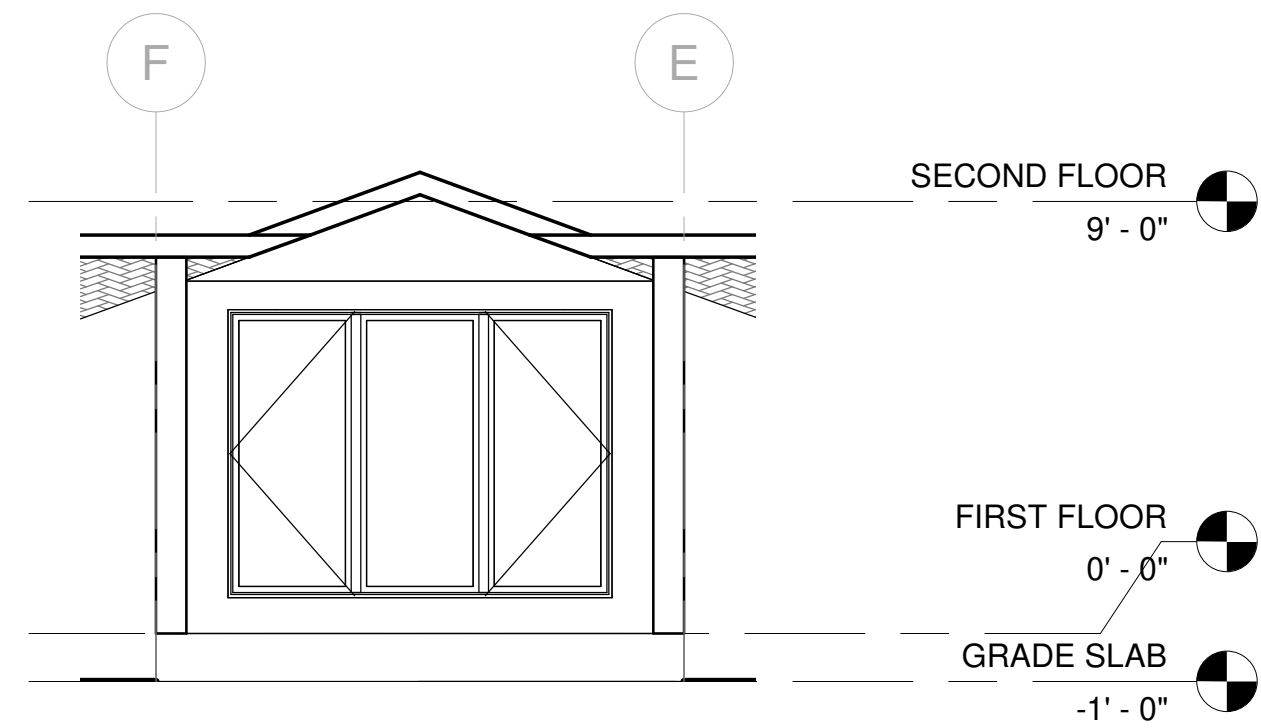

3 OFFICE ELEVATION - B  
1/4" = 1'-0"

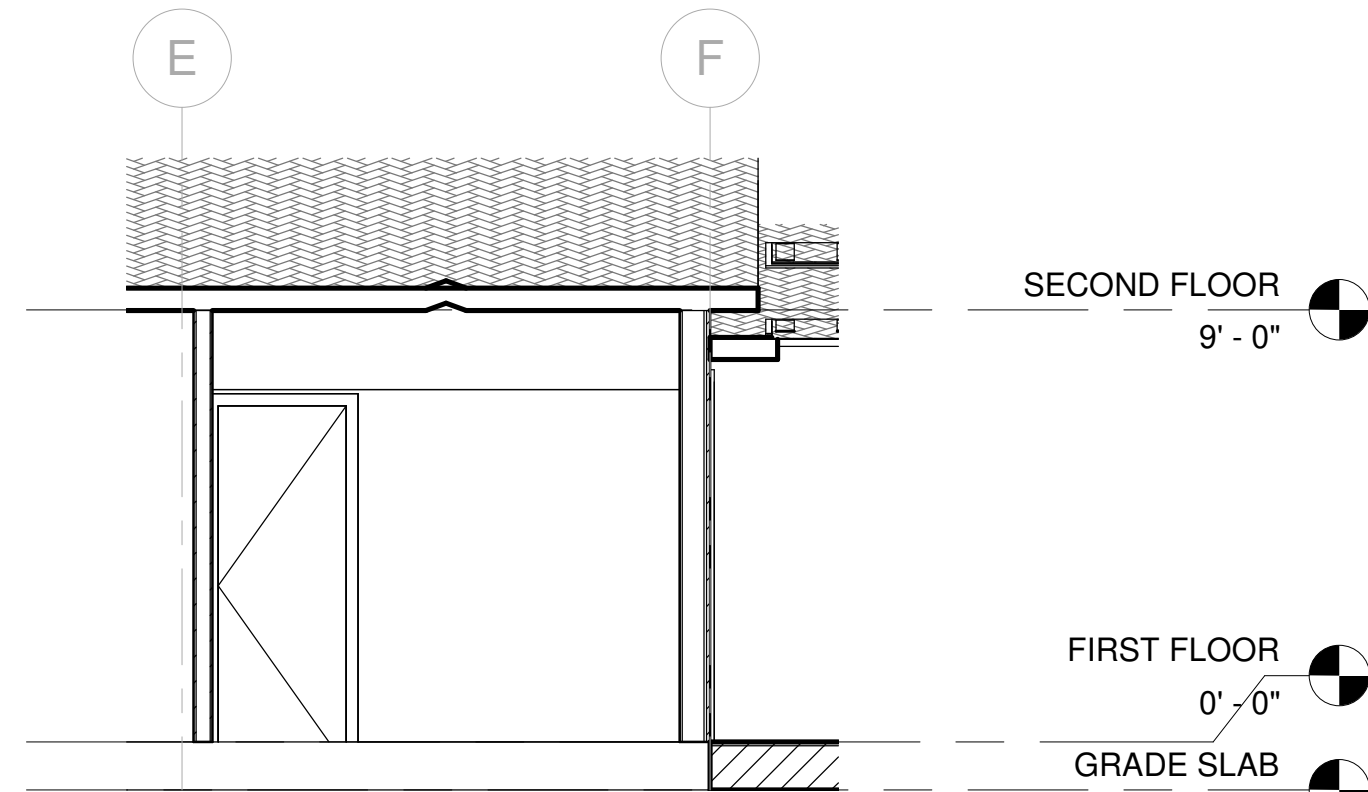

5 OFFICE ELEVATION - D  
1/4" = 1'-0"

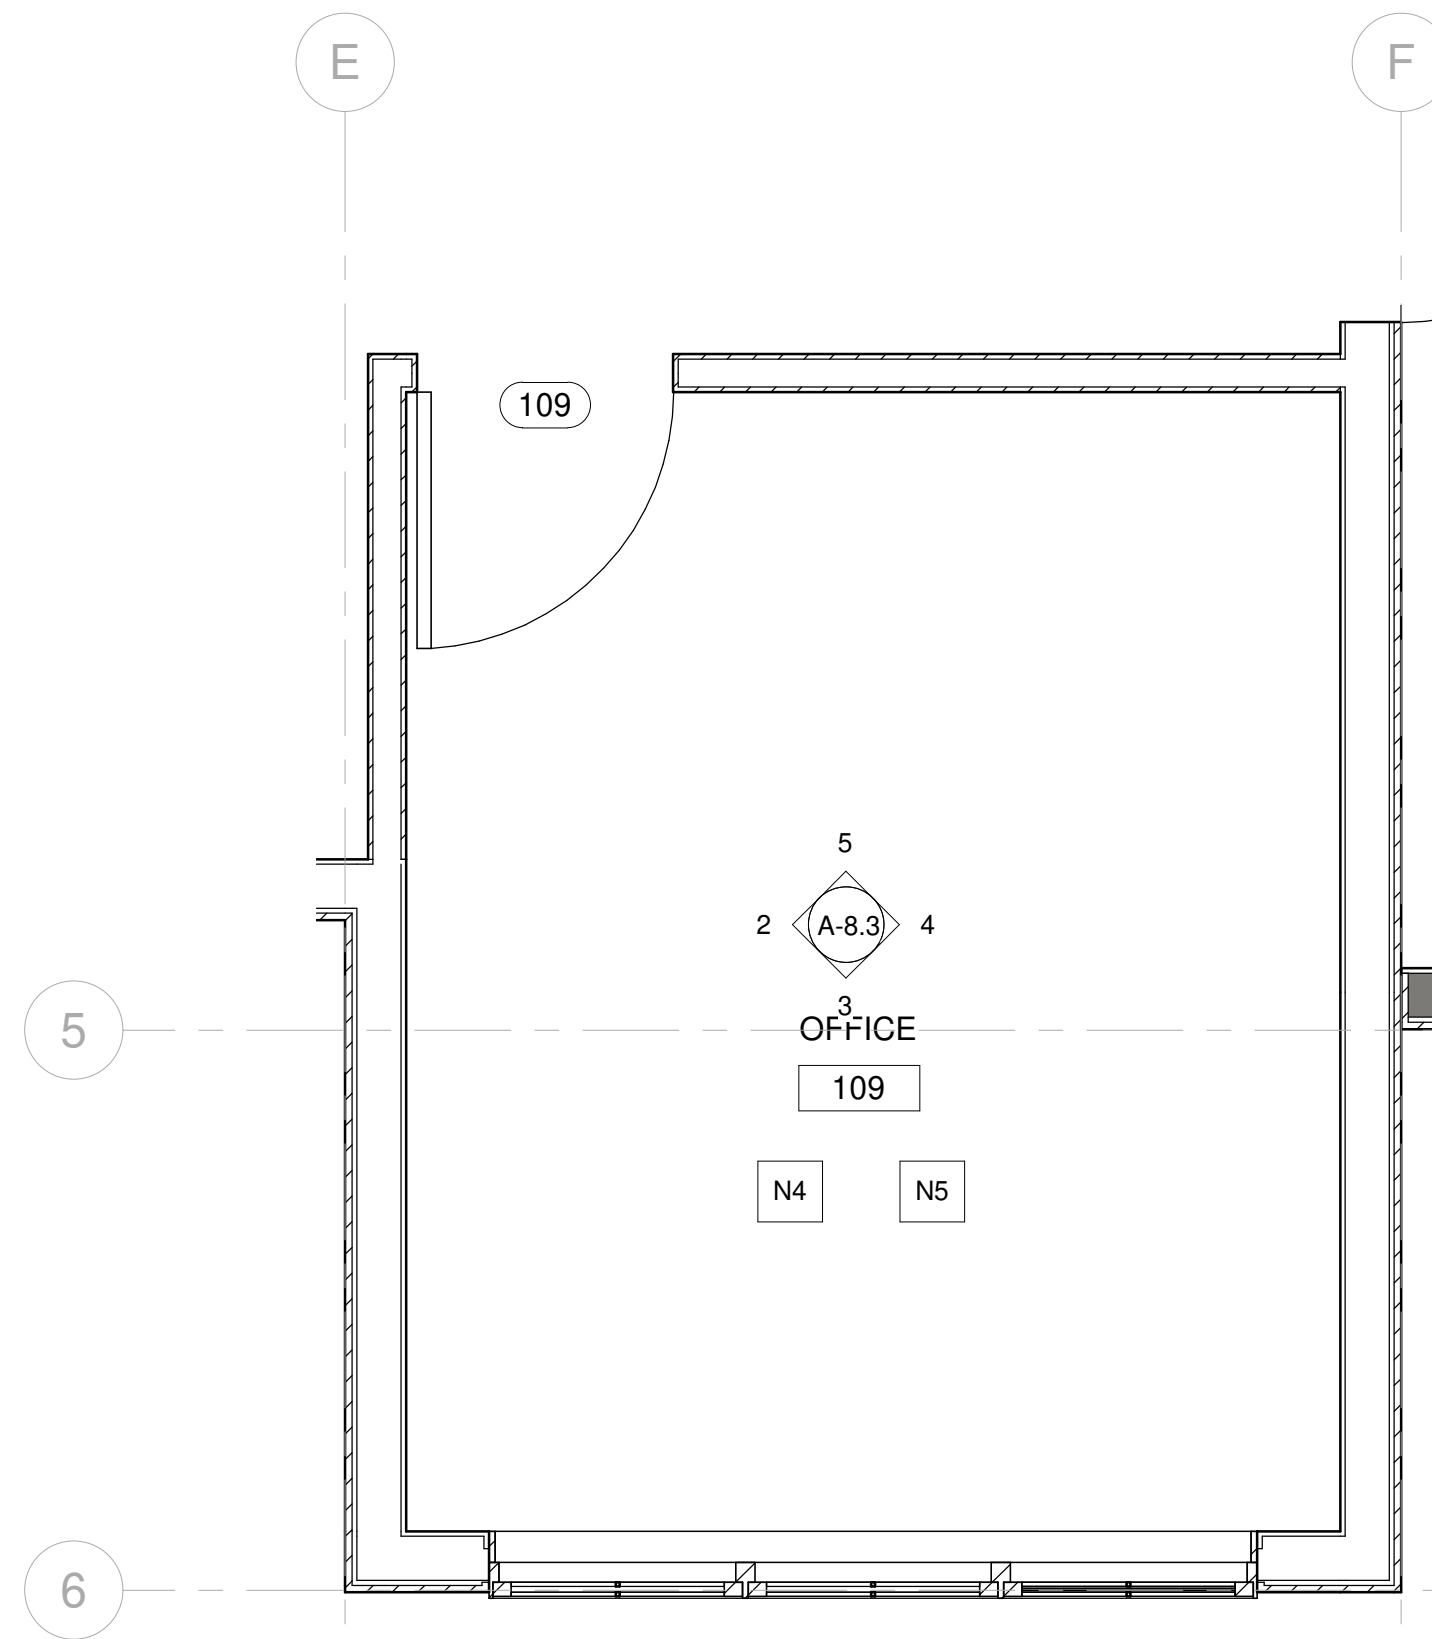


1 OFFICE 109 ENLARGED PLAN  
1/2" = 1'-0"

## KEY NOTE


N1	ADD GAS TO EXISTING FIRE PLACE
N2	REFURBISH EXISTING FIRE PLACE INTO 2 SIDED FIRE PLACE
N3	OUTDOOR BBQ
N4	NEW FLOORING
N5	REMOVE FLAT CEILING
N6	PROVIDE SKYLIGHT
N7	FLOATING SINK WITH VANITY
N8	NEW TUB
N9	NEW WATER CLOSET
N10	NEW SINK
N11	NEW BIDET
N12	GFCI OUTLET
N13	REFURBISH EXISTING WALL, PREP FOR NEW SHEAR WALL PER STRUCTURAL
N14	18" X 24" ROOF VENT 72 SQ. INCH EACH
E1	EXISTING SKYLIGHT TO REMAIN

## LEGEND

	FIXTURE TAG REFER TO A8.9 & A8.10
	FINISH TAG REFER TO A8.9

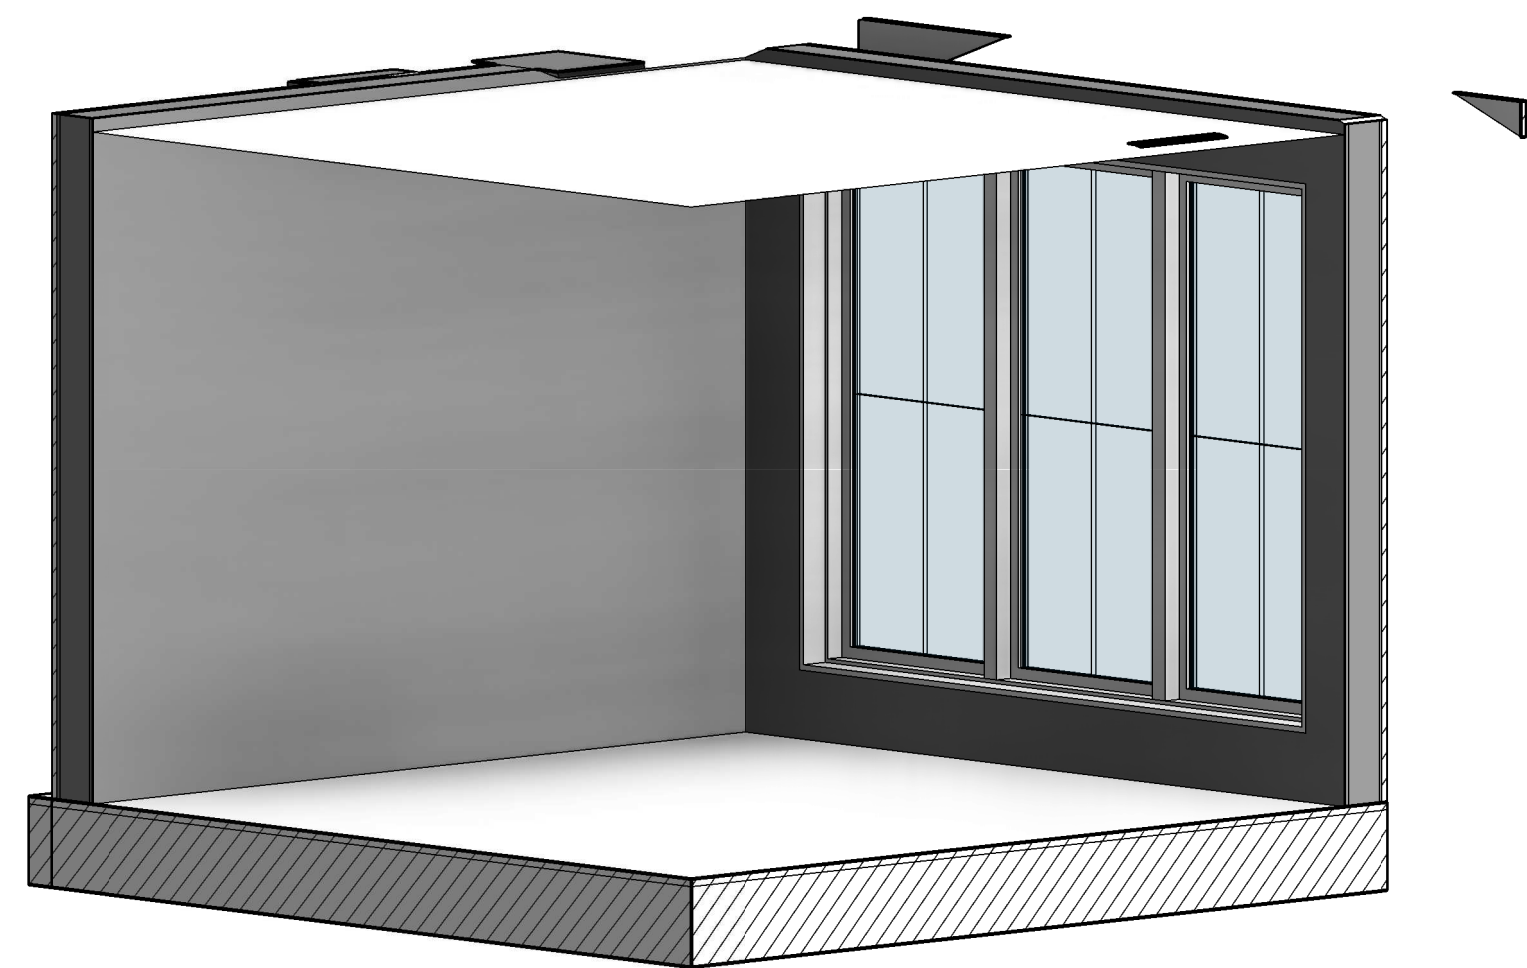

6 OFFICE 109

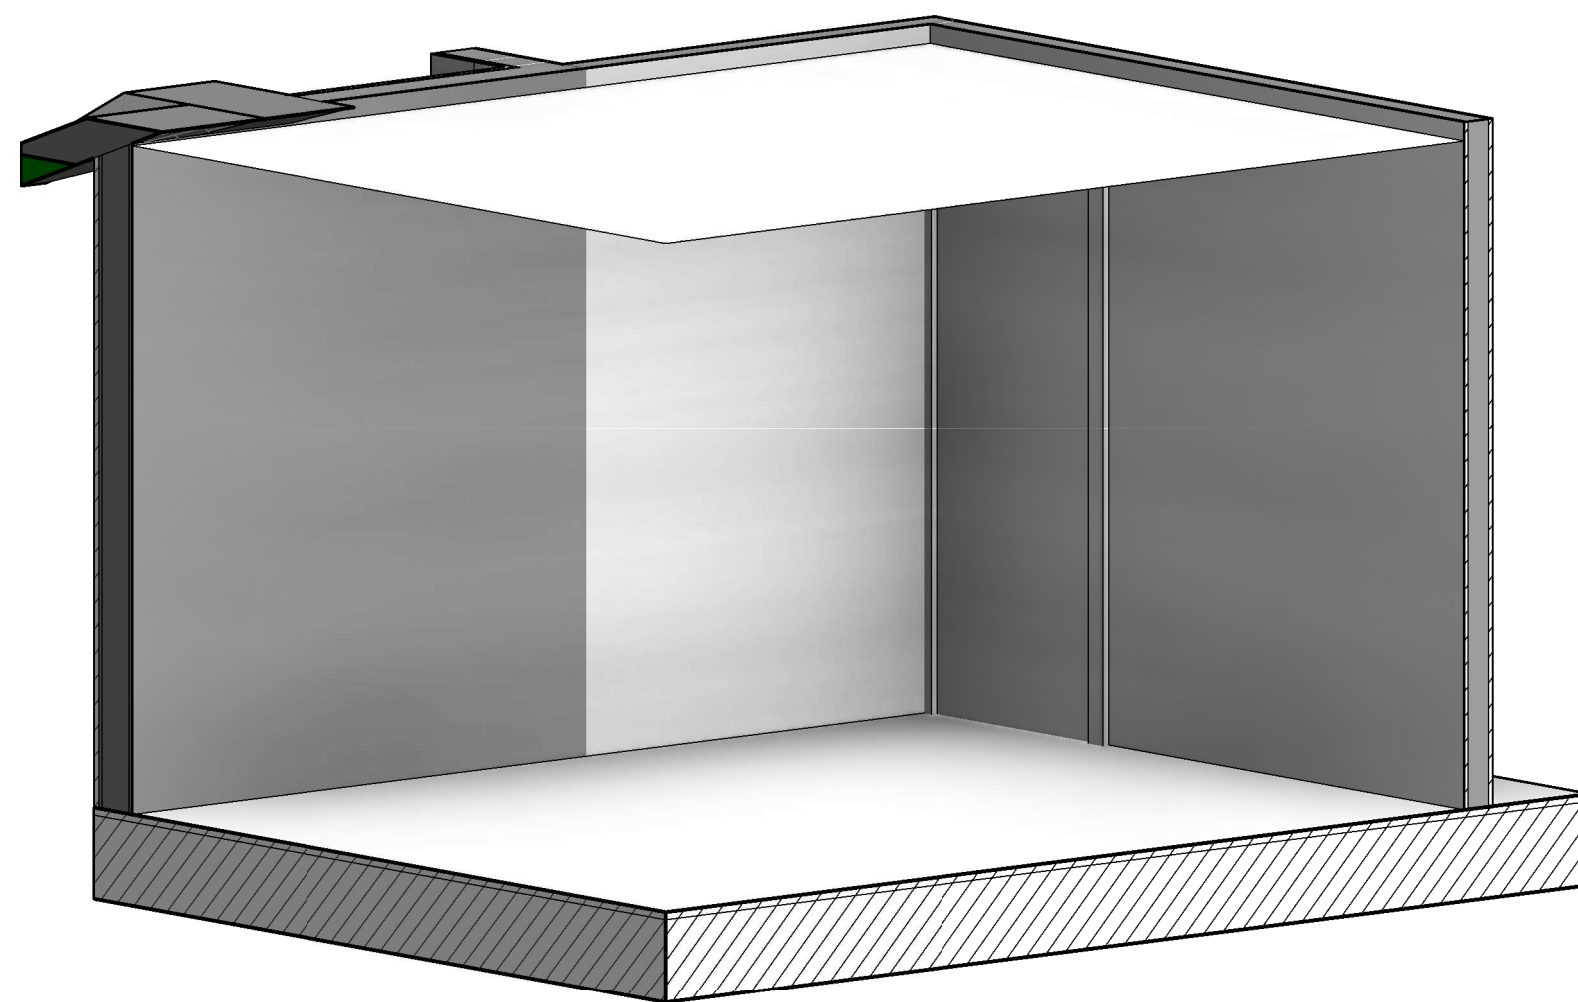

7 OFFICE 109.2

**DESIGN EVEREST**  
CONSULTING ENGINEERS

ENLARGED DETAILS-OFFICE 109  
**AHMED RENOVATION**  
**ALINA AHMED**  
LOT 15  
1081 NOTTINGHAM WAY  
LOS ALTOS, CA 94024


DELTA DESCRIPTION:	CITY SUBMITTAL
DATE:	22/09/17
No.	1

DATE:	22/09/17
SCALE:	As indicated
DRAWN BY :	
CKD BY:	
PROJECT :	202107199


DRAWING NO.

A-8.3




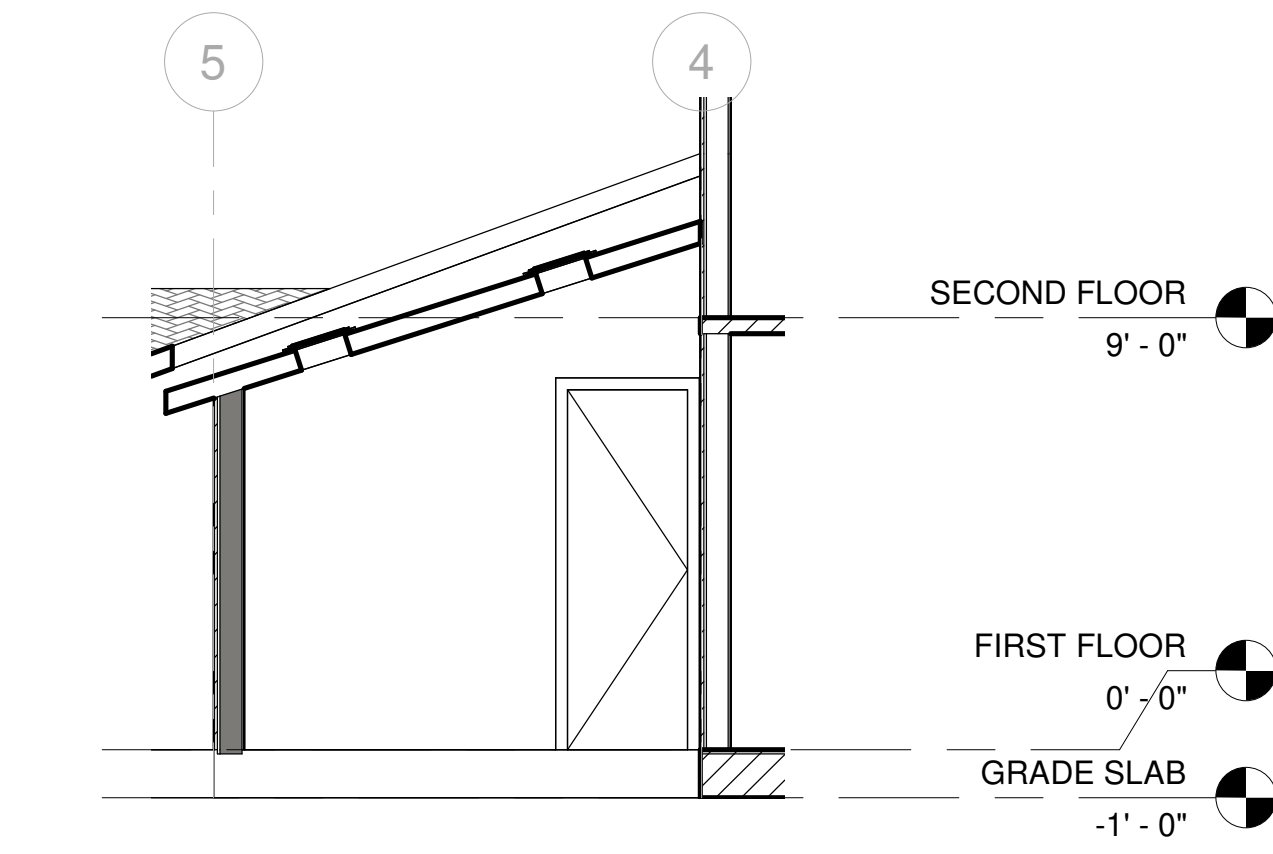


3 READING ROOM ELEVATION - A  
1/4" = 1'-0"

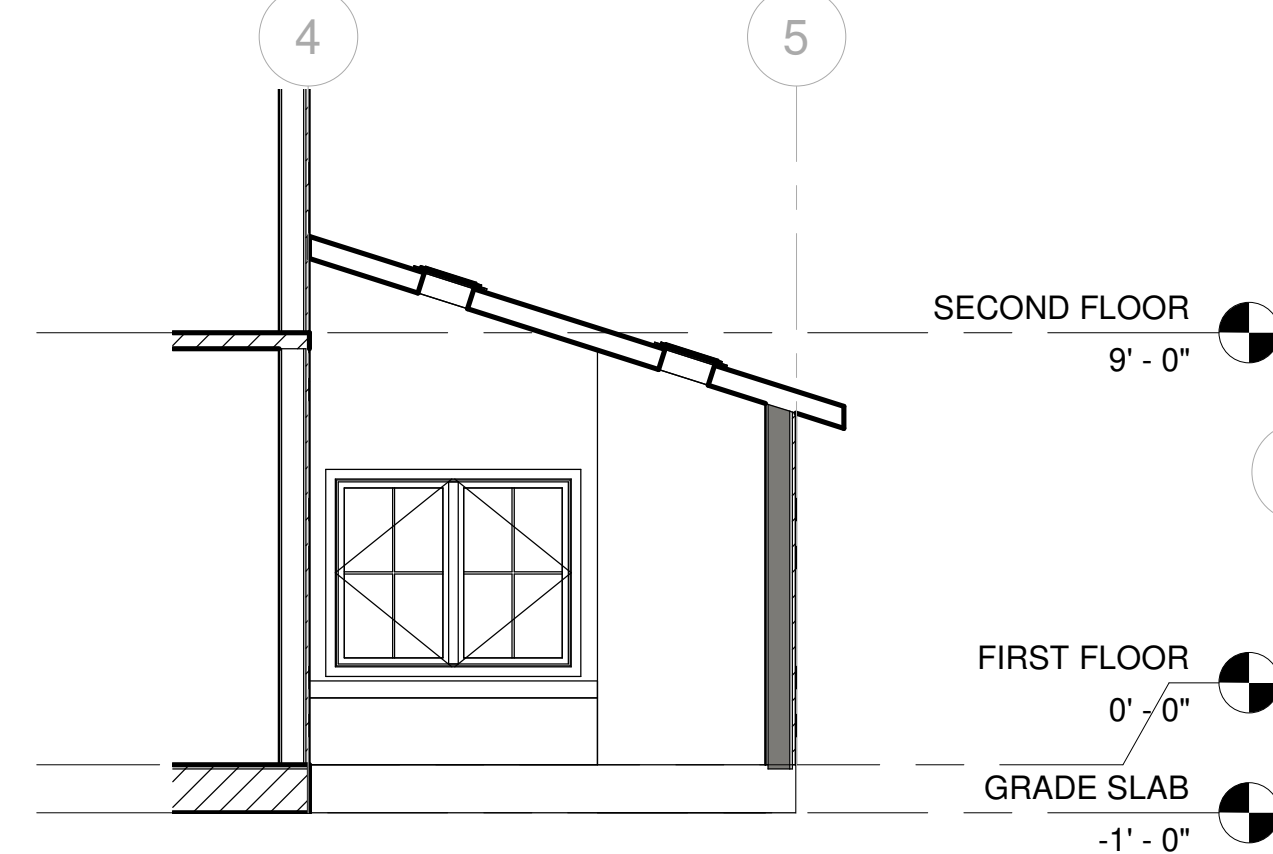


4 READING ROOM ELEVATION - B  
1/4" = 1'-0"

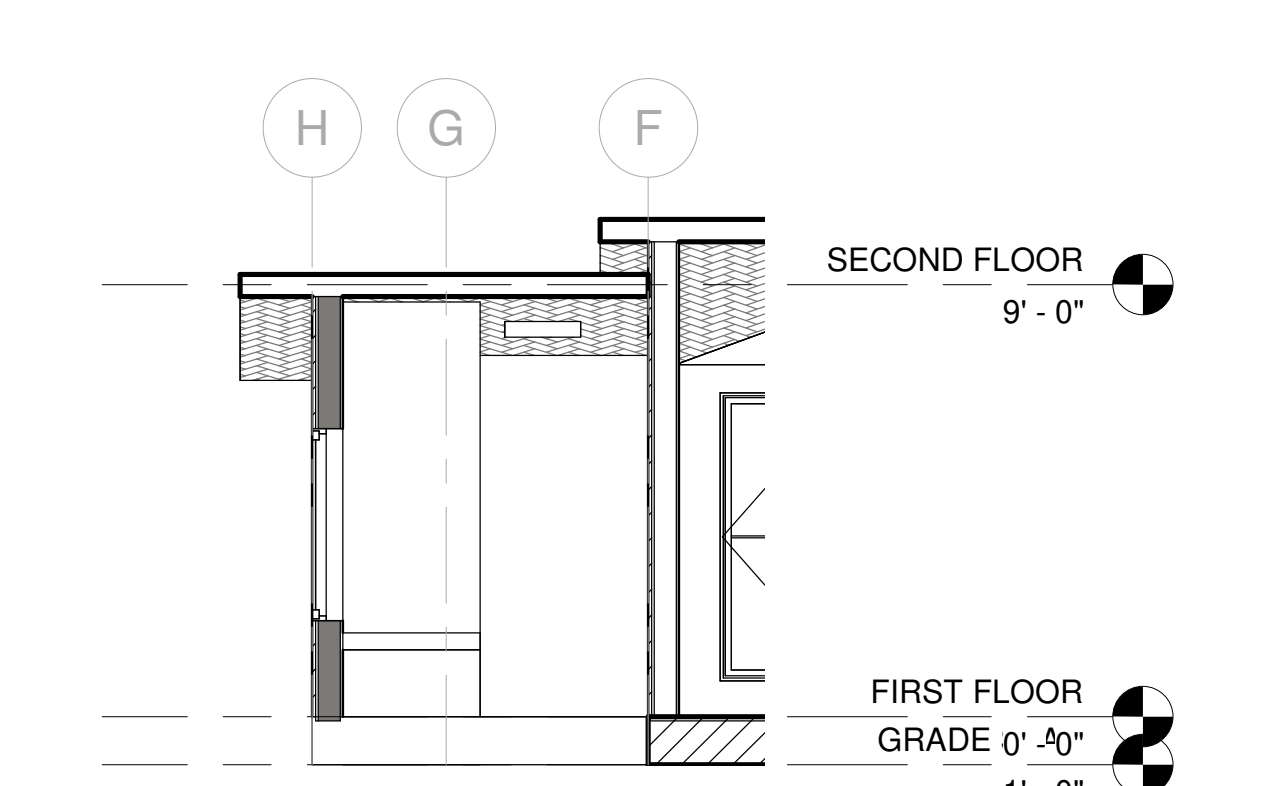


5 READING ROOM ELEVATION - C  
1/4" = 1'-0"

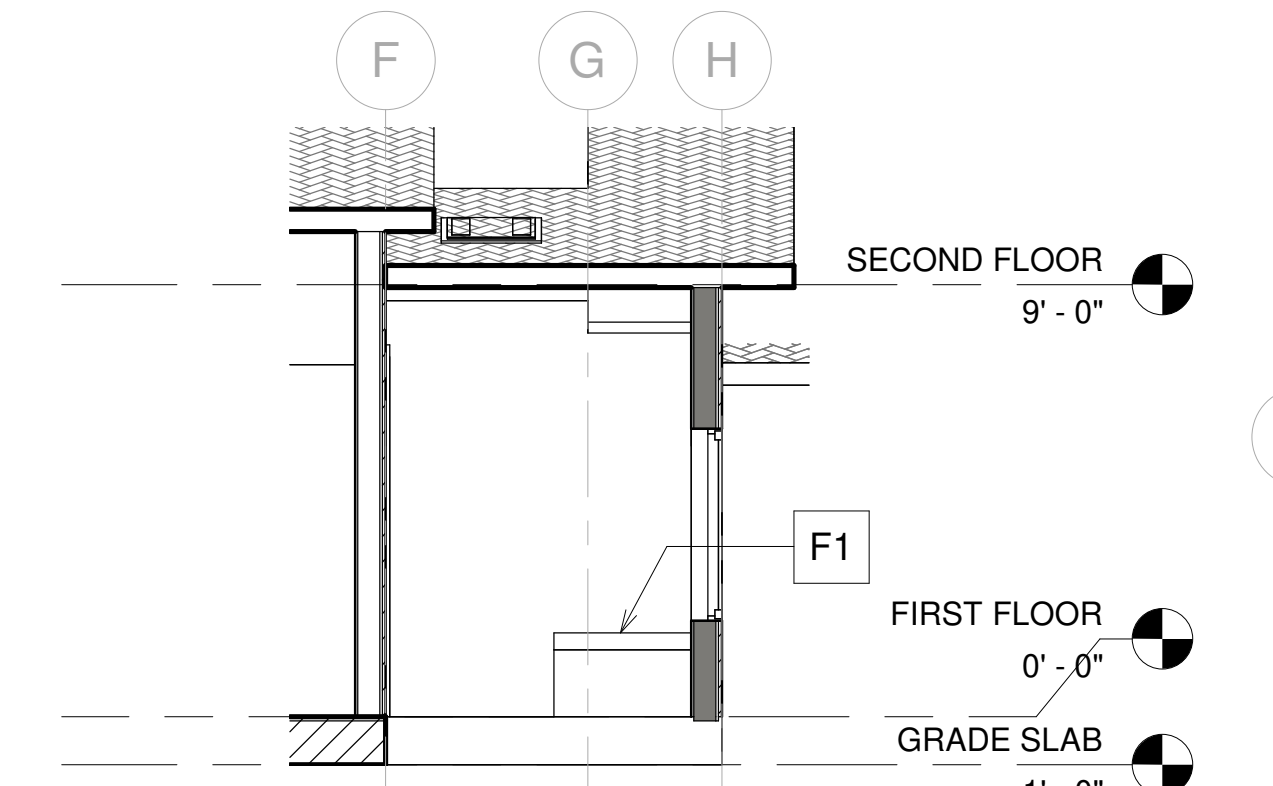

6 READING ROOM ELEVATION - D  
1/4" = 1'-0"

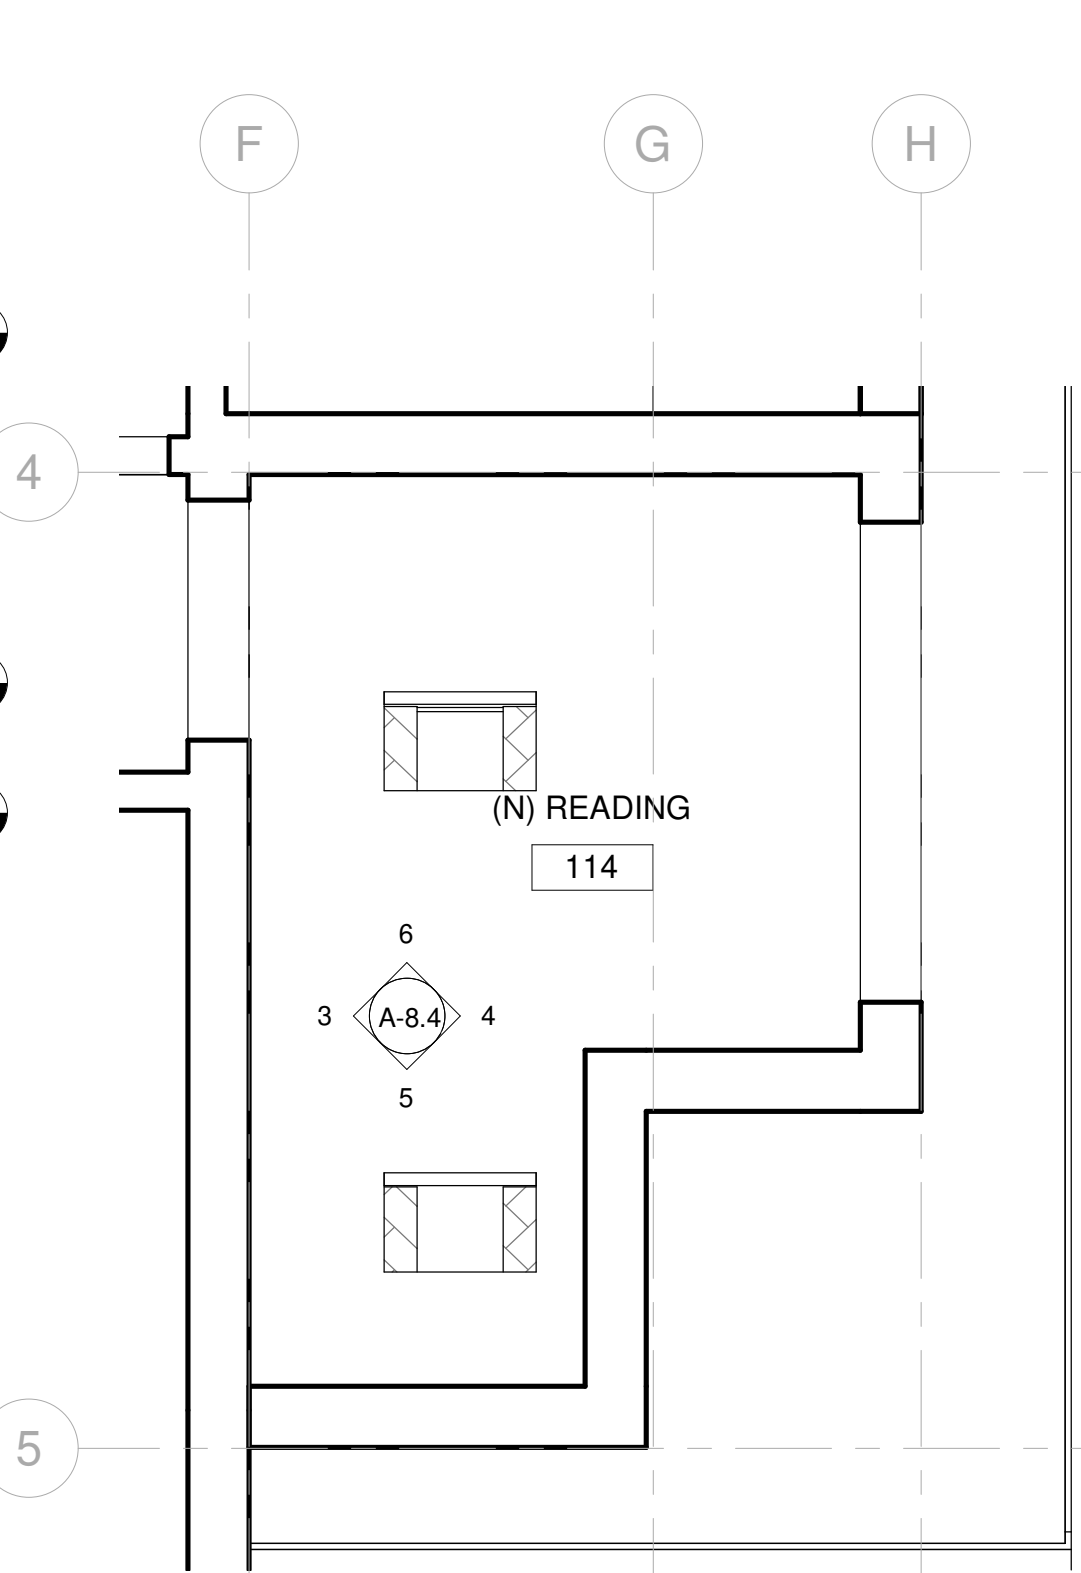

2 READING ROOM RCP  
1/2" = 1'-0"

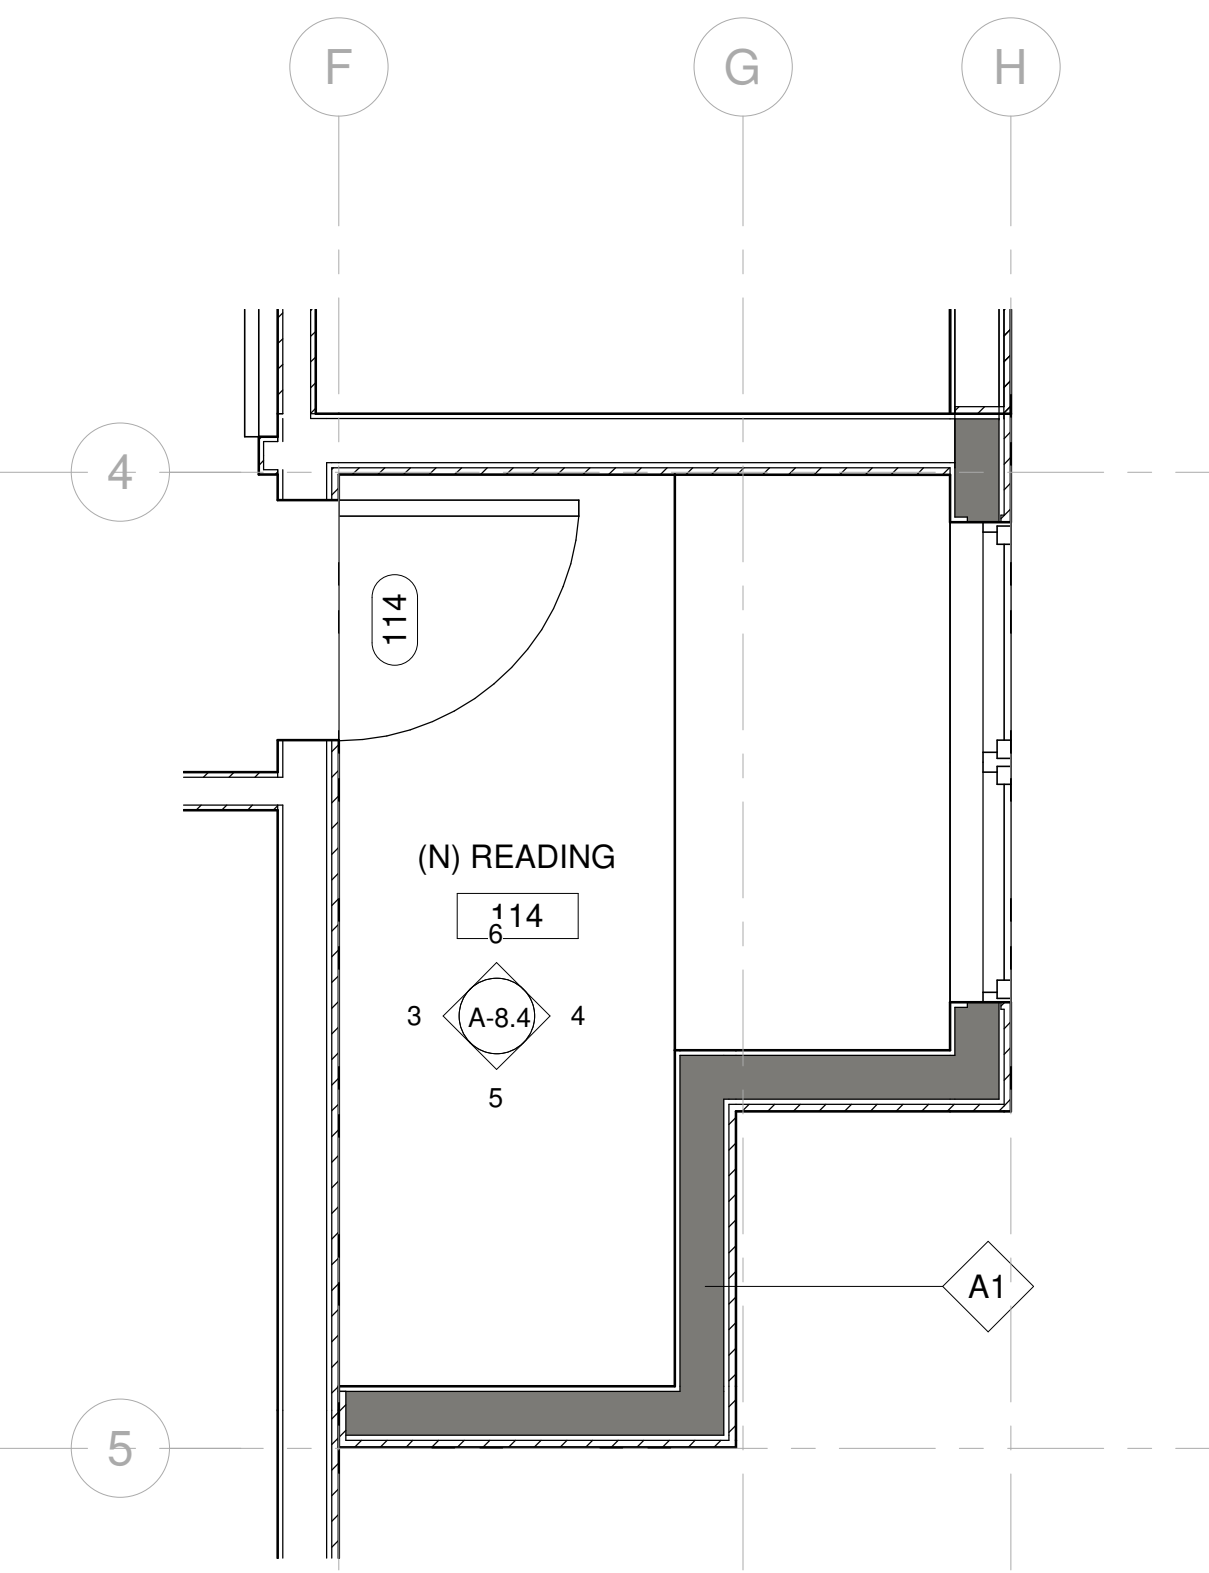

1 READING 114 ENLARGED PLAN  
1/2" = 1'-0"

KEY NOTE	
N1	ADD GAS TO EXISTING FIRE PLACE
N2	REFURBISH EXISTING FIRE PLACE INTO 2 SIDED FIRE PLACE
N3	OUTDOOR BBQ
N4	NEW FLOORING
N5	REMOVE FLAT CEILING
N6	PROVIDE SKYLIGHT
N7	FLOATING SINK WITH VANITY
N8	NEW TUB
N9	NEW WATER CLOSET
N10	NEW SINK
N11	NEW BIDET
N12	GFCI OUTLET
N13	REFURBISH EXISTING WALL, PREP FOR NEW SHEAR WALL PER STRUCTURAL
N14	18" X 24" ROOF VENT 72 SQ. INCH EACH
E1	EXISTING SKYLIGHT TO REMAIN

LEGEND	
	FIXTURE TAG REFER TO A8.9 & A8.10
	FINISH TAG REFER TO A8.9

DESIGN EVEREST  
CONSULTING ENGINEERS  
365 FLOWER LANE  
MOUNTAIN VIEW, CA 94043  
PHONE: (888) 311-3015 FAX: (650) 695-1801

ENLARGED DETAILS - READING 114  
AHMED RENOVATION  
ALINA AHMED  
LOT 15  
1081 NOTTINGHAM WAY  
LOS ALTOS, CA 94024


DATE:	22/09/17
DELTA DESCRIPTION:	CITY SUBMITTAL
No.	1
No.	2
No.	3
No.	4

DATE:	22/09/17
SCALE:	As indicated
DRAWN BY :	
CKD BY:	
PROJECT :	202107199

DRAWING NO.  
A-8.4




8 READING 114.2

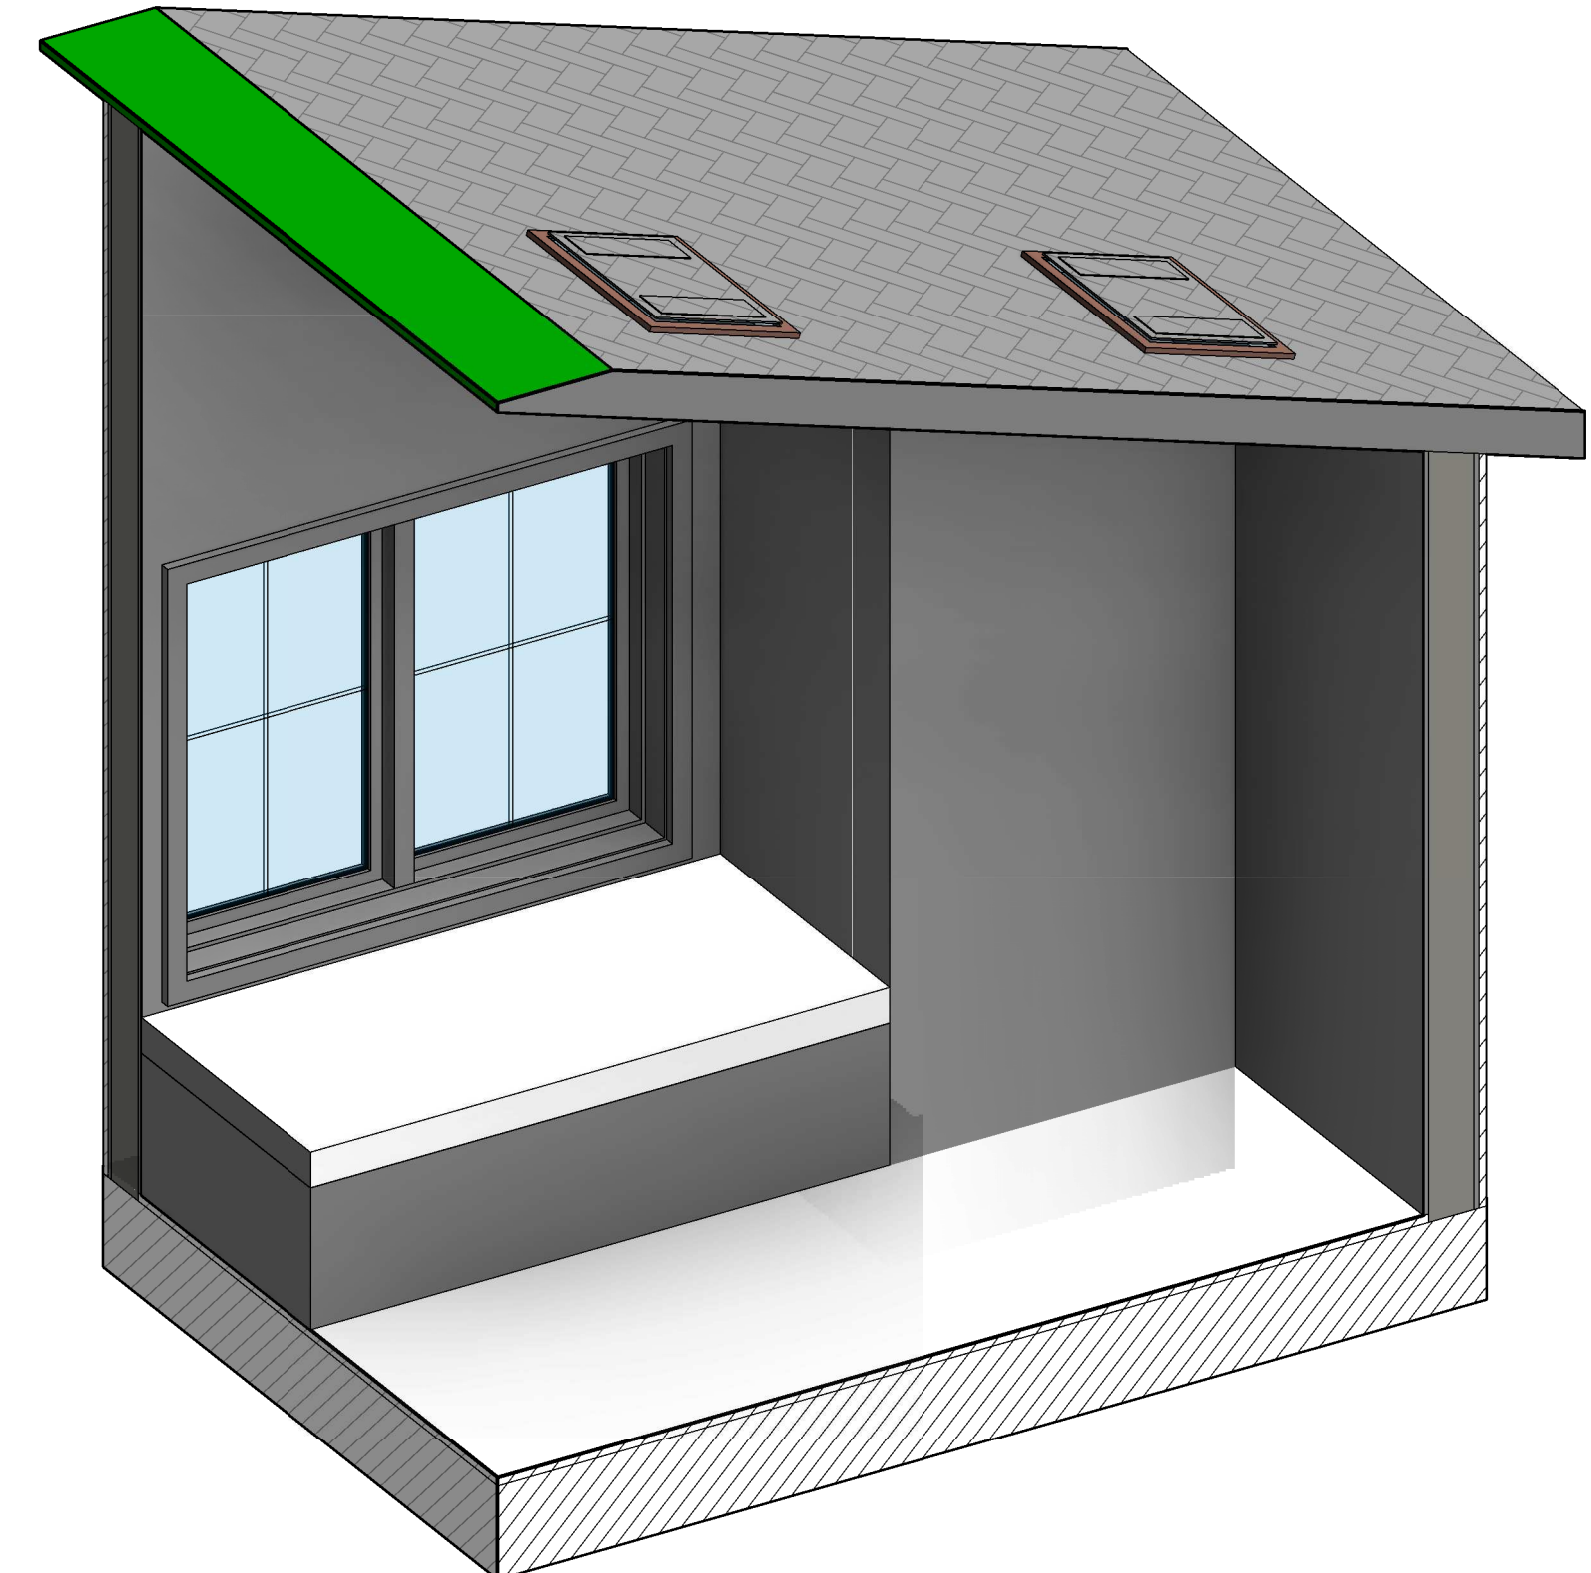


7 READING 114.1




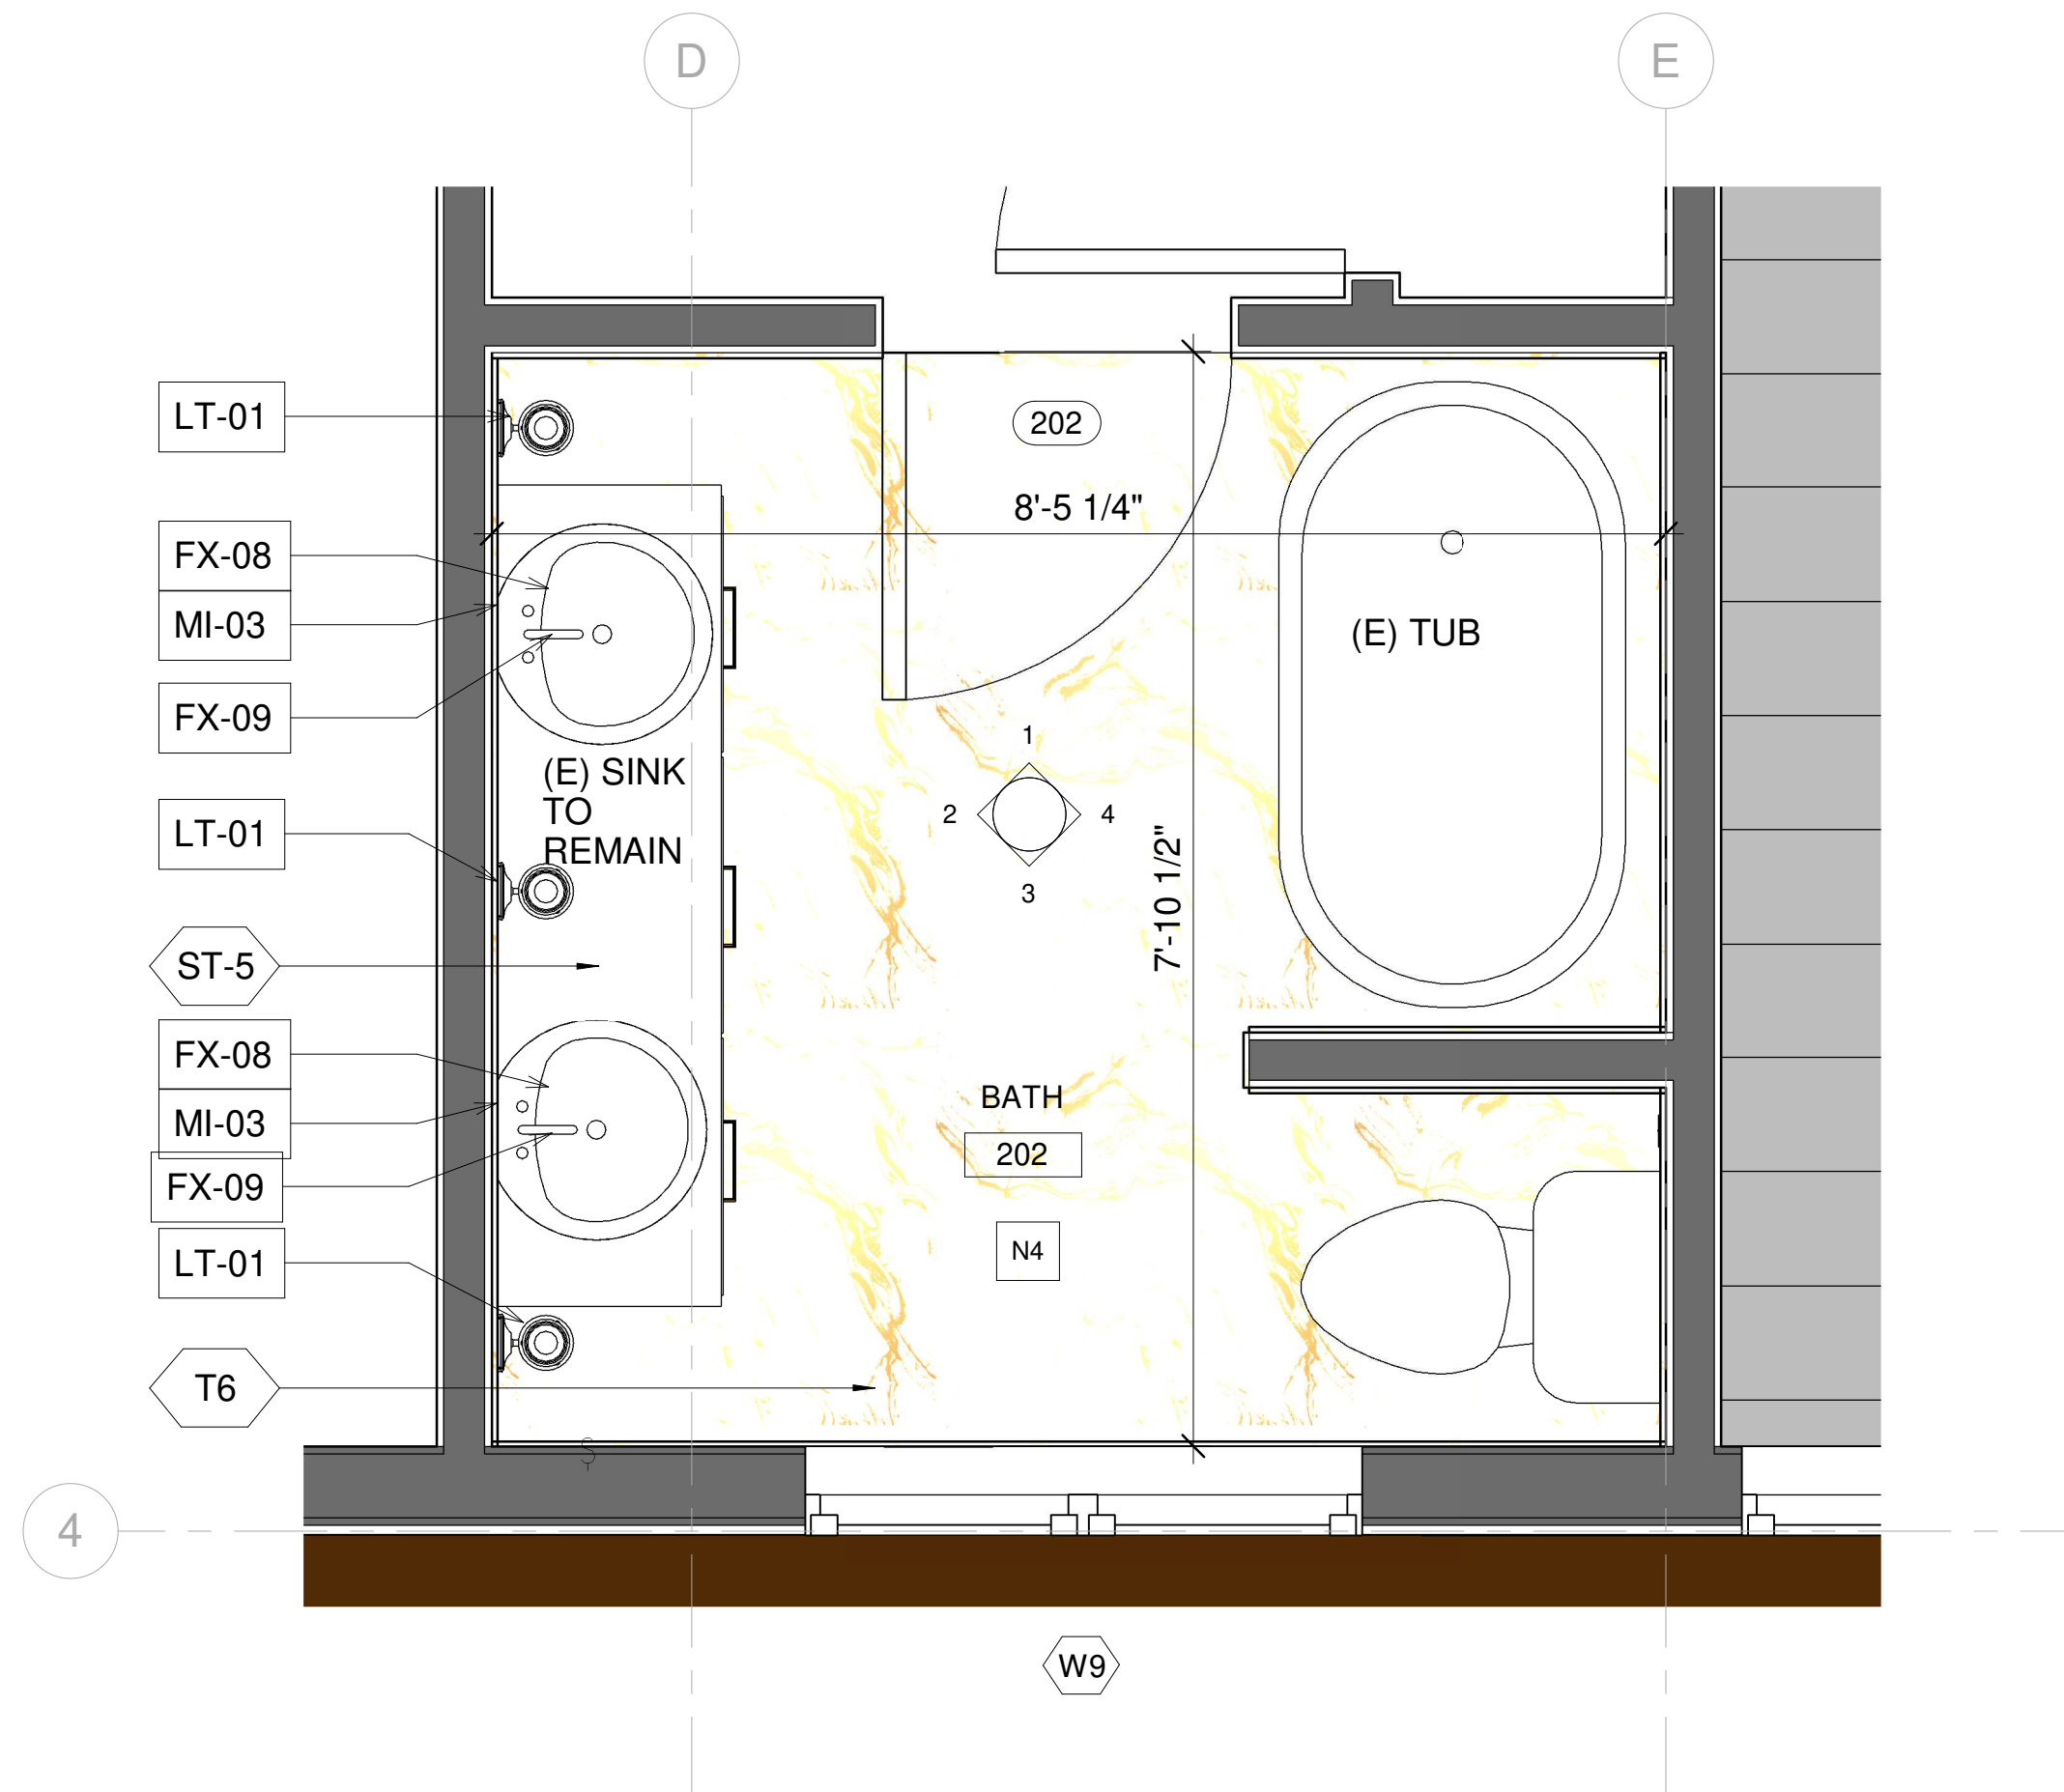


1 BATH 202 ENLARGED PLAN  
3/4" = 1'-0"

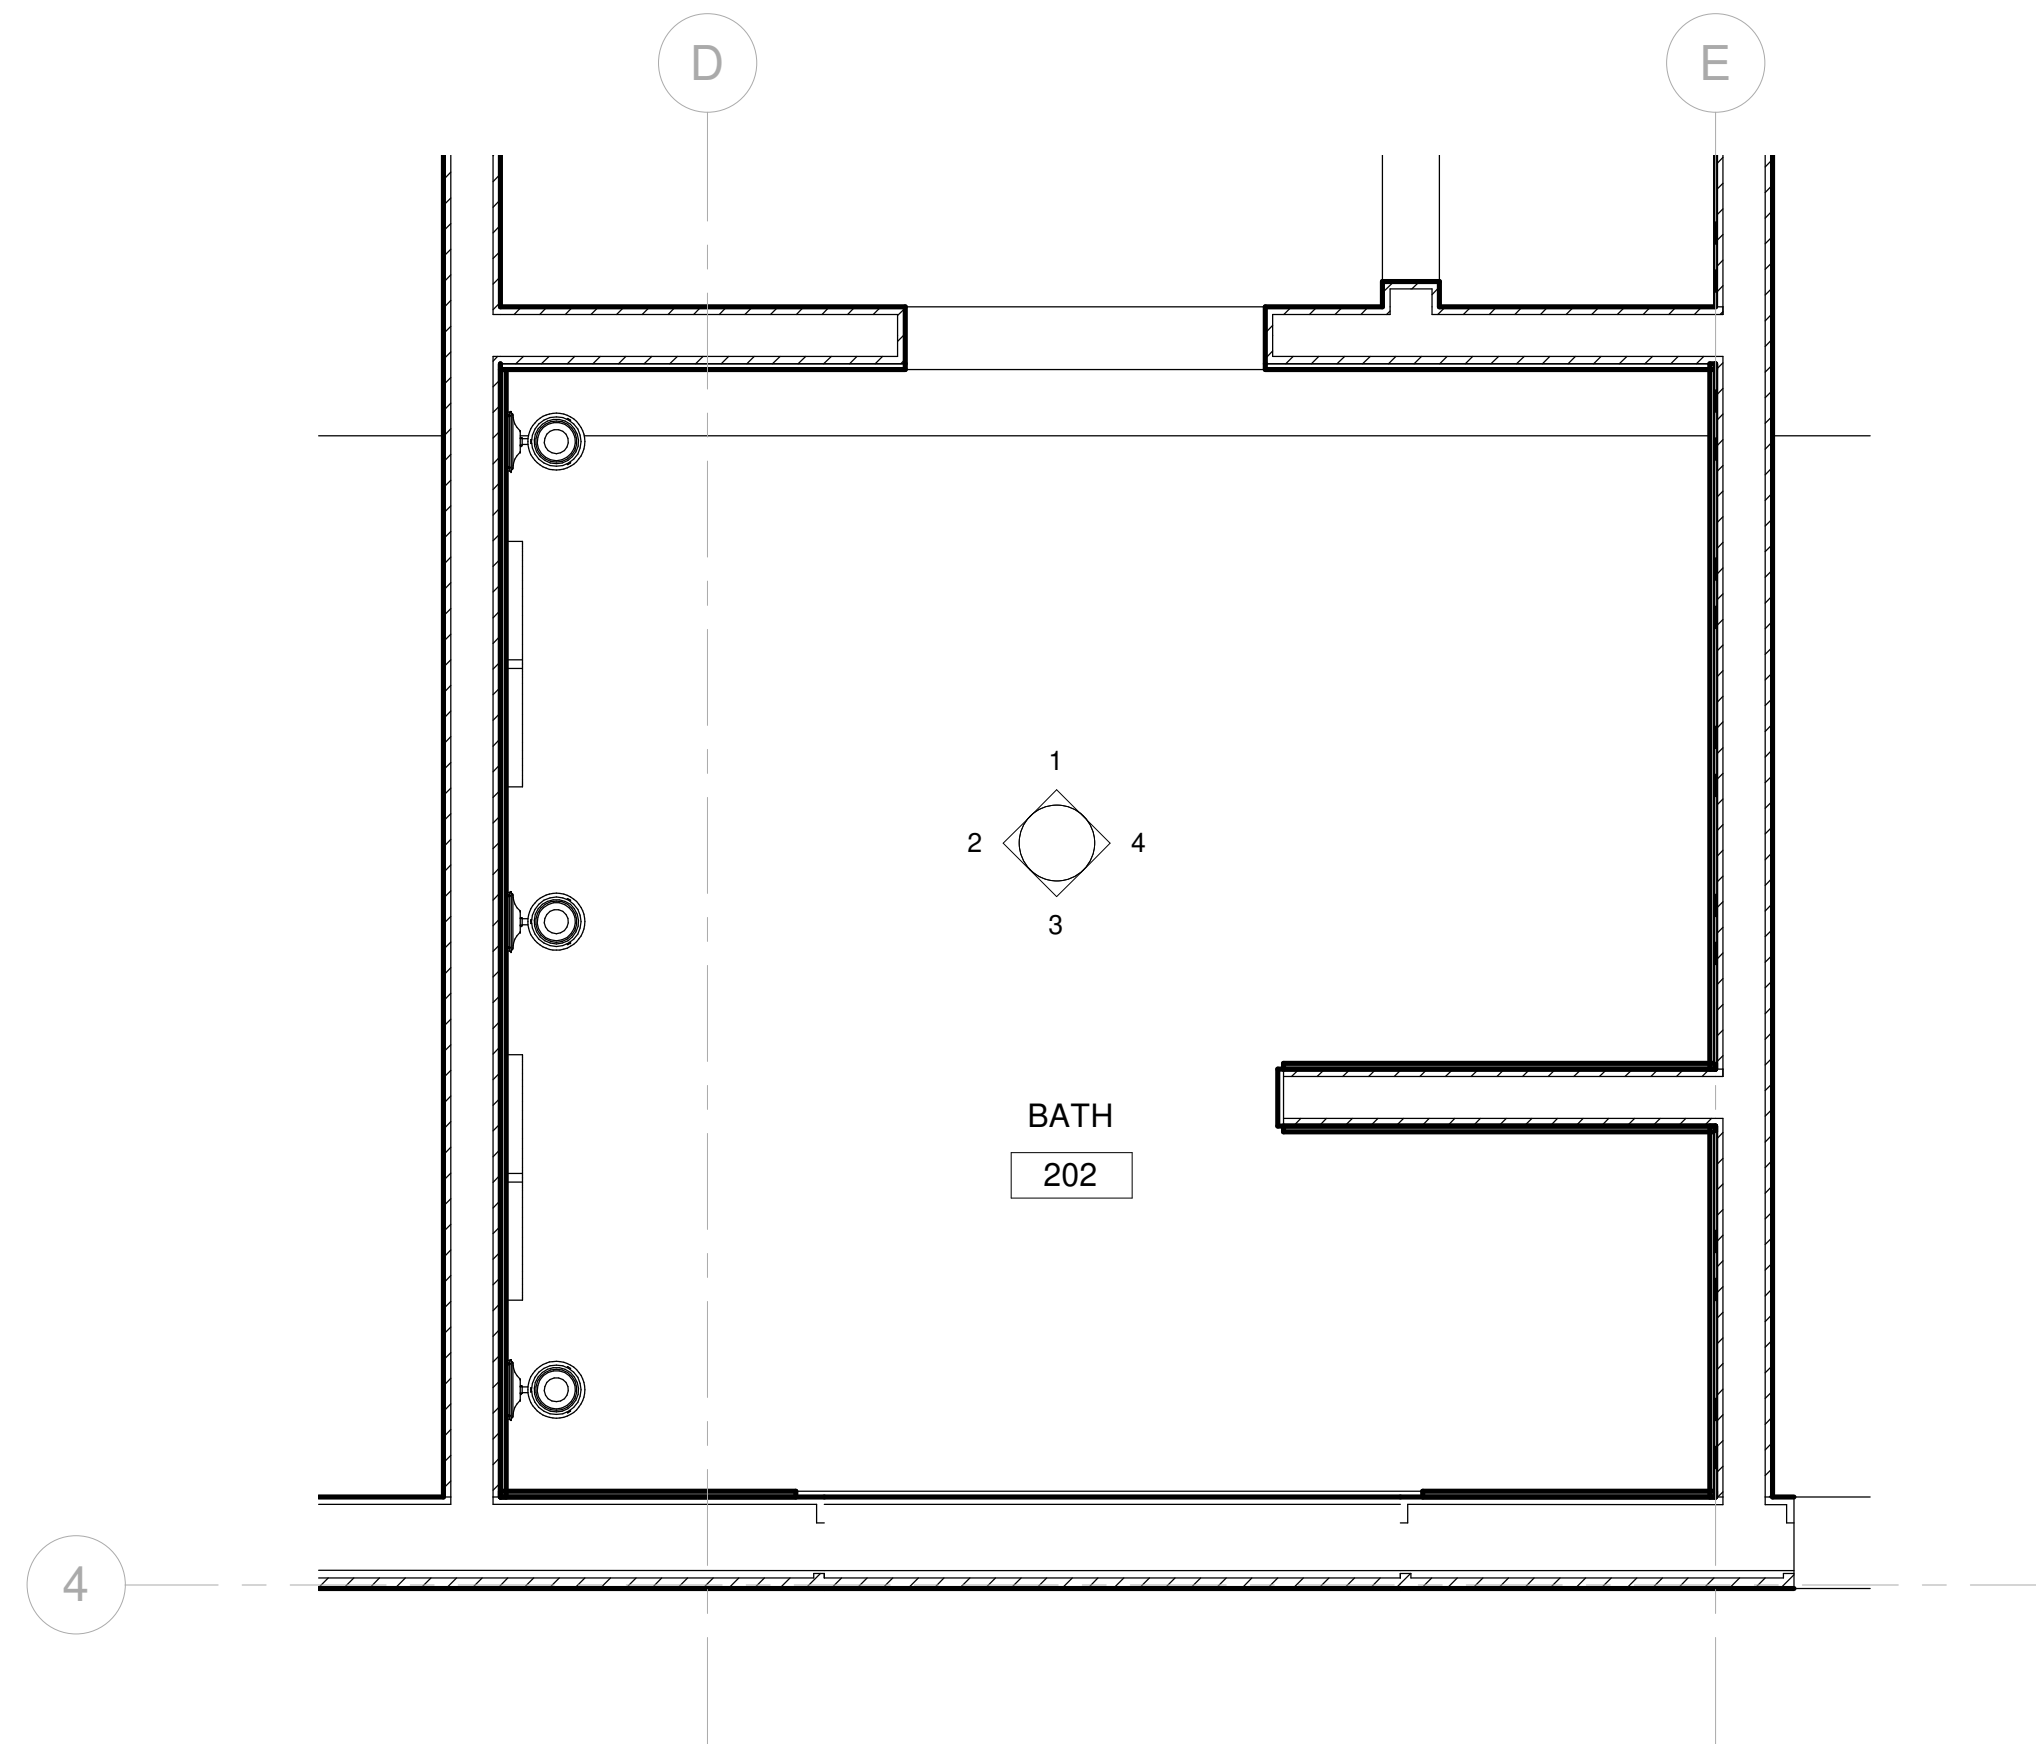

2 RCP\_BATH 202  
3/4" = 1'-0"

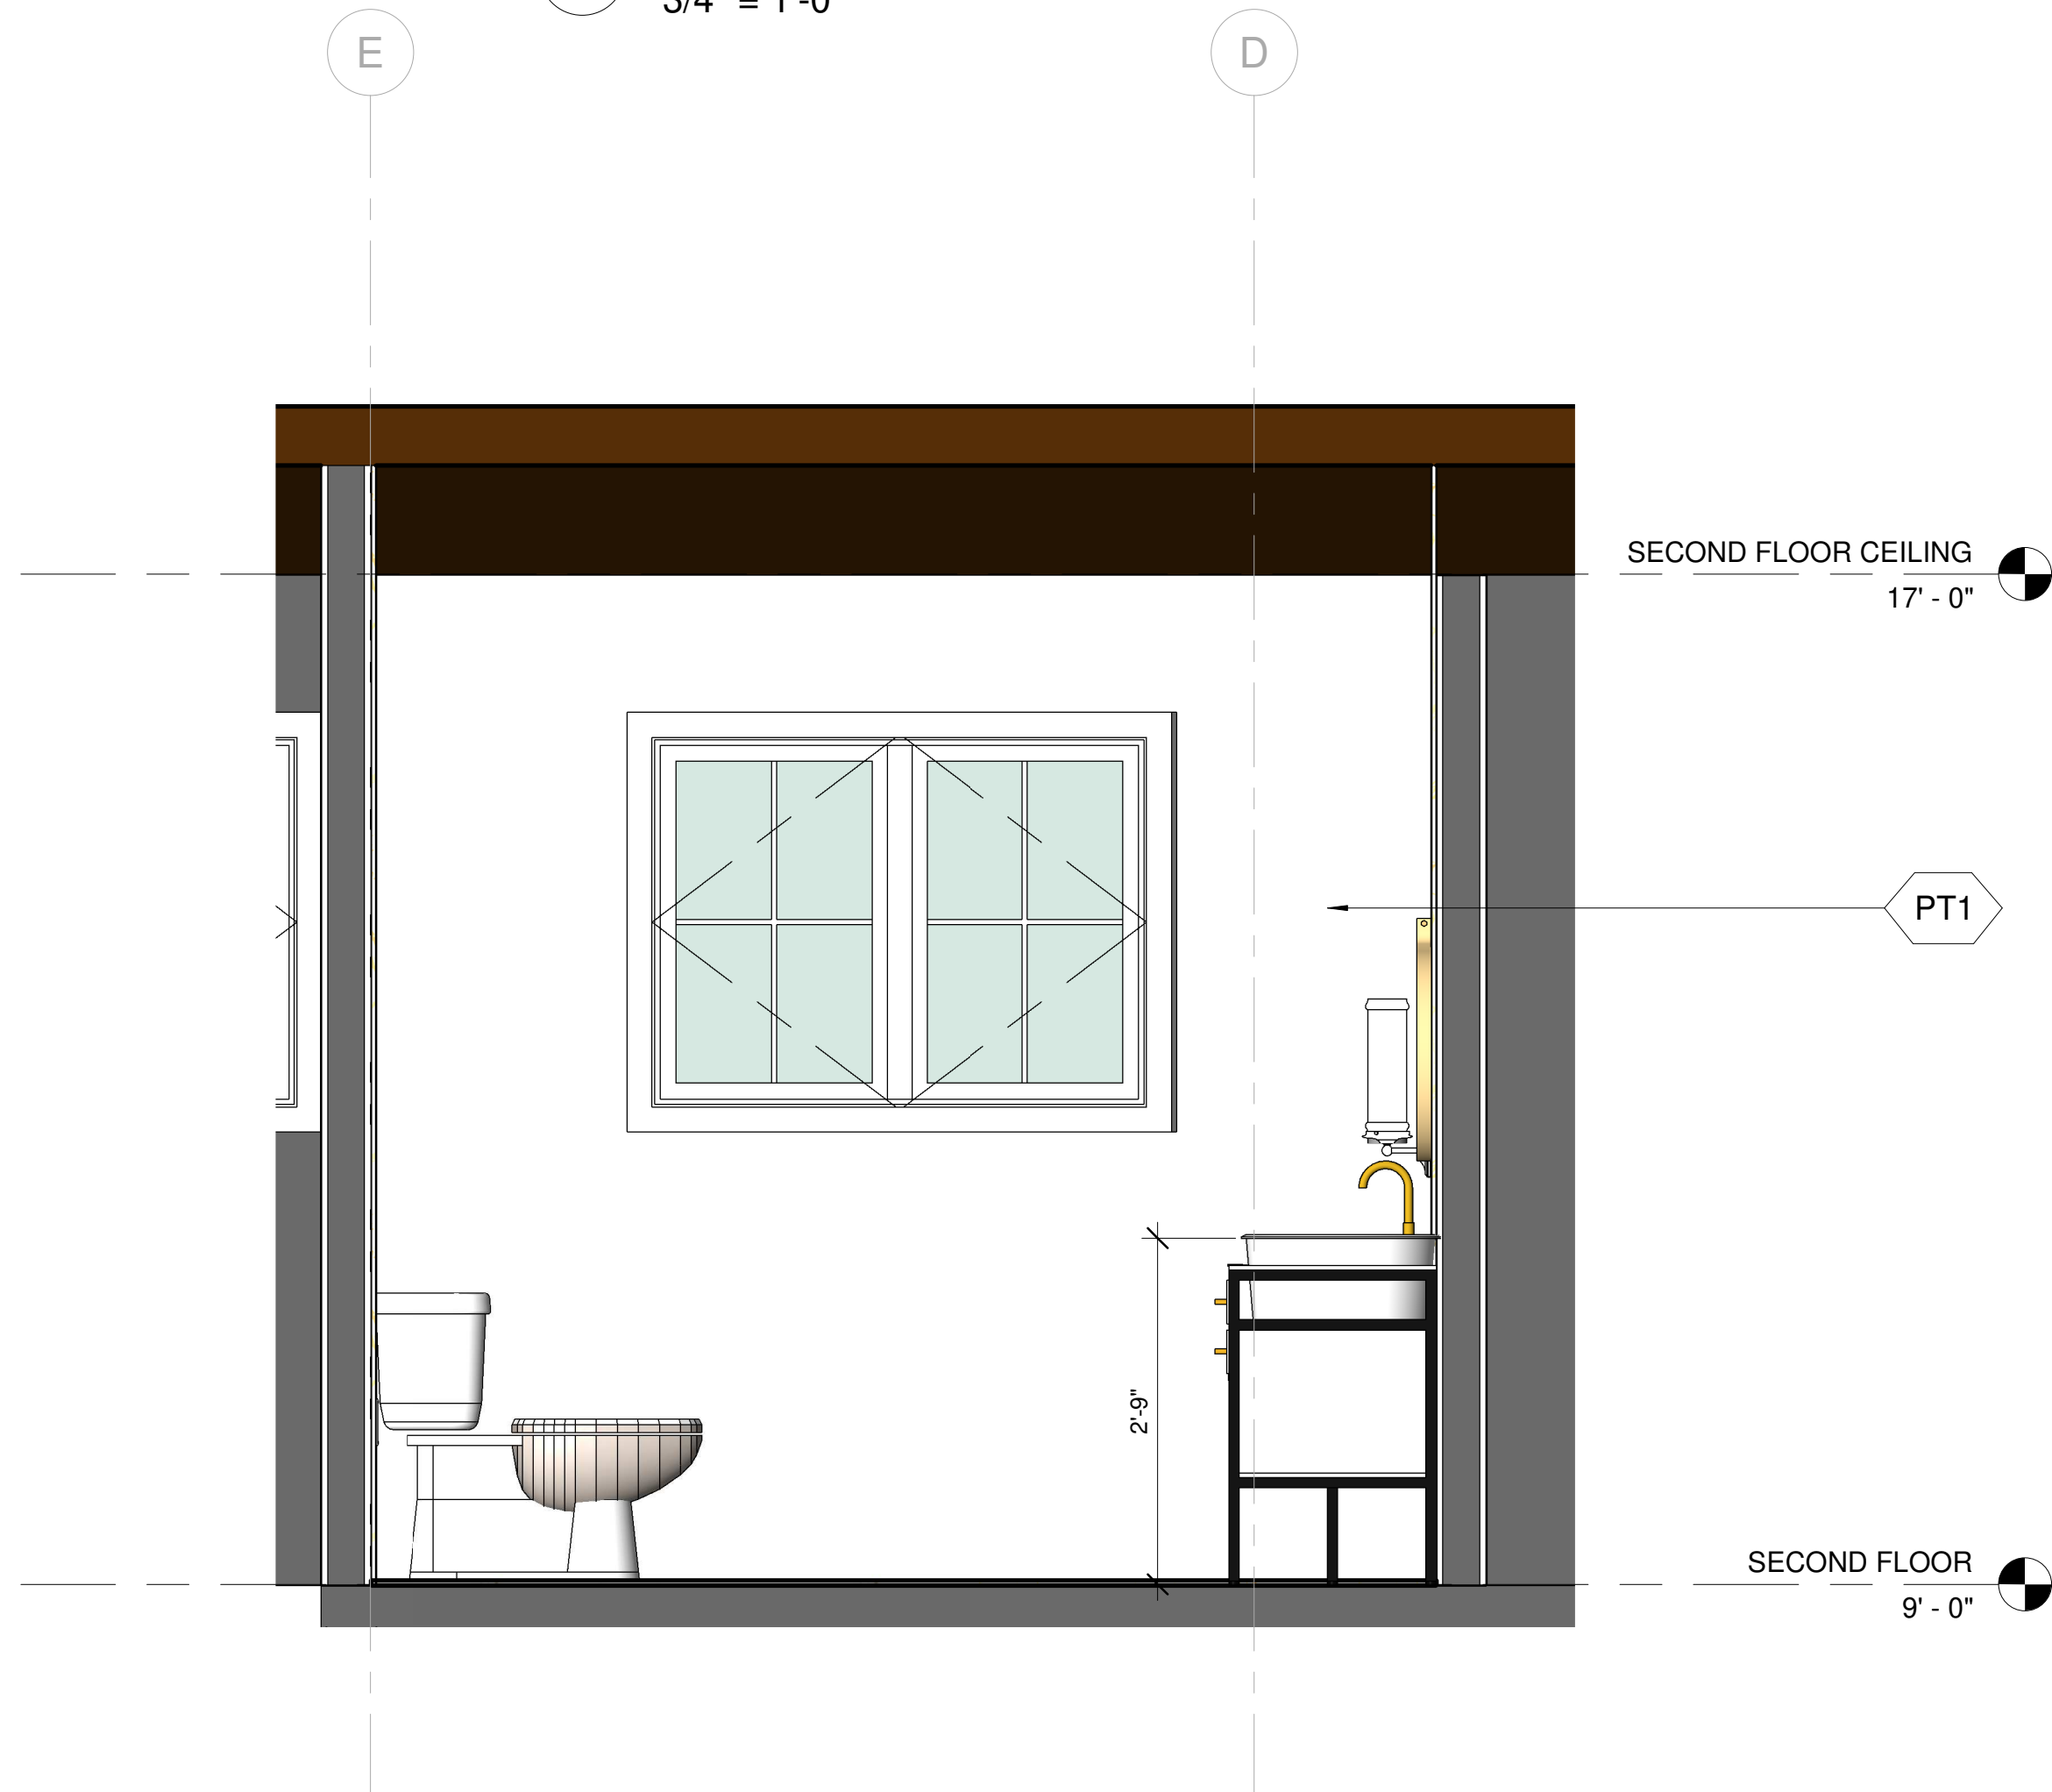

3 202 BATH ELEVATION - A  
3/4" = 1'-0"

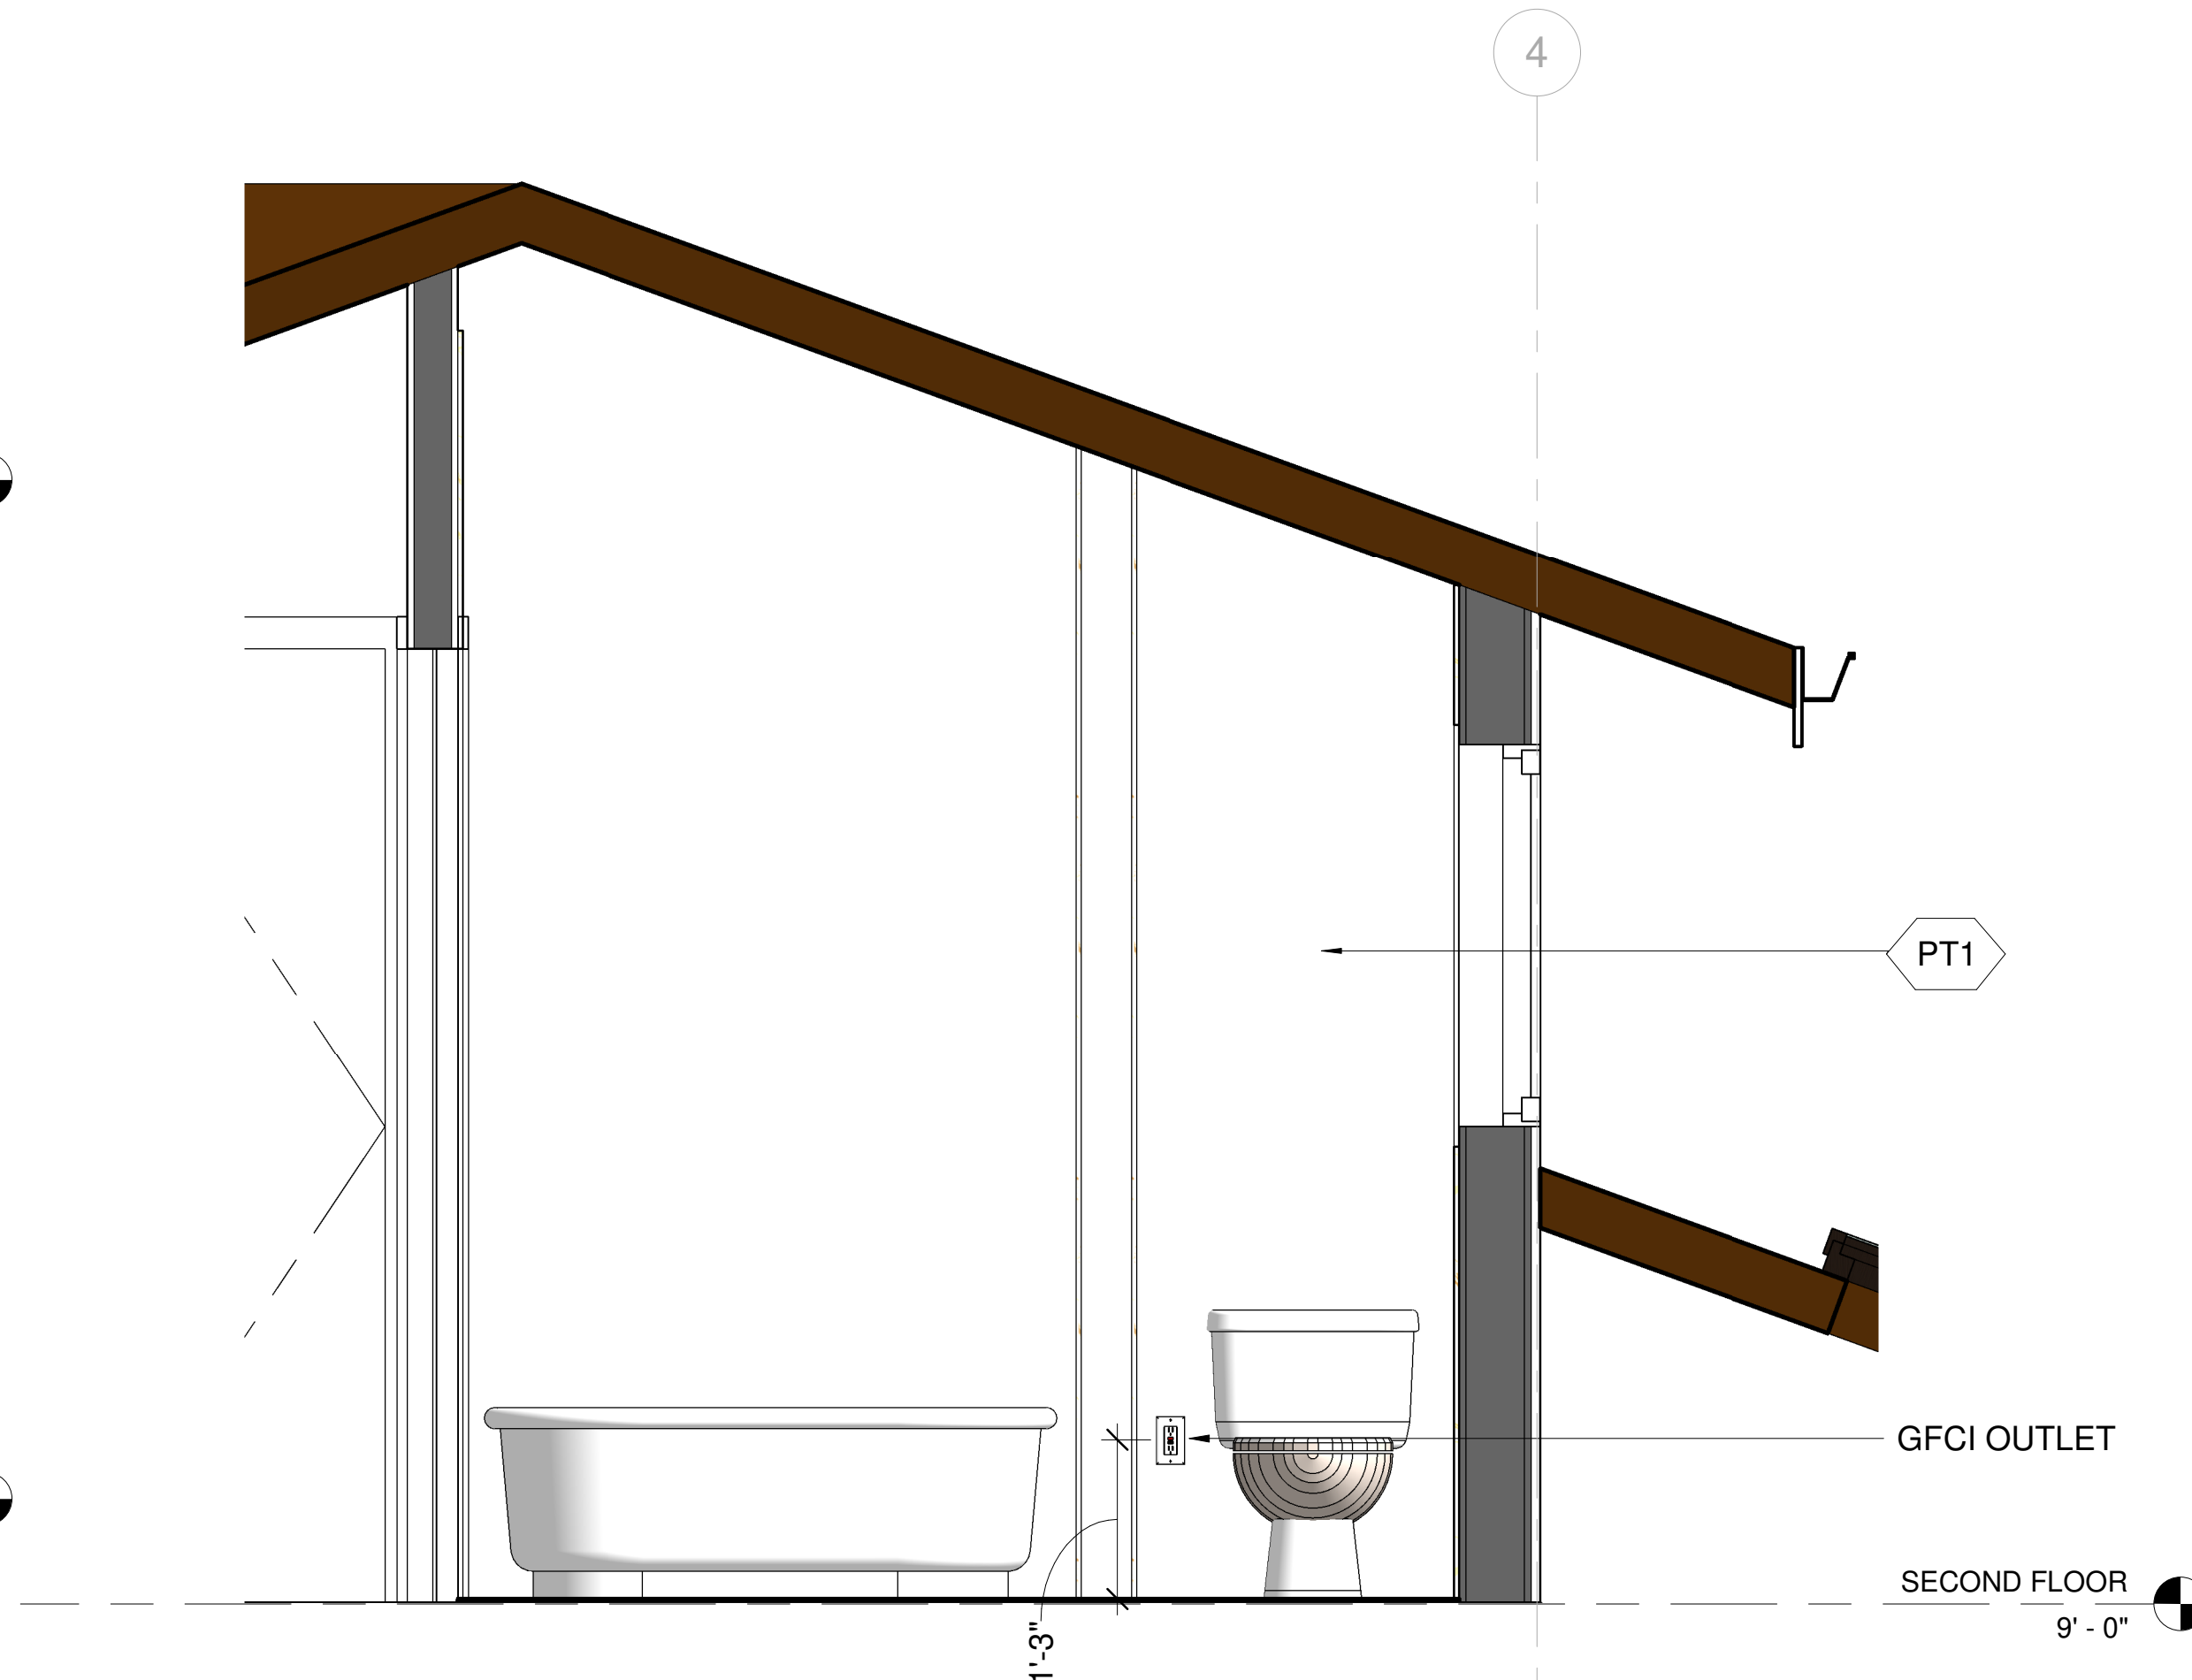

4 202 BATH ELEVATION - B  
3/4" = 1'-0"

## KEY NOTE

- N1 ADD GAS TO EXISTING FIRE PLACE
- N2 REFURBISH EXISTING FIRE PLACE INTO 2 SIDED FIRE PLACE
- N3 OUTDOOR BBQ
- N4 NEW FLOORING
- N5 REMOVE FLAT CEILING
- N6 PROVIDE SKYLIGHT
- N7 FLOATING SINK WITH VANITY
- N8 NEW TUB
- N9 NEW WATER CLOSET
- N10 NEW SINK
- N11 NEW BIDET
- N12 GFCI OUTLET
- N13 REFURBISH EXISTING WALL, PREP FOR NEW SHEAR WALL PER STRUCTURAL
- N14 18" X 24" ROOF VENT 72 SQ. INCH EACH
- E1 EXISTING SKYLIGHT TO REMAIN

## LEGEND

- FIXTURE TAG REFER TO A8.9 & A8.10
- FINISH TAG REFER TO A8.9

**DESIGN EVEREST**  
CONSULTING ENGINEERS

ENLARGED DETAILS- BATH 202  
**AHMED RENOVATION**  
**ALINA AHMED**  
LOT 15  
1081 NOTTINGHAM WAY  
LOS ALTOS, CA 94024


DATE: 22/09/17  
CITY SUBMITTAL

DATE: 22/09/17  
SCALE: As indicated  
DRAWN BY :  
CKD BY:  
PROJECT : 202107199

DRAWING NO.

A-8.5




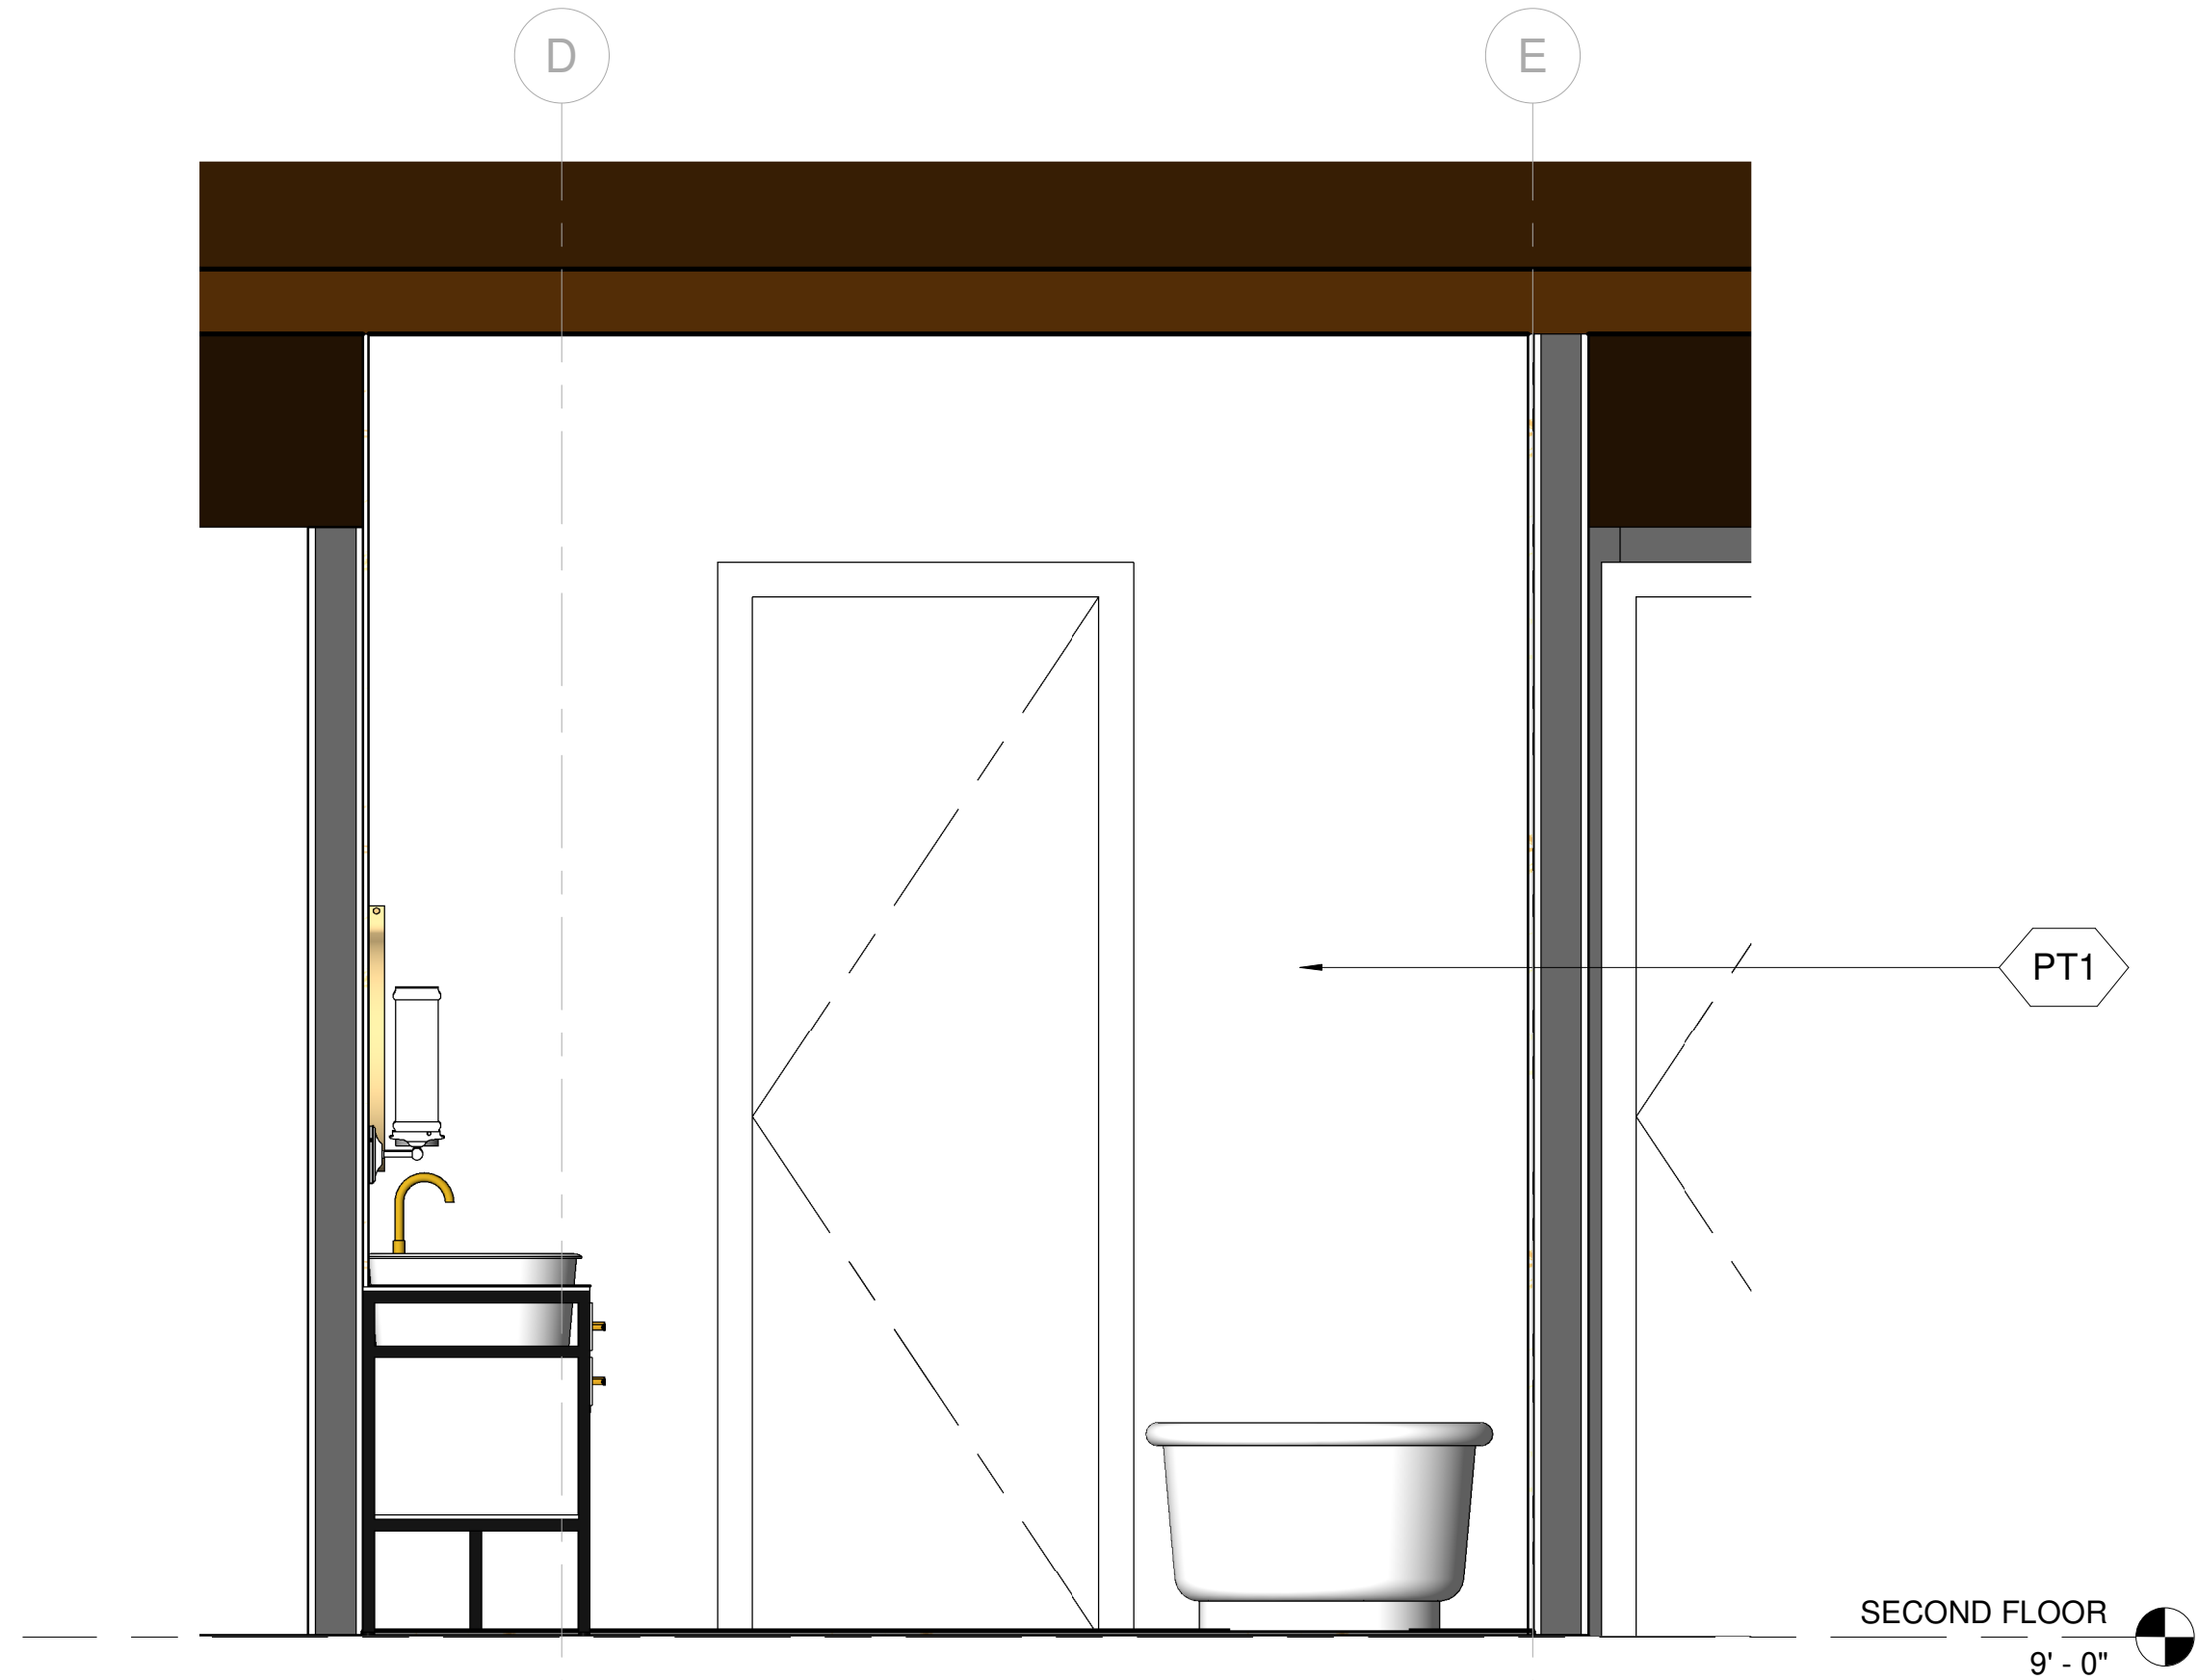


1 202 BATH ELEVATION - C  
3/4" = 1'-0"



3 BATH 202.1

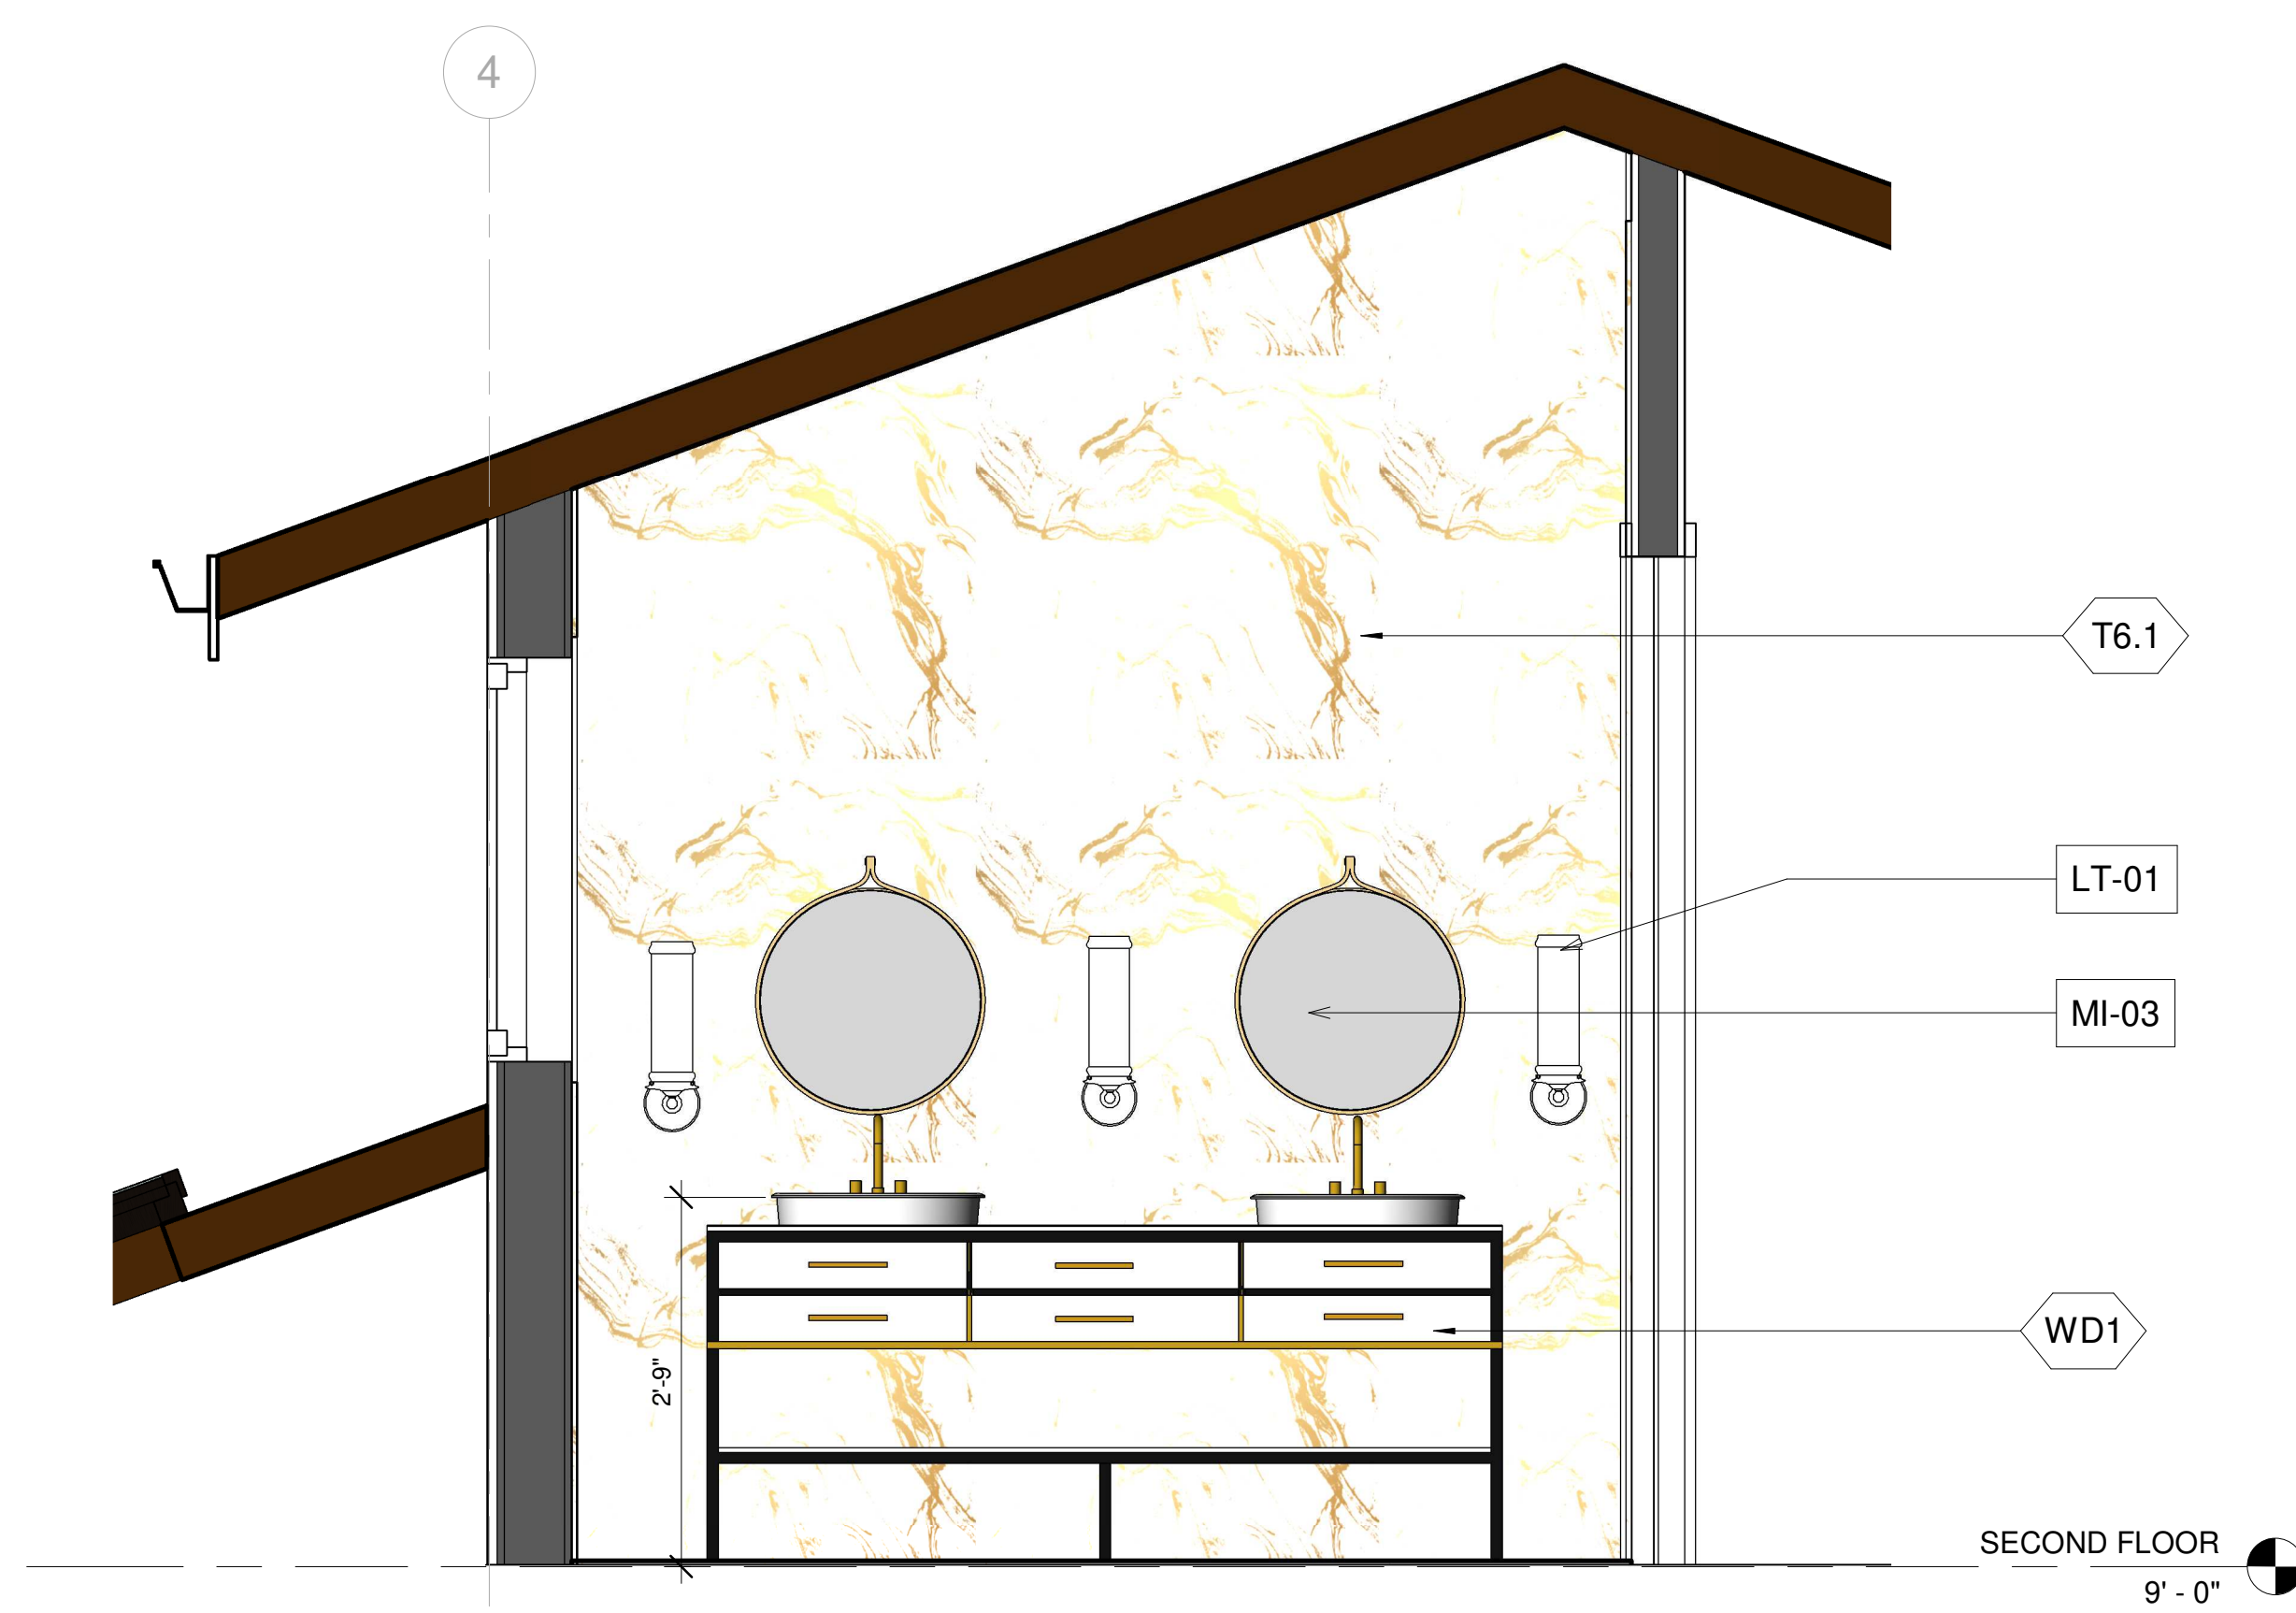

2 202 BATH ELEVATION - D  
3/4" = 1'-0"

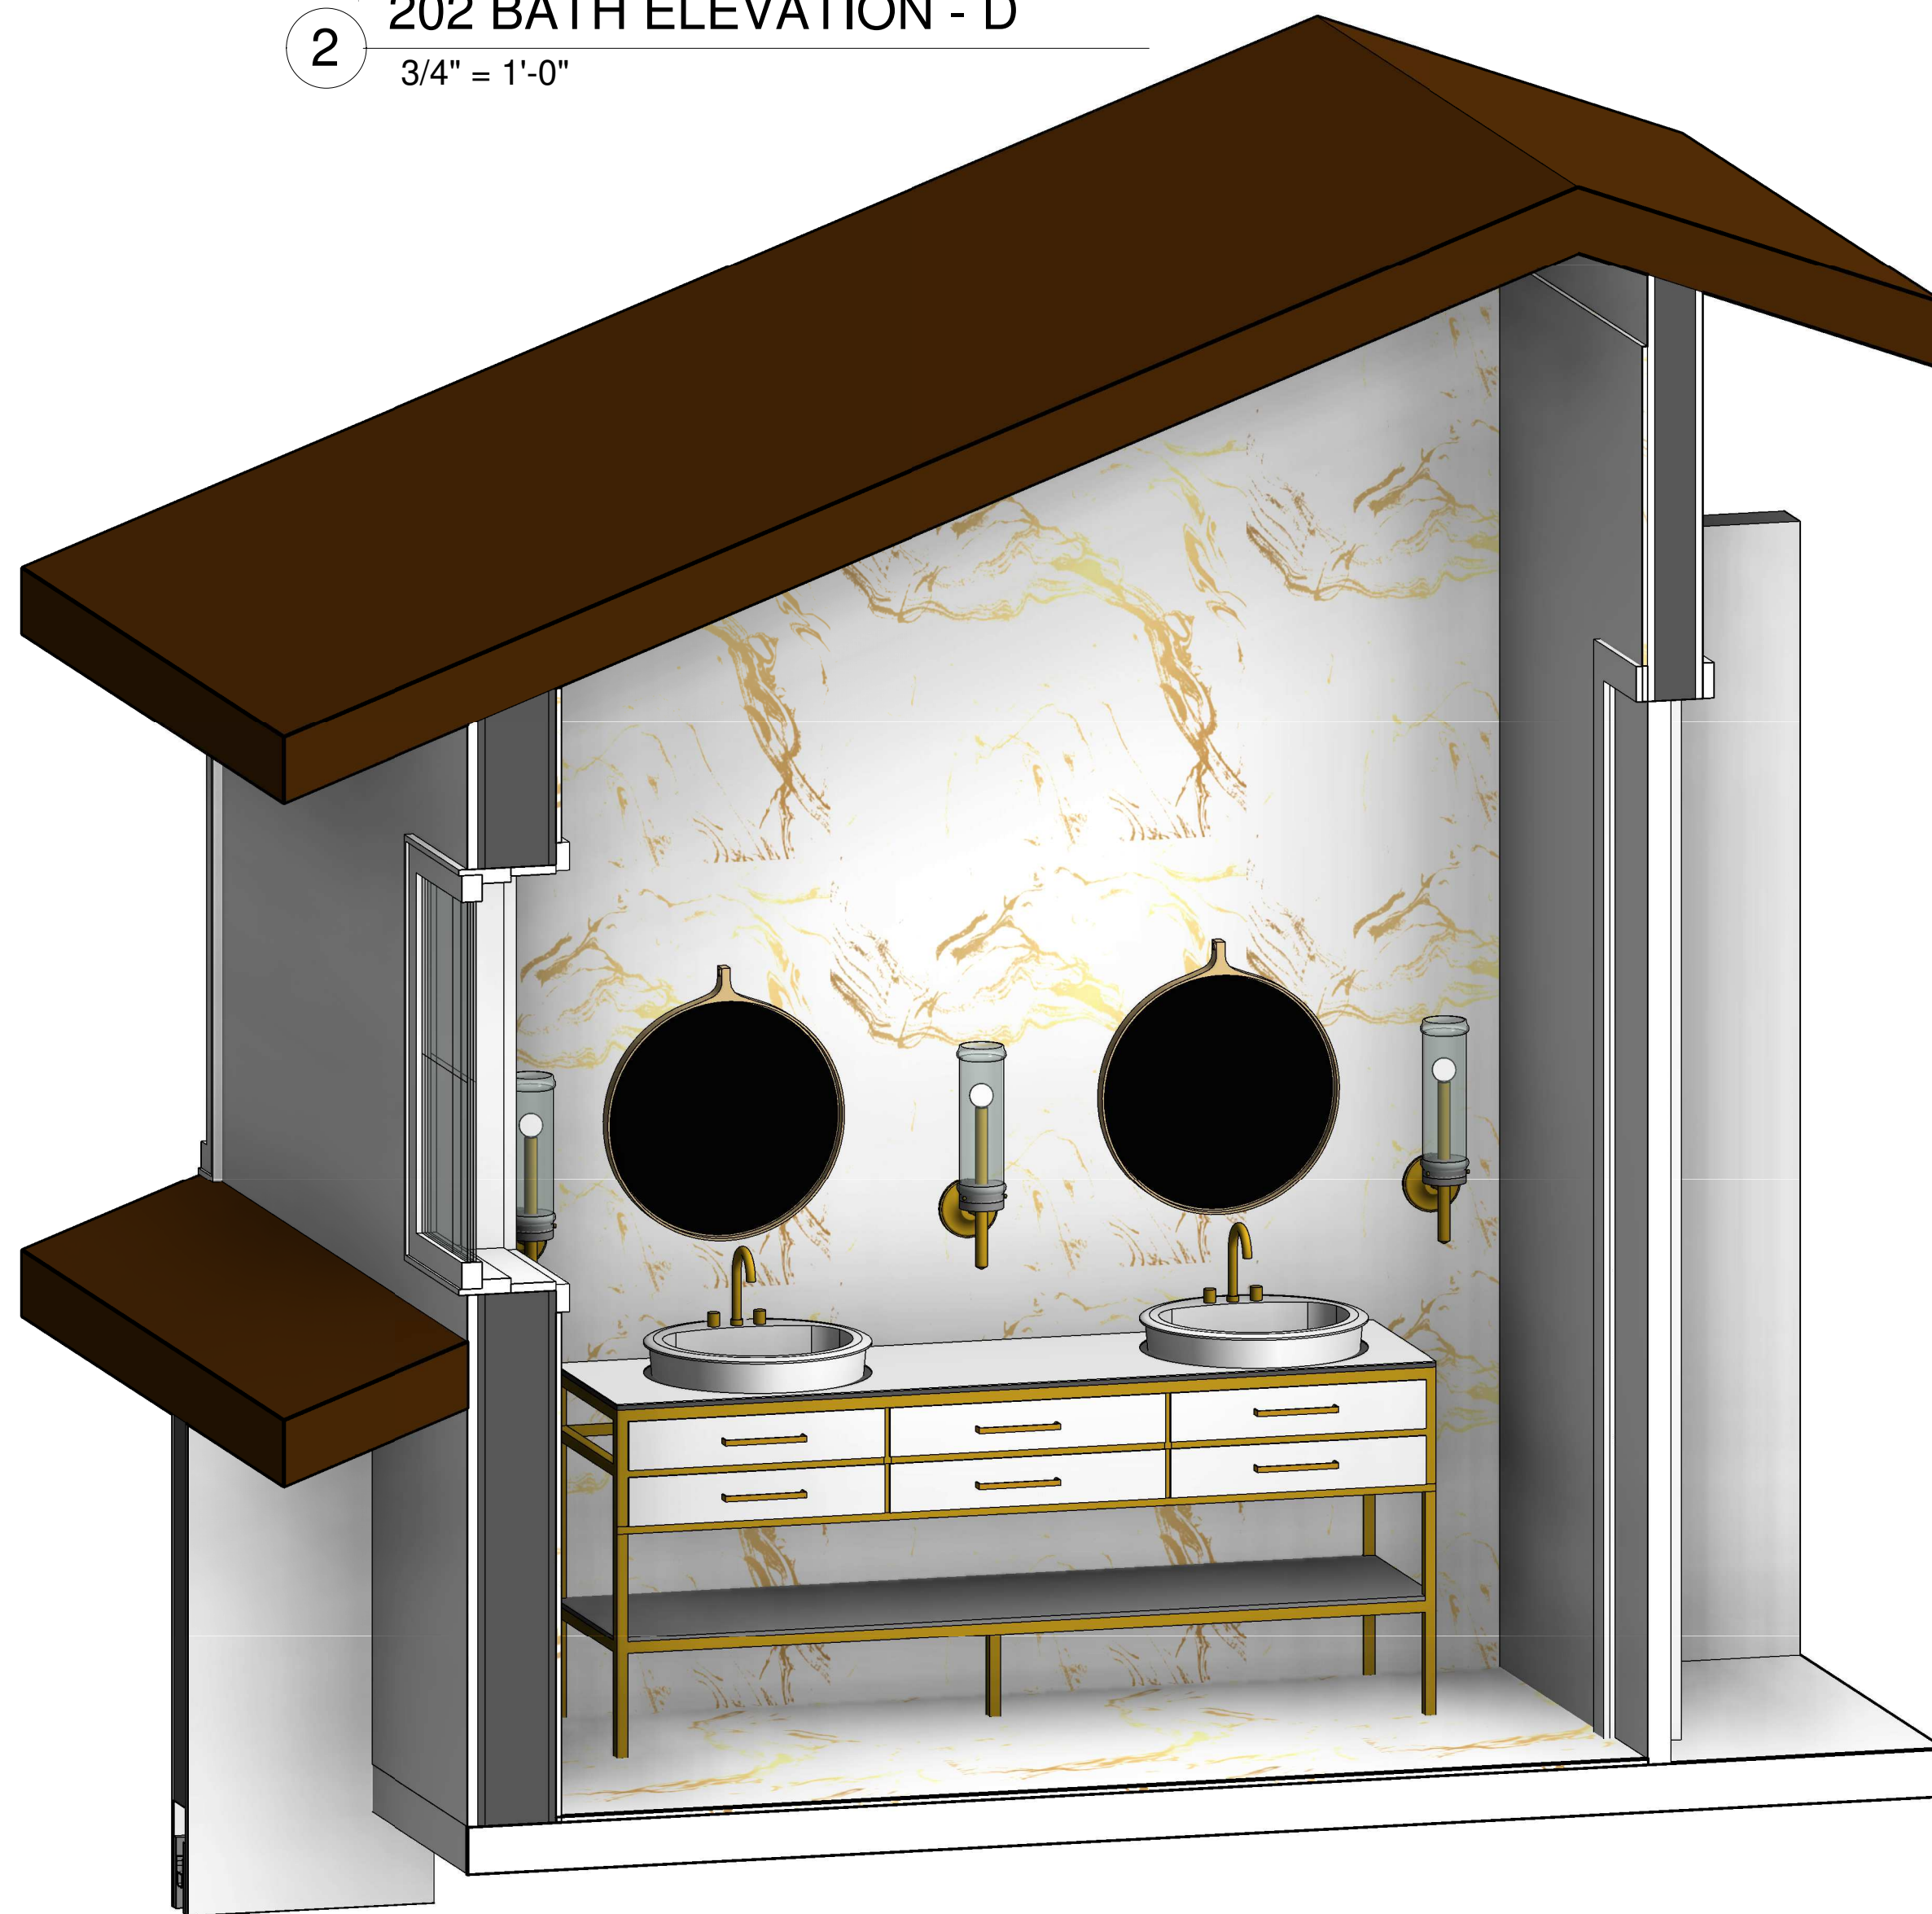

4 BATH 202.3

## KEY NOTE

N1	ADD GAS TO EXISTING FIRE PLACE
N2	REFURBISH EXISTING FIRE PLACE INTO 2 SIDED FIRE PLACE
N3	OUTDOOR BBQ
N4	NEW FLOORING
N5	REMOVE FLAT CEILING
N6	PROVIDE SKYLIGHT
N7	FLOATING SINK WITH VANITY
N8	NEW TUB
N9	NEW WATER CLOSET
N10	NEW SINK
N11	NEW BIDET
N12	GFCI OUTLET
N13	REFURBISH EXISTING WALL, PREP FOR NEW SHEAR WALL PER STRUCTURAL
N14	18" X 24" ROOF VENT 72 SQ.INCH EACH
E1	EXISTING SKYLIGHT TO REMAIN

## LEGEND

	FIXTURE TAG REFER TO A8.9 & A8.10
	FINISH TAG REFER TO A8.9

**DESIGN EVEREST**  
CONSULTING ENGINEERS


ENLARGED DETAILS-BATH 202  
AHMED RENOVATION  
ALINA AHMED  
LOT 15  
1081 NOTTINGHAM WAY  
LOS ALTOS, CA 94024

No.	DATE:	DELTA DESCRIPTION:
1	22/09/17	CITY SUBMITTAL
2		
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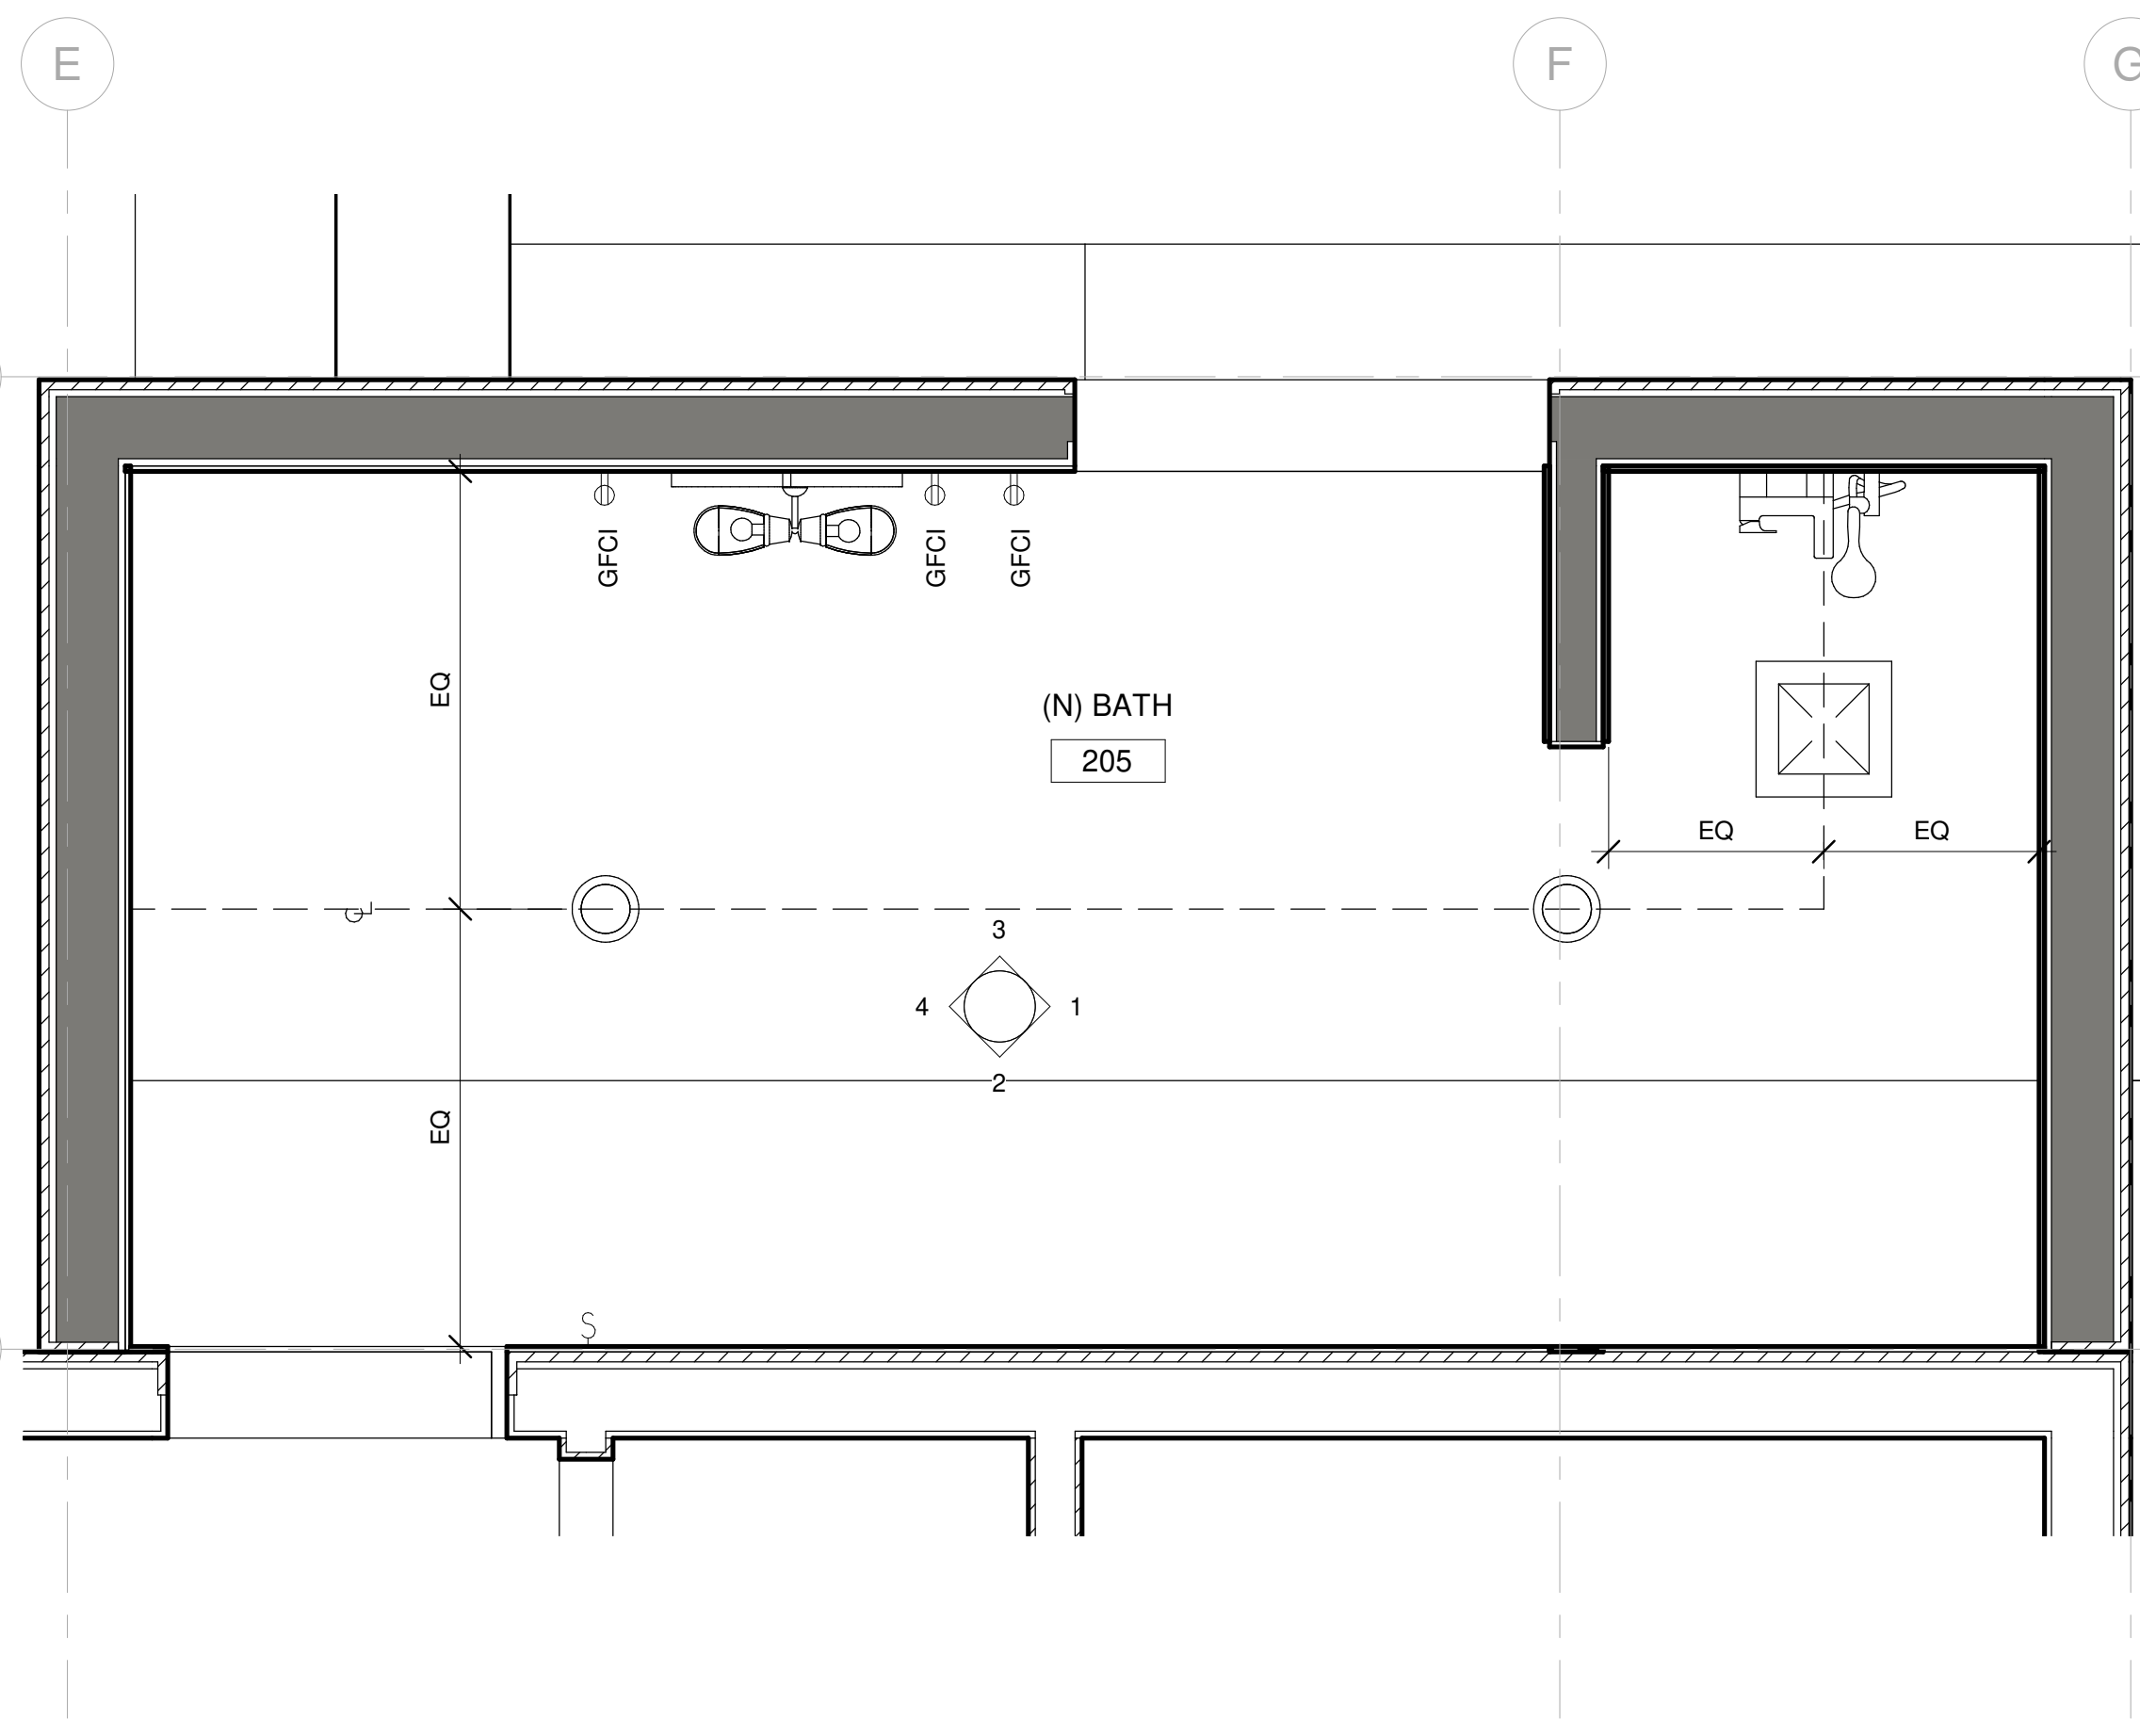
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DRAWN BY :	
CKD BY:	
PROJECT :	202107199

DRAWING NO.  
**A-8.5.2**




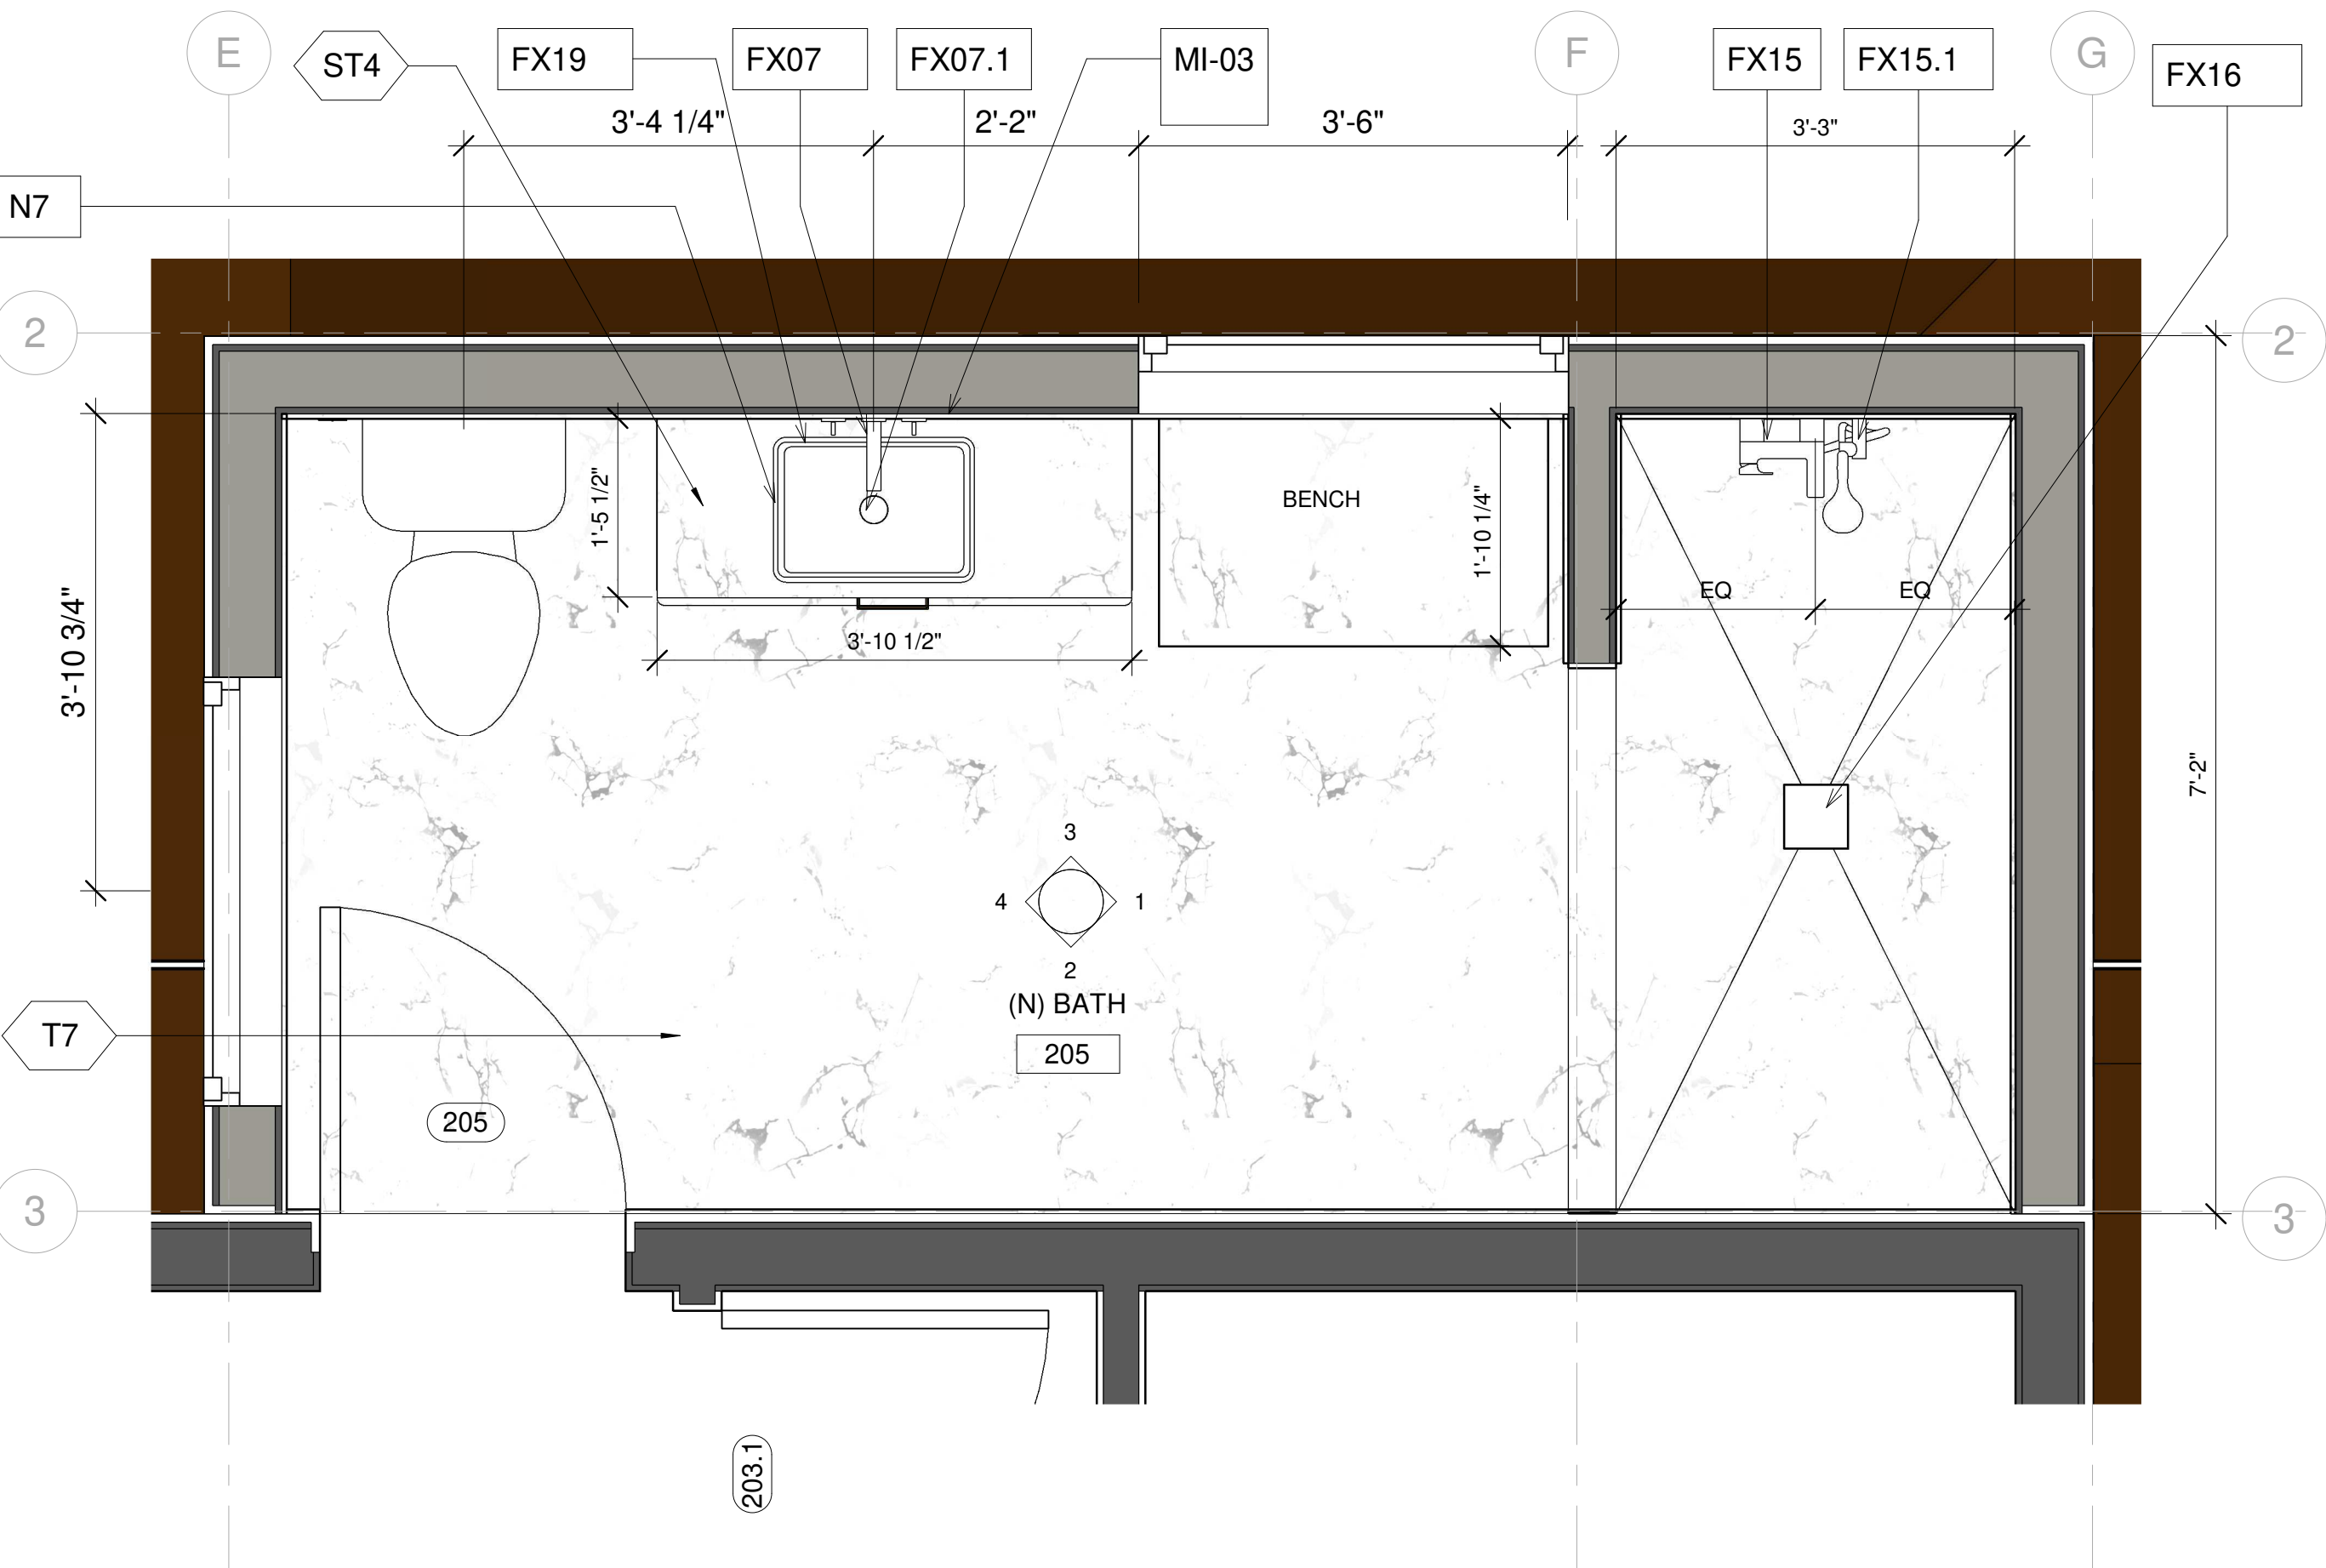


1 BATH 205 ENLARGED PLAN  
3/4" = 1'-0"



2 RCP\_BATH 205  
3/4" = 1'-0"

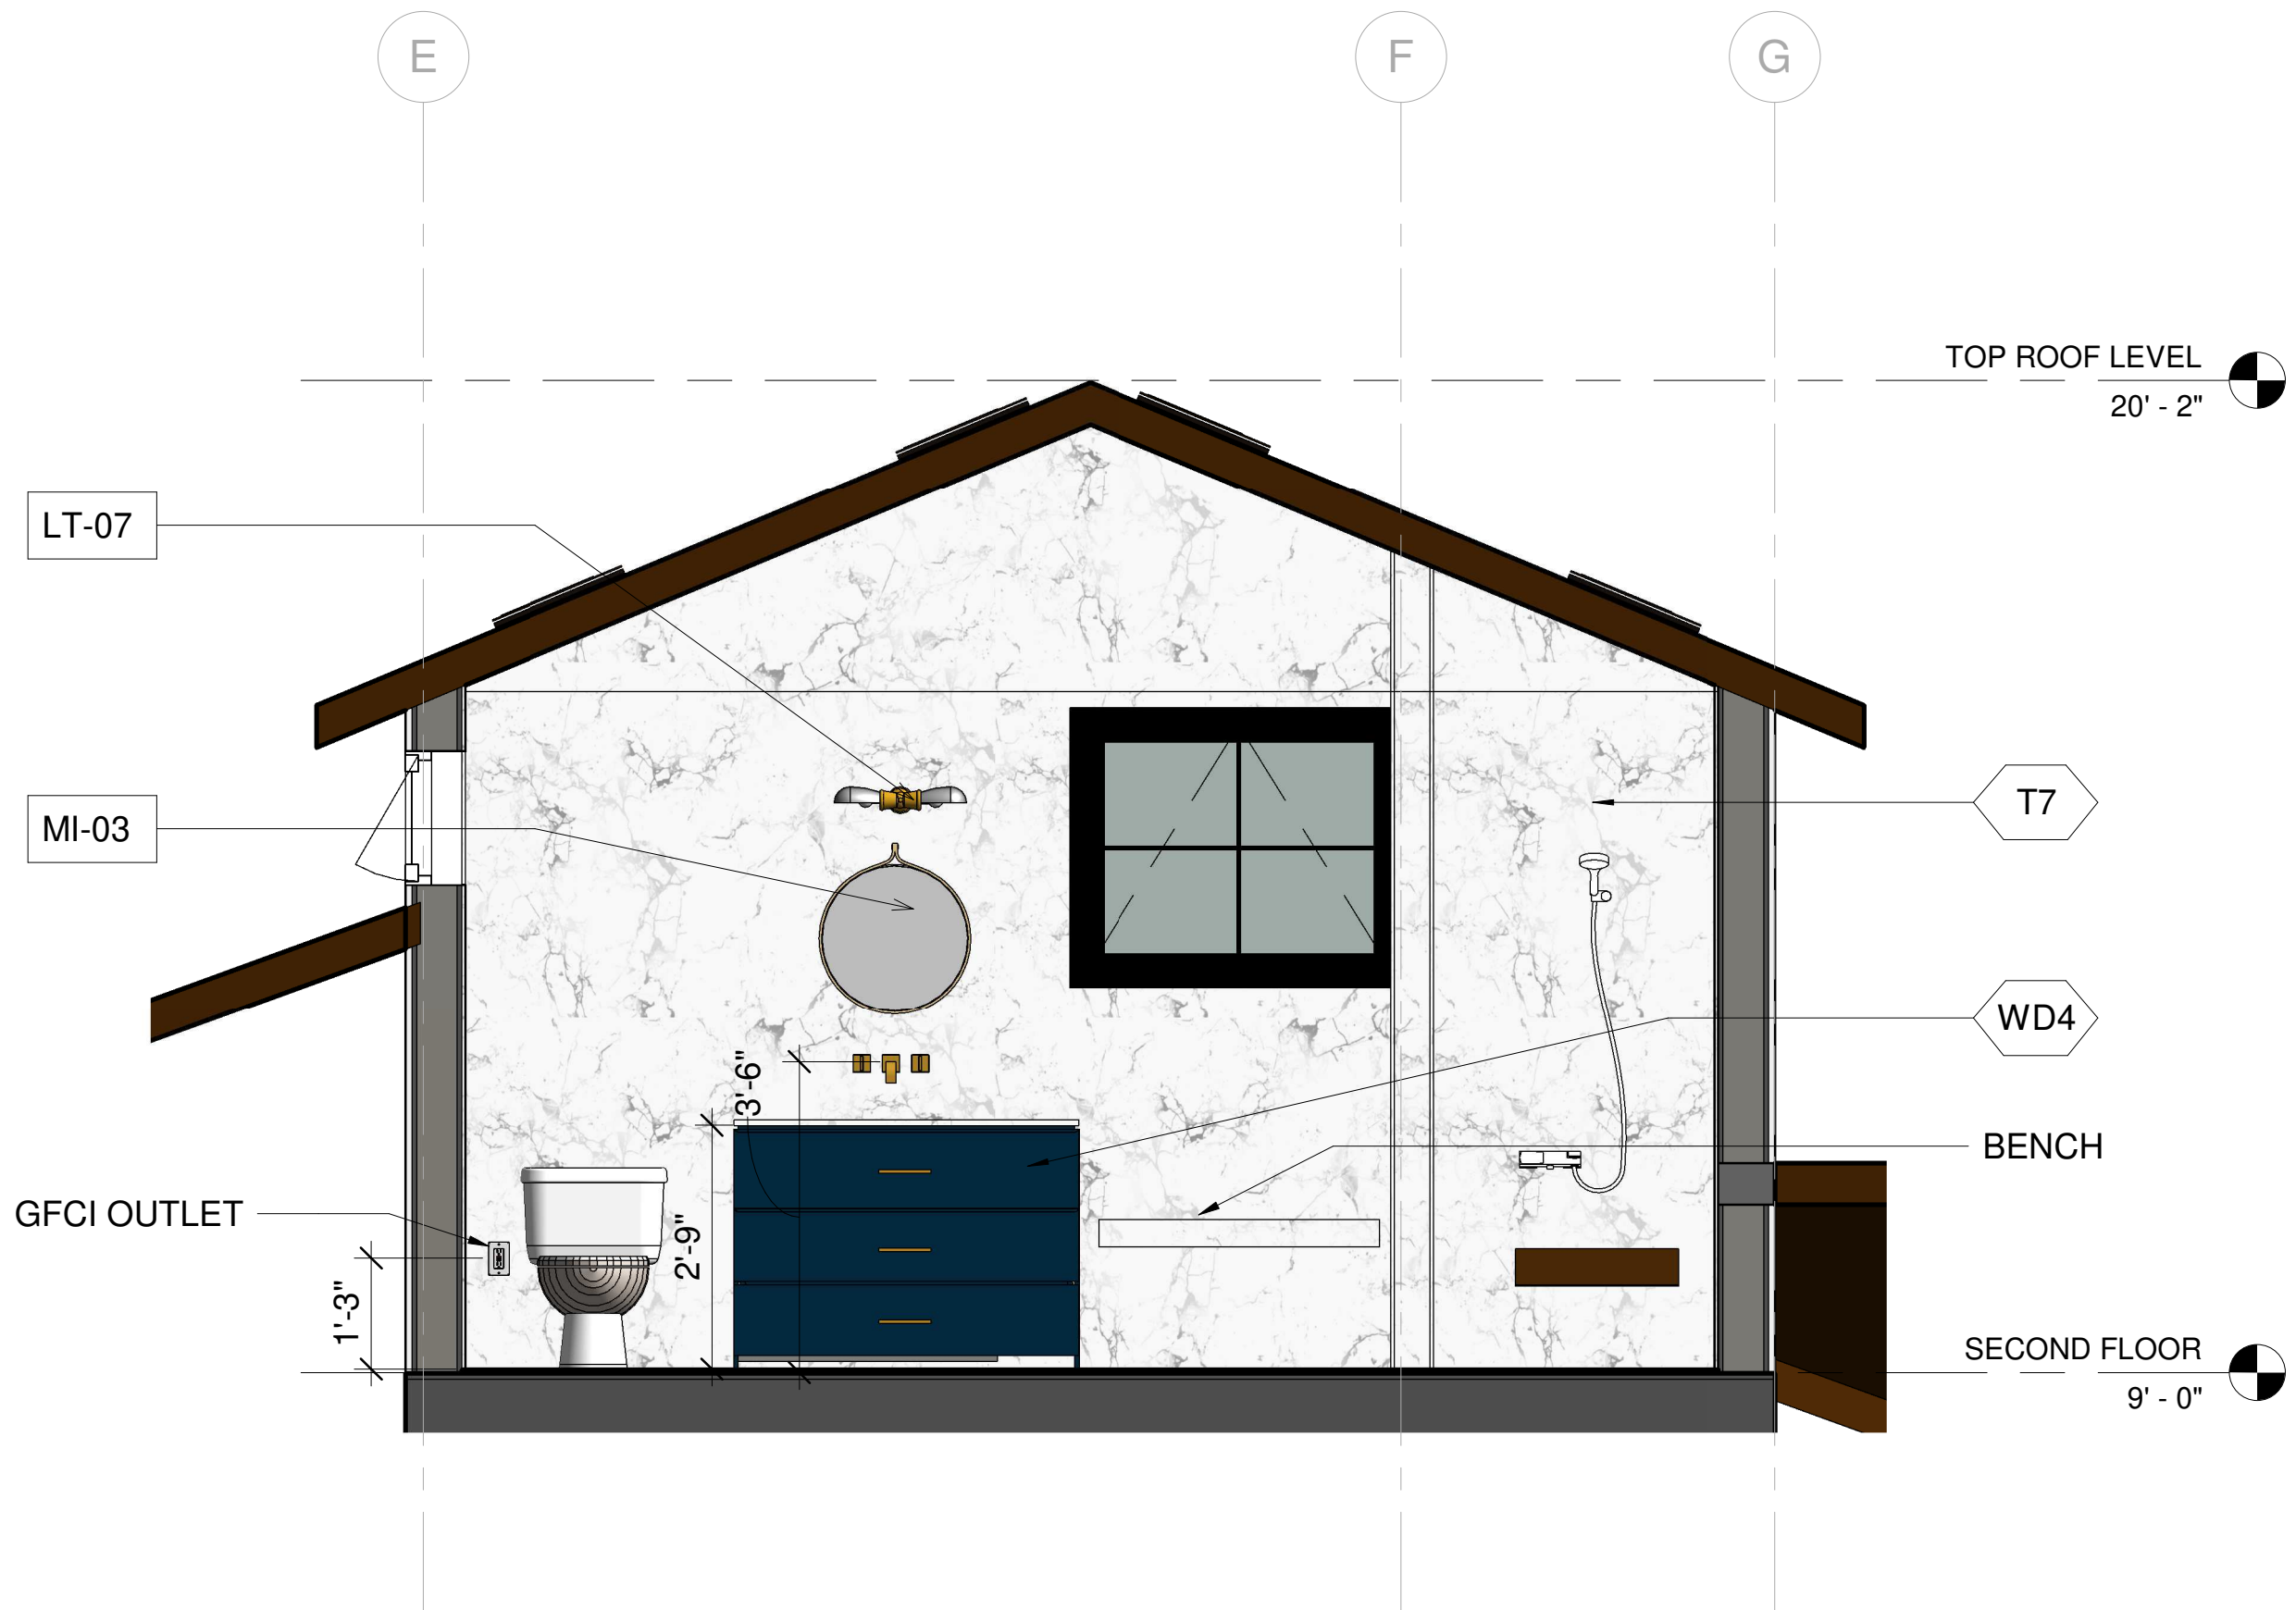

3 205 BATH ELEVATION - A  
1/2" = 1'-0"

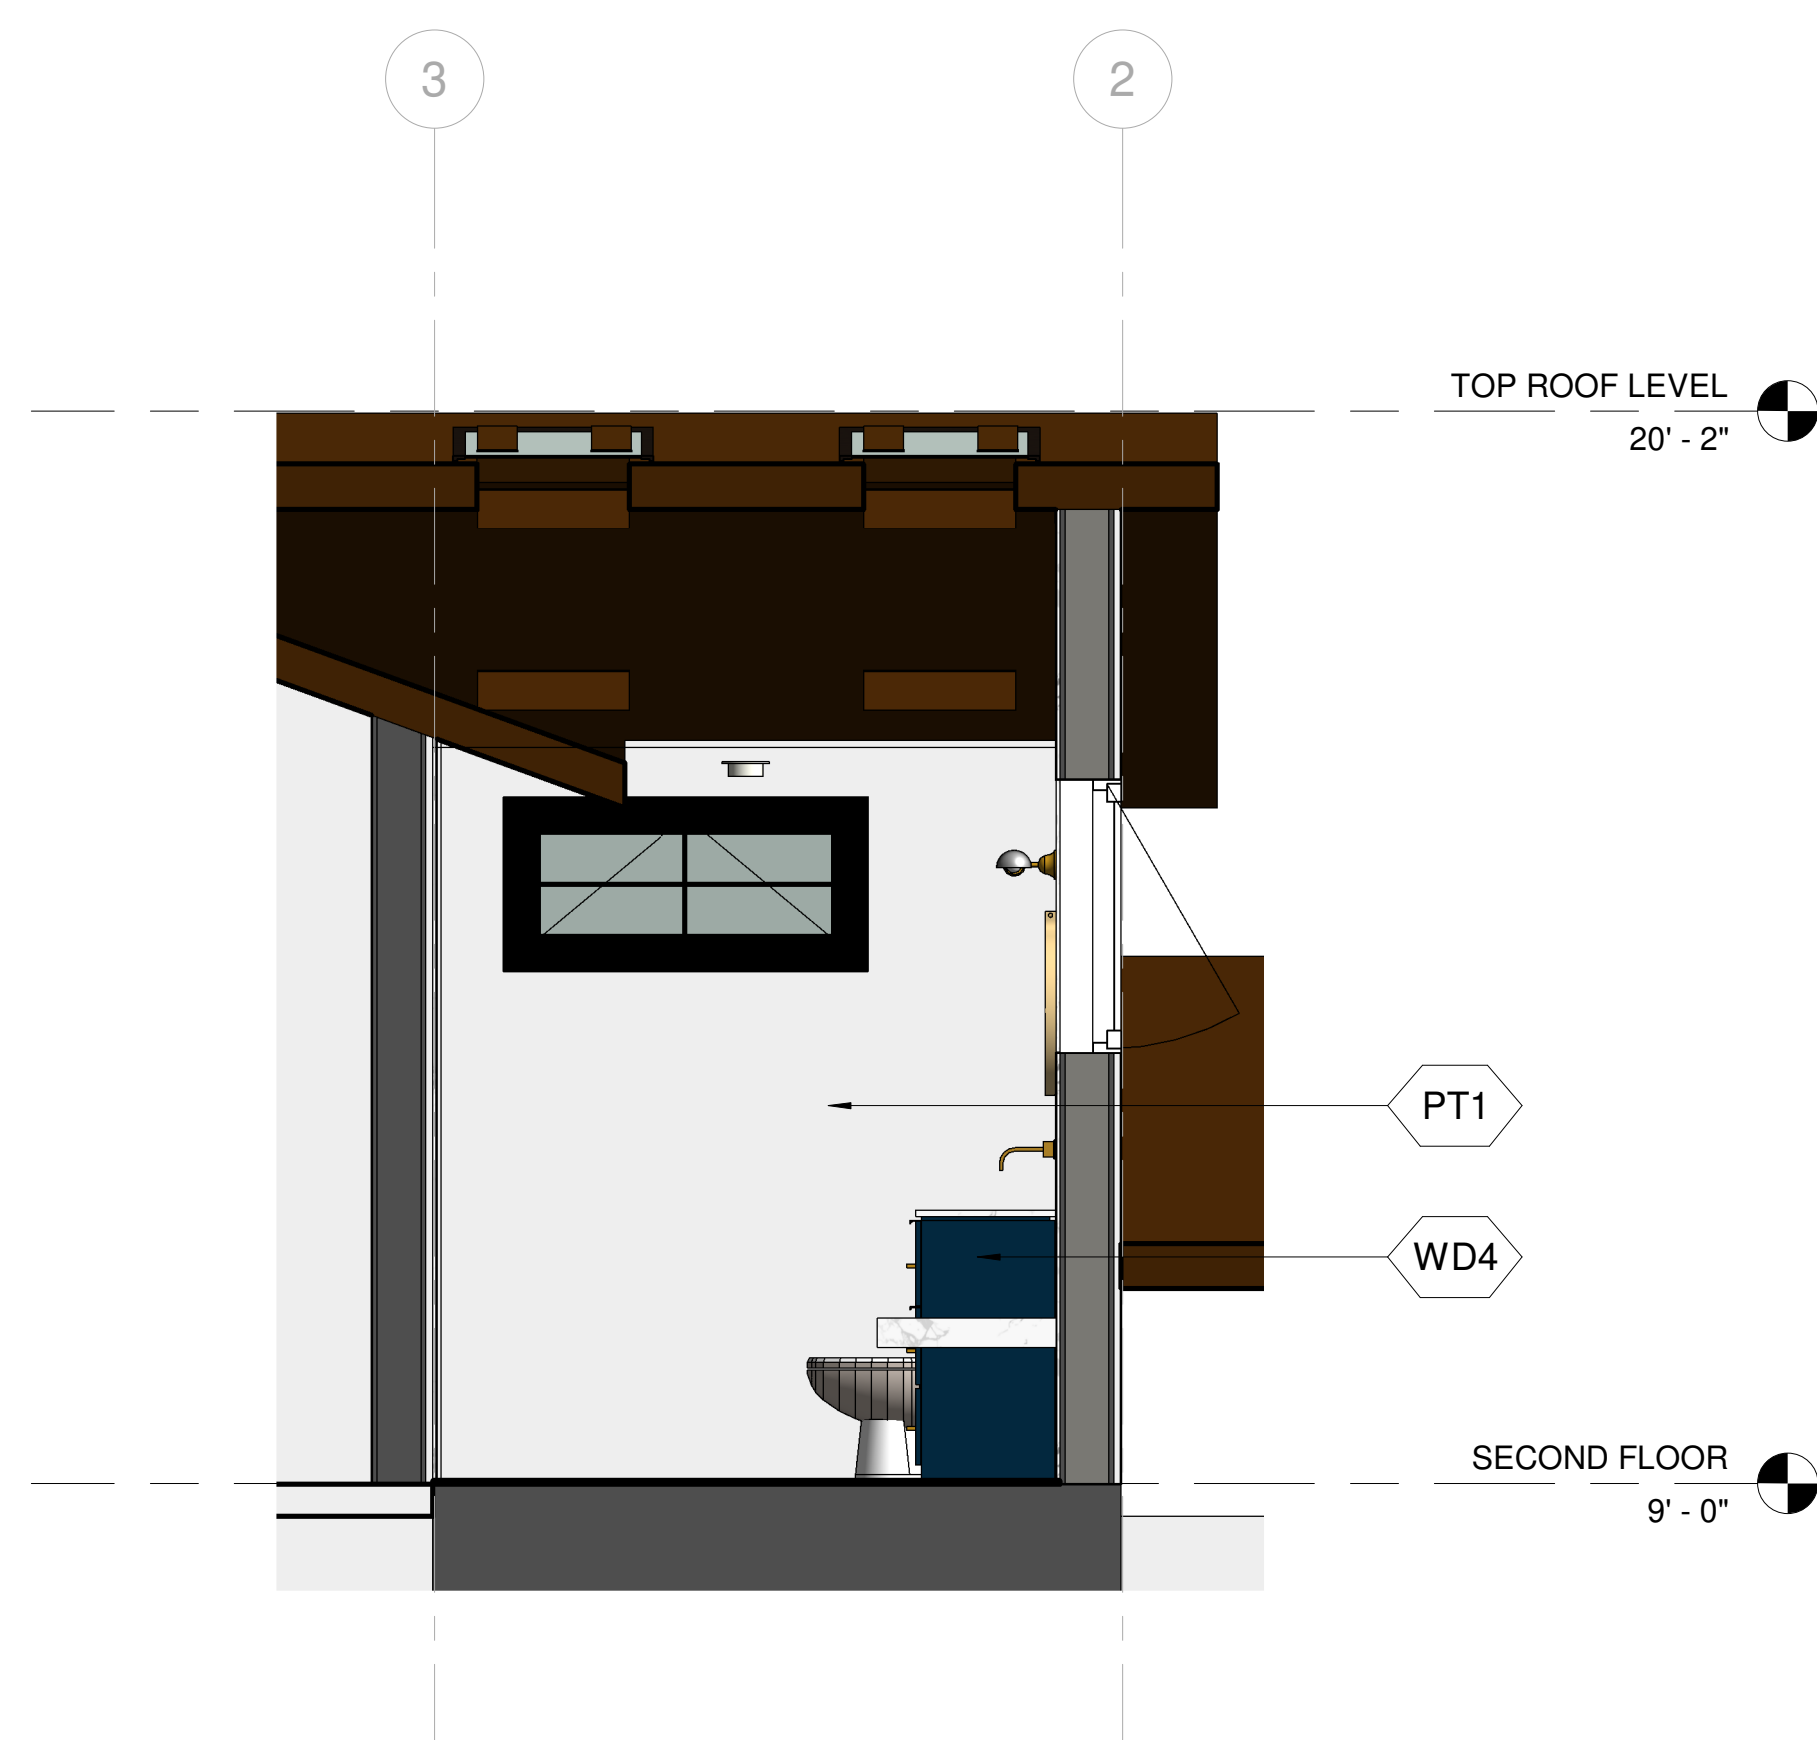

4 205 BATH ELEVATION - B  
1/2" = 1'-0"

KEY NOTE

N1	ADD GAS TO EXISTING FIRE PLACE
N2	REFURBISH EXISTING FIRE PLACE INTO 2 SIDED FIRE PLACE
N3	OUTDOOR BBQ
N4	NEW FLOORING
N5	REMOVE FLAT CEILING
N6	PROVIDE SKYLIGHT
N7	FLOATING SINK WITH VANITY
N8	NEW TUB
N9	NEW WATER CLOSET
N10	NEW SINK
N11	NEW BIDET
N12	GFCI OUTLET
N13	REFURBISH EXISTING WALL, PREP FOR NEW SHEAR WALL PER STRUCTURAL
N14	18" X 24" ROOF VENT 72 SQ.INCH EACH
E1	EXISTING SKYLIGHT TO REMAIN

LEGEND

	FIXTURE TAG REFER TO A8.9 & A8.10
	FINISH TAG REFER TO A8.9

ENLARGED DETAILS-BATH 205

AHMED RENOVATION  
ALINA AHMED  
LOT 15  
1081 NOTTINGHAM WAY  
LOS ALTOS, CA 94024

DATE: 22/09/17

SCALE: As indicated

DRAWN BY :

CKD BY:


PROJECT : 202107199

DRAWING NO.


A-8.6

DESIGN EVEREST  
CONSULTING ENGINEERS  
365 FLOWER LANE  
MOUNTAIN VIEW, CA 64043  
PHONE: (888) 311-3015 FAX: (650) 695-1801




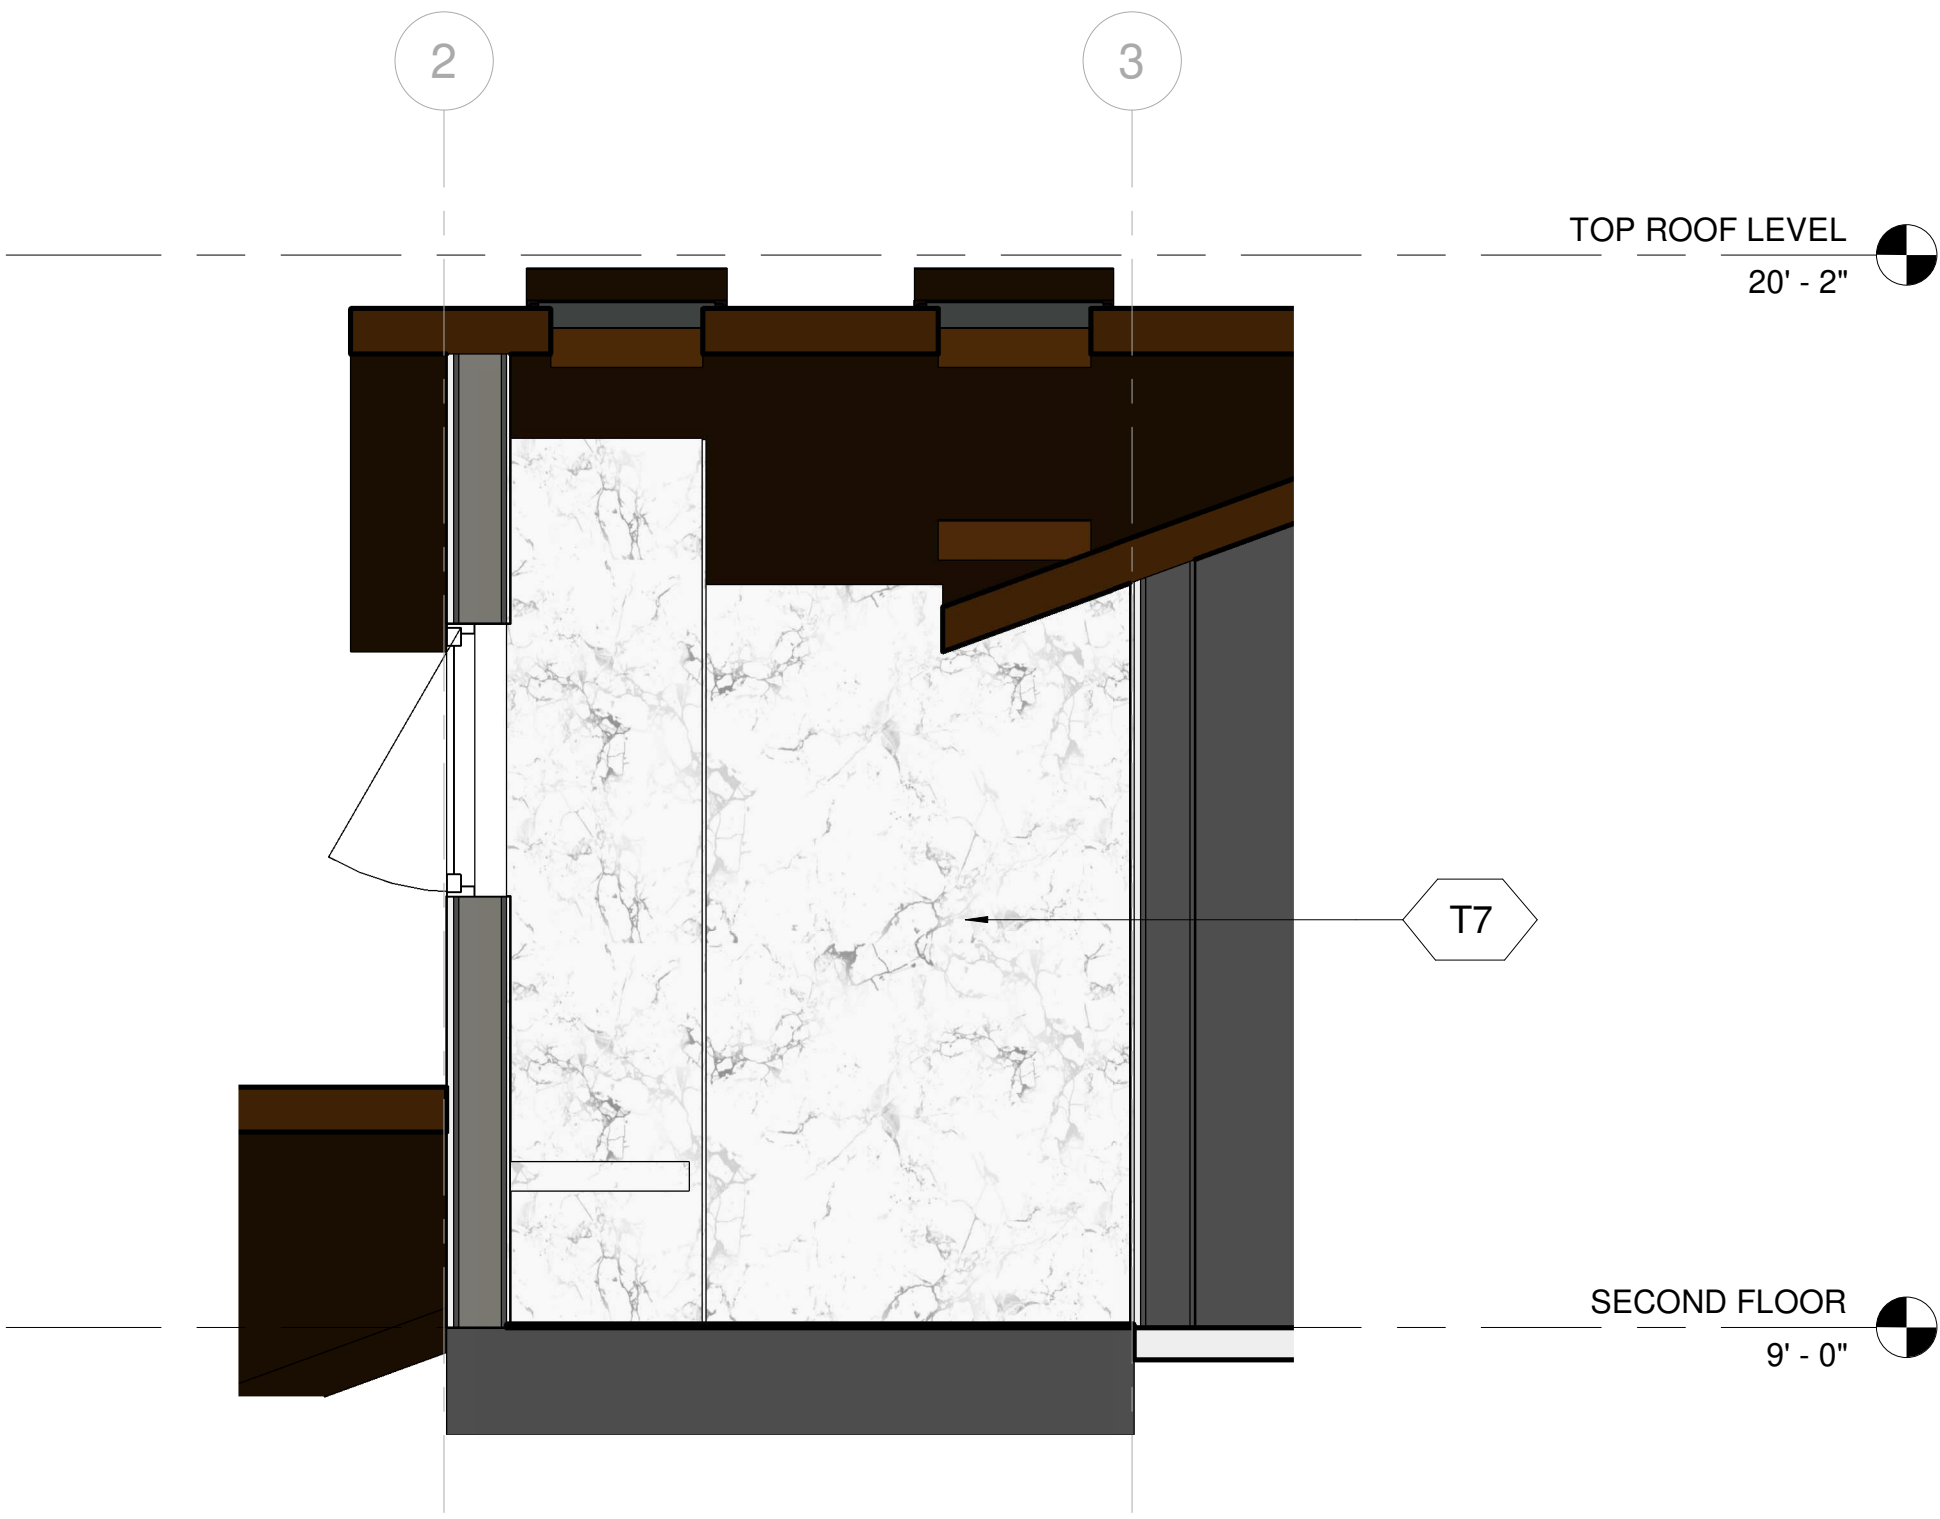


1 205 BATH ELEVATION - C  
1/2" = 1'-0"

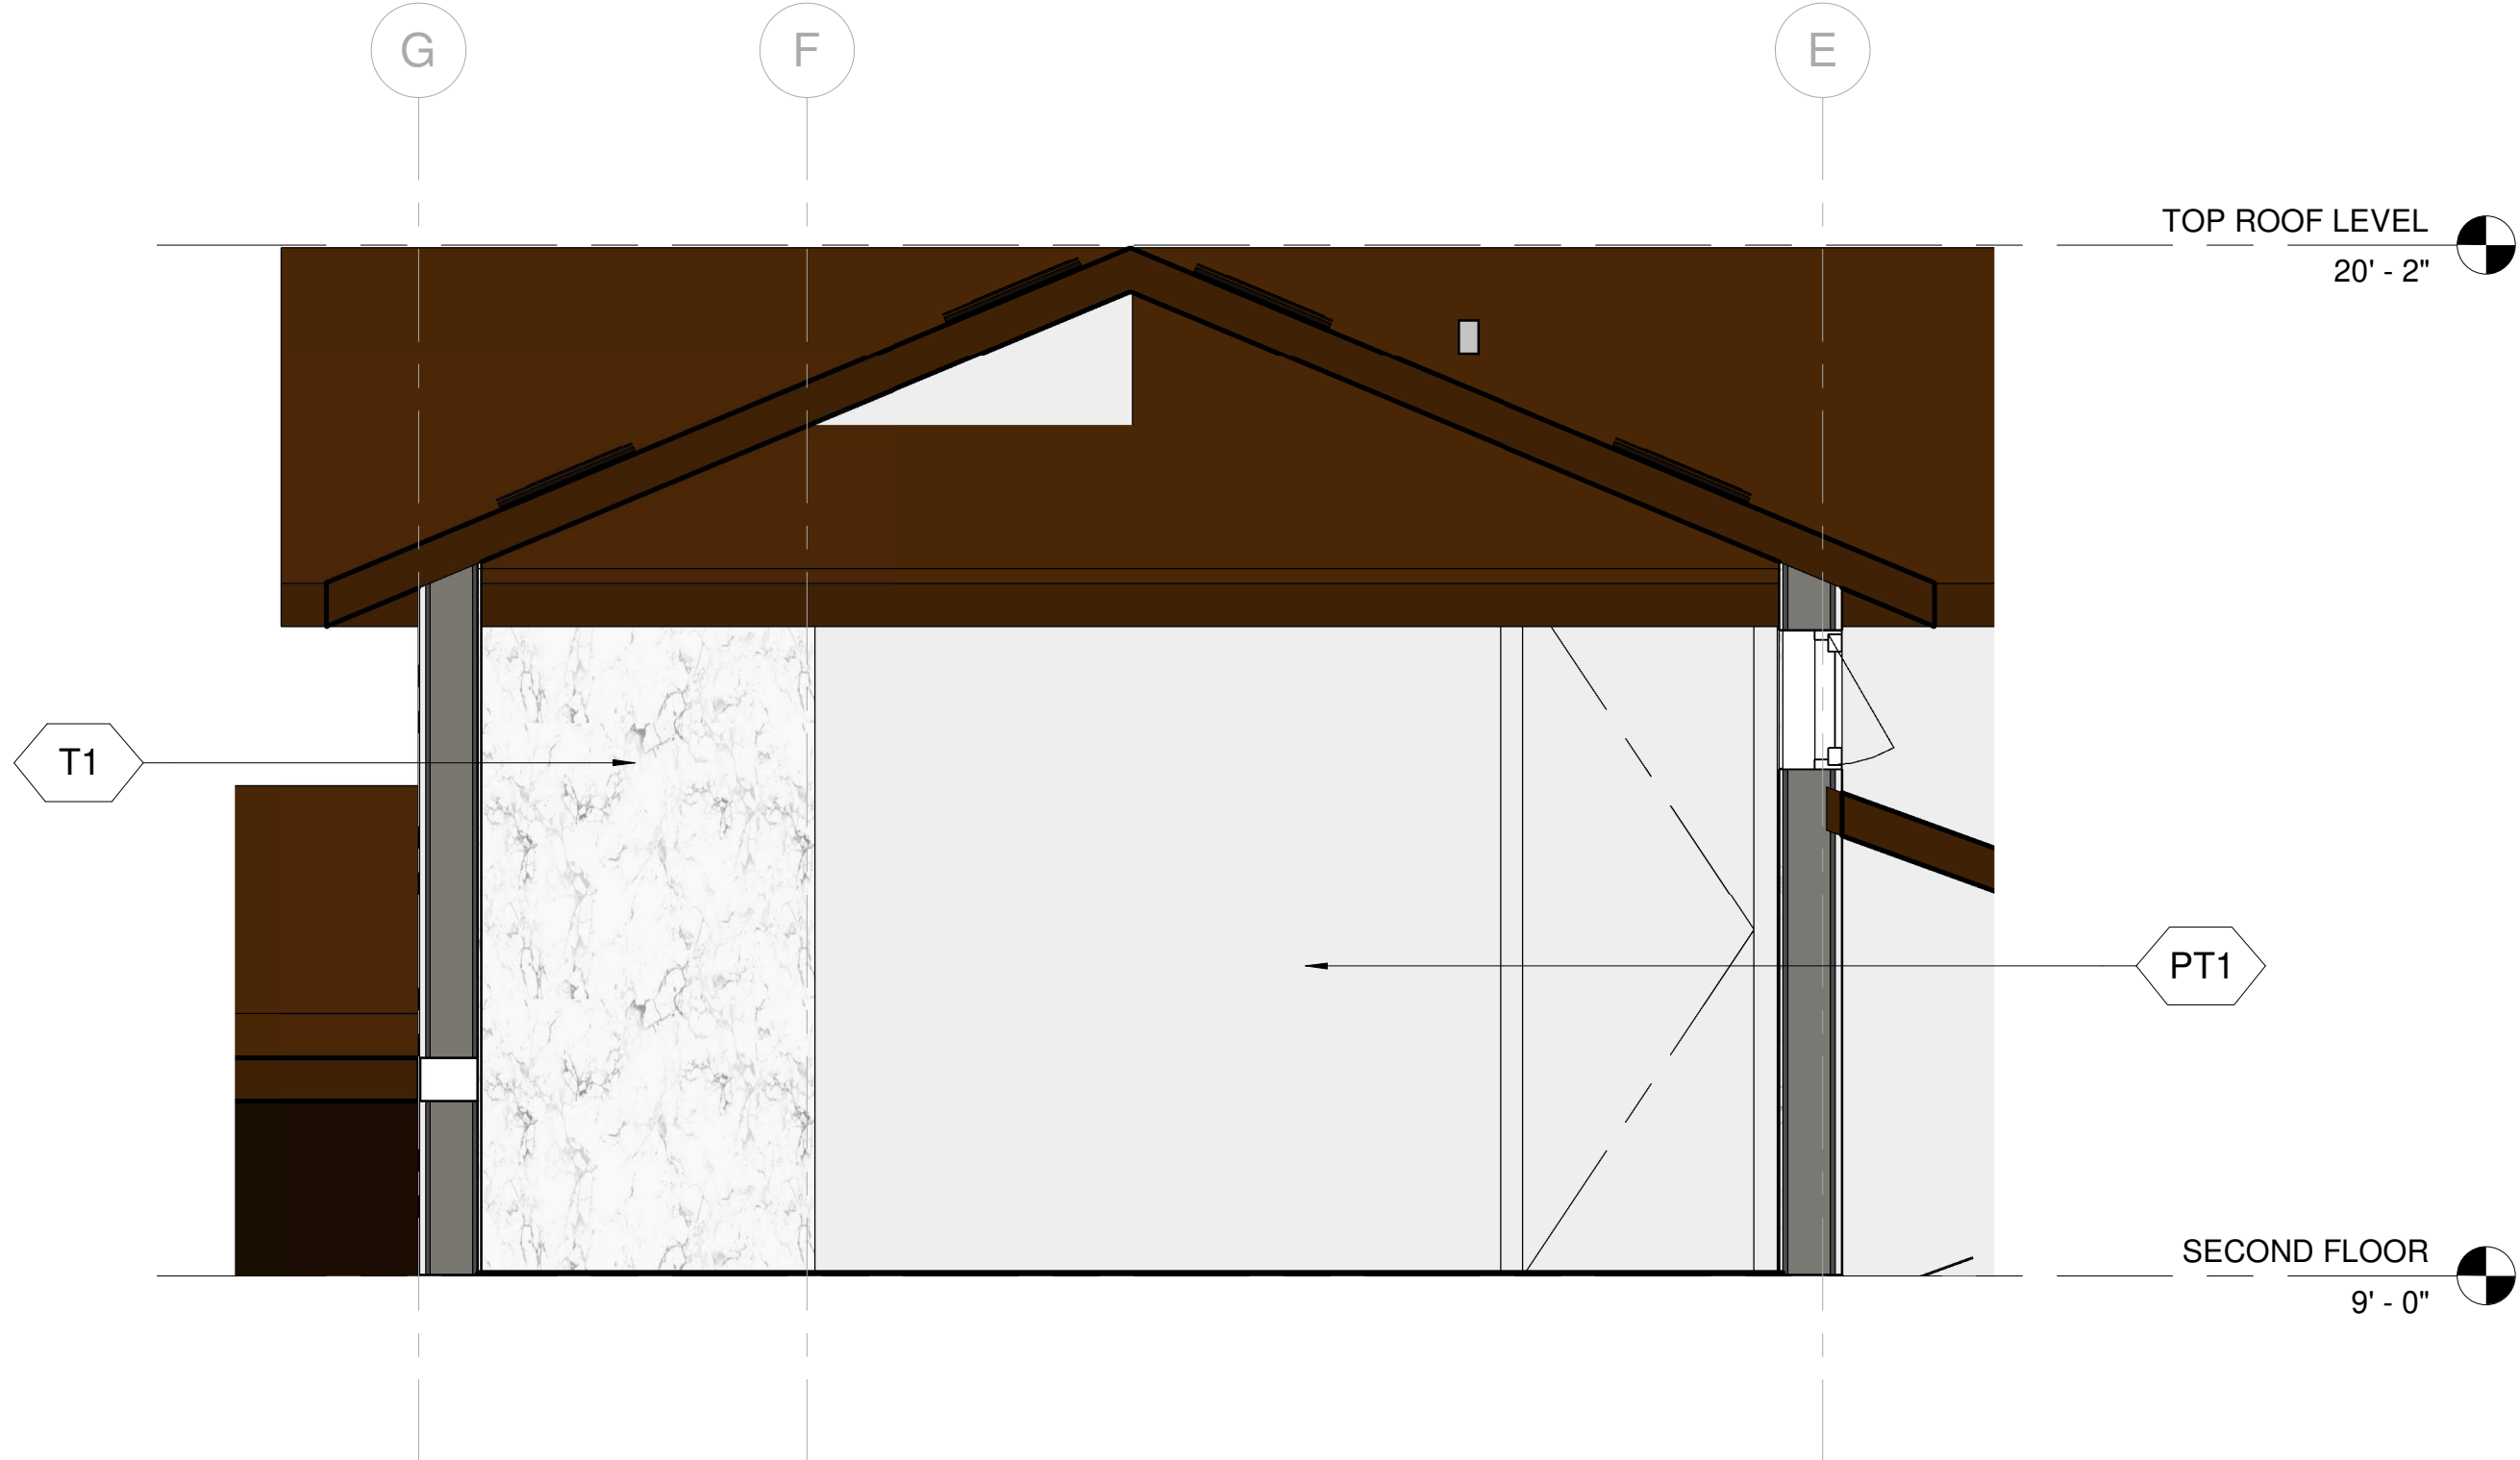

2 205 BATH ELEVATION - D  
1/2" = 1'-0"

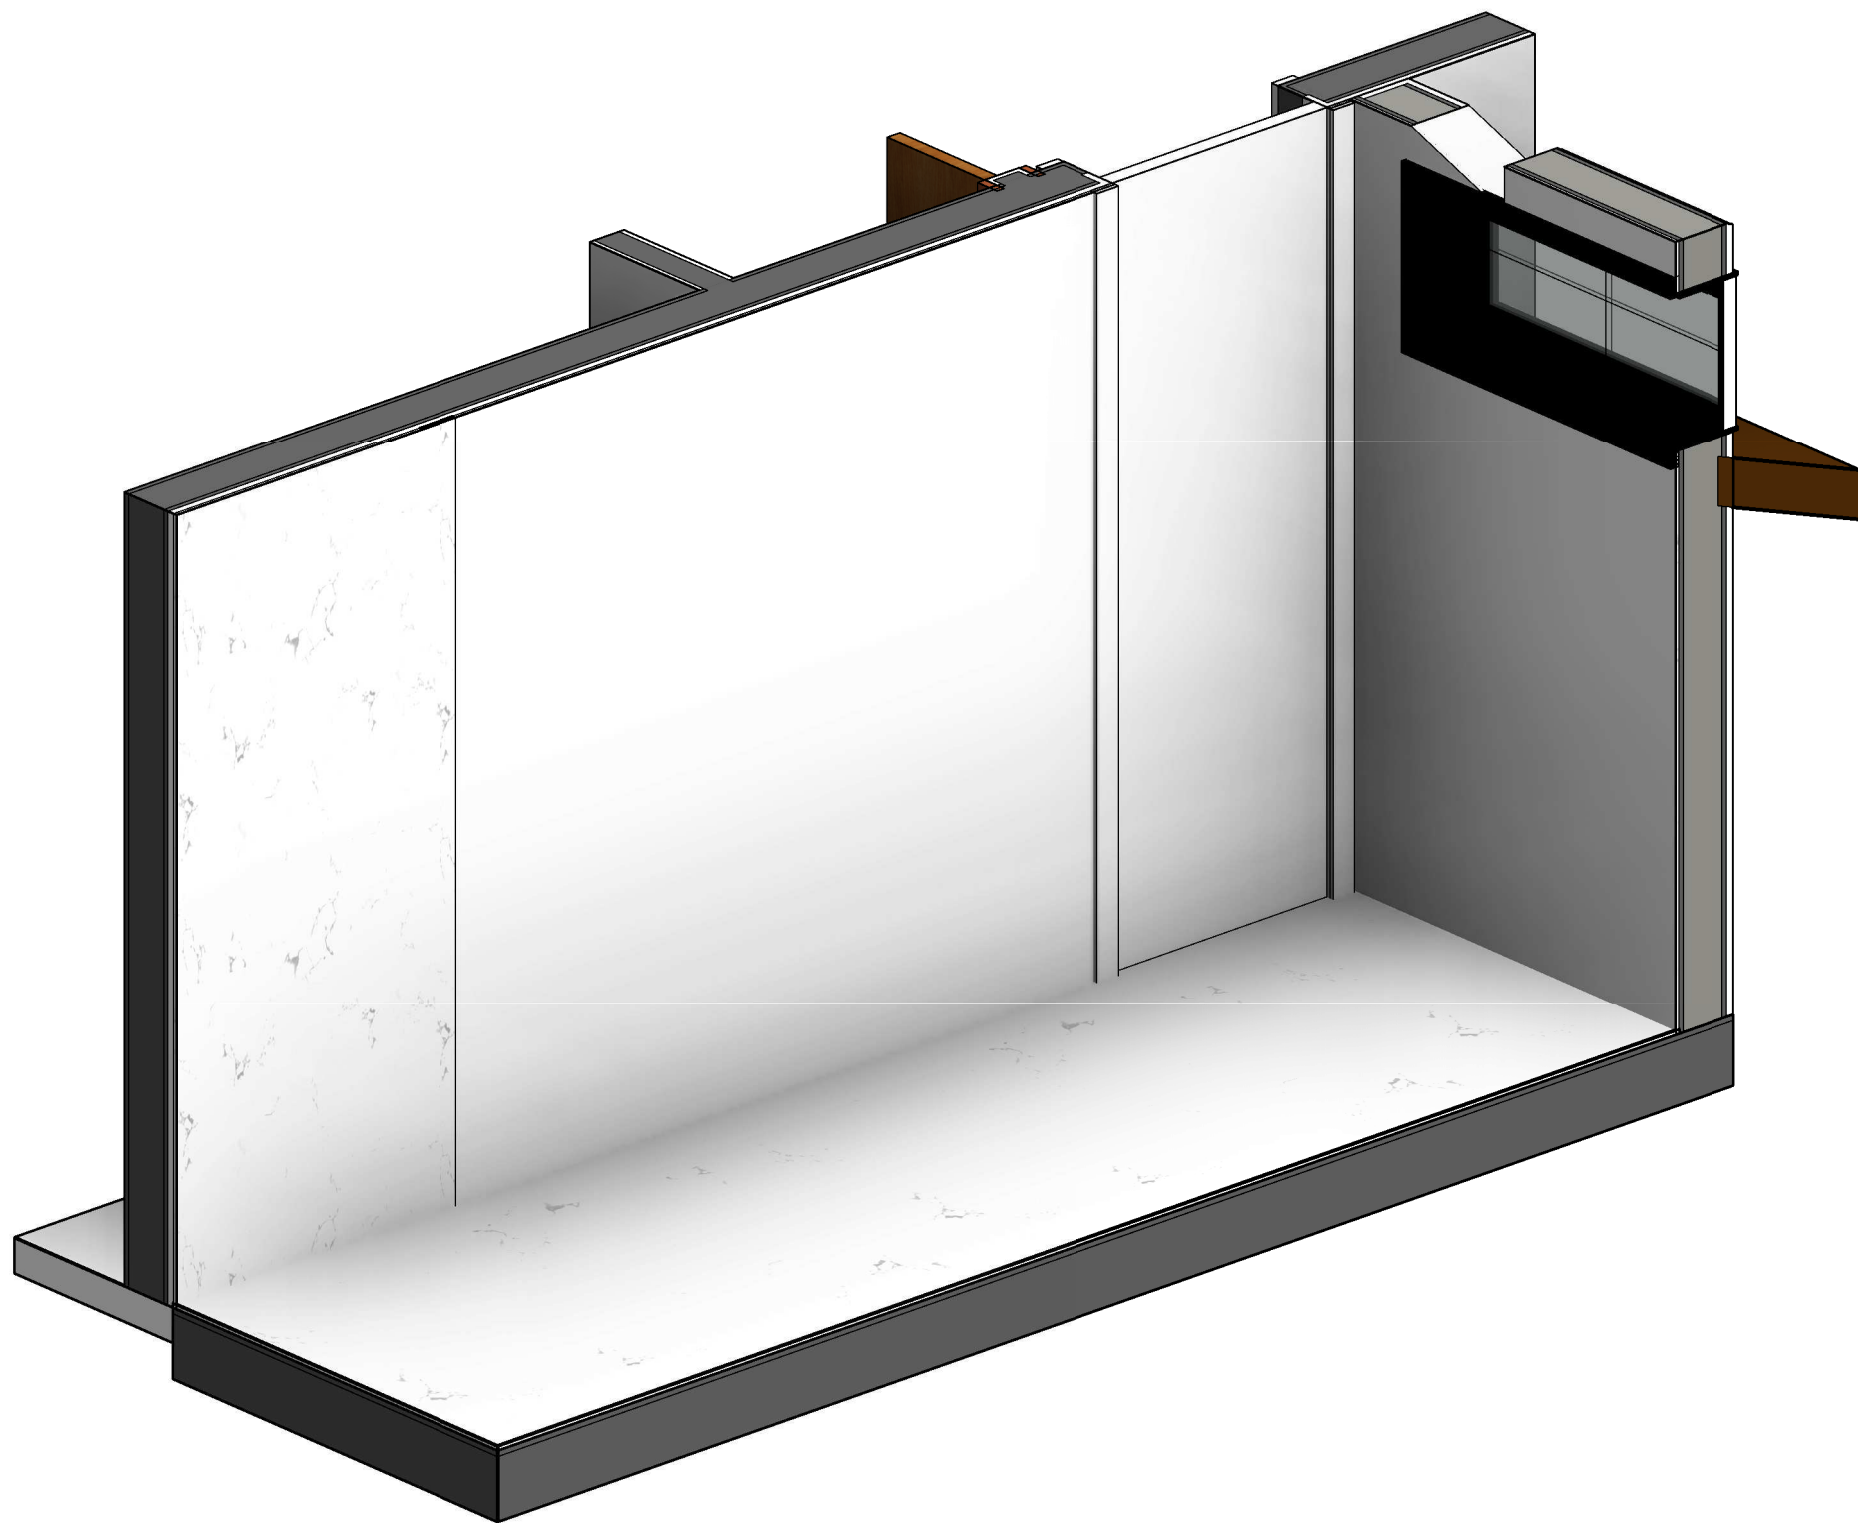

4 BATH 205.1

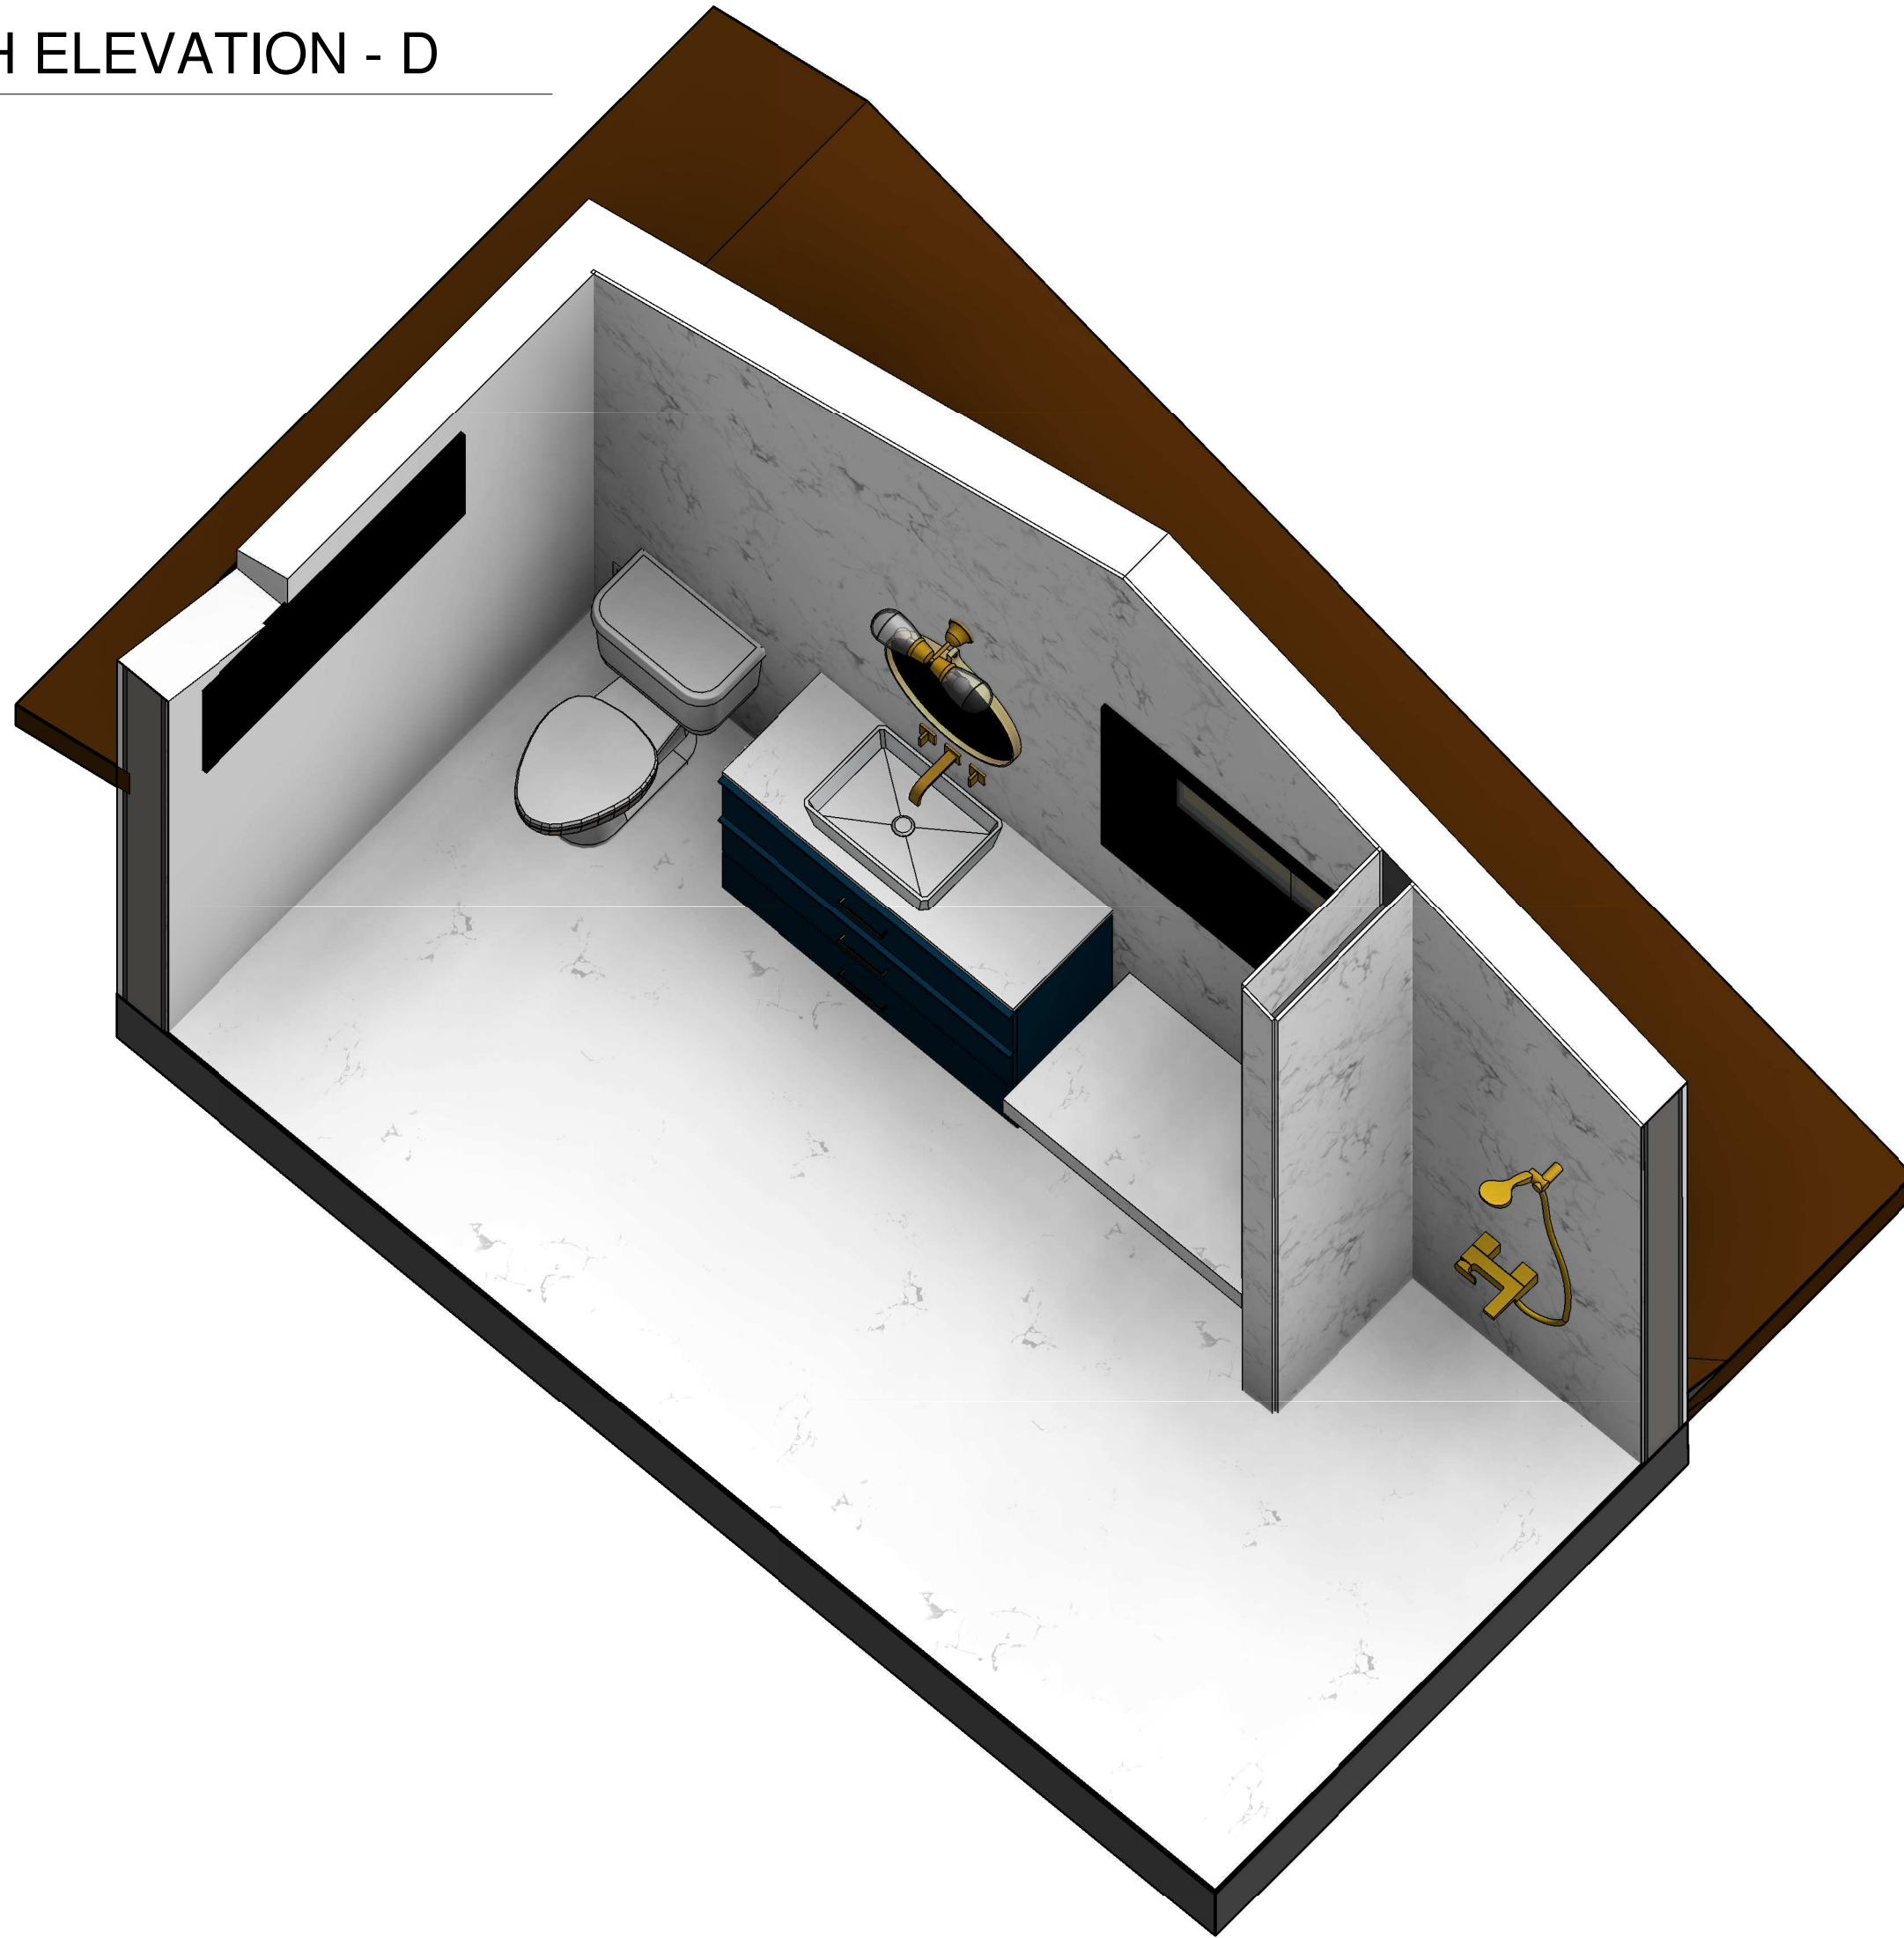

3 BATH 205.2

## KEY NOTE

- |     |   |
|-----|---|
| N1  | ADD GAS TO EXISTING FIRE PLACE                                  |
| N2  | REFURBISH EXISTING FIRE PLACE INTO 2 SIDED FIRE PLACE           |
| N3  | OUTDOOR BBQ   |
| N4  | NEW FLOORING  |
| N5  | REMOVE FLAT CEILING   |
| N6  | PROVIDE SKYLIGHT  |
| N7  | FLOATING SINK WITH VANITY                                       |
| N8  | NEW TUB   |
| N9  | NEW WATER CLOSET  |
| N10 | NEW SINK  |
| N11 | NEW BIDET   |
| N12 | GFCI OUTLET   |
| N13 | REFURBISH EXISTING WALL, PREP FOR NEW SHEAR WALL PER STRUCTURAL |
| N14 | 18" X 24" ROOF VENT 72 SQ.INCH EACH                             |
| E1  | EXISTING SKYLIGHT TO REMAIN                                     |

## LEGEND

- |  |                                   |
|--|-----------------------------------|
|  | FIXTURE TAG REFER TO A8.9 & A8.10 |
|  | FINISH TAG REFER TO A8.9          |

**DESIGN EVEREST**  
CONSULTING ENGINEERS

ENLARGED DETAILS-BATH 205  
AHMED RENOVATION  
ALINA AHMED  
LOT 15  
1081 NOTTINGHAM WAY  
LOS ALTOS, CA 94024

DELTA DESCRIPTION:  
CITY SUBMITTAL

DATE:  
22/09/17

No.

DATE: 22/09/17

SCALE: As indicated

DRAWN BY :


CKD BY:

PROJECT : 202107199


DRAWING NO.

A-8.6.2




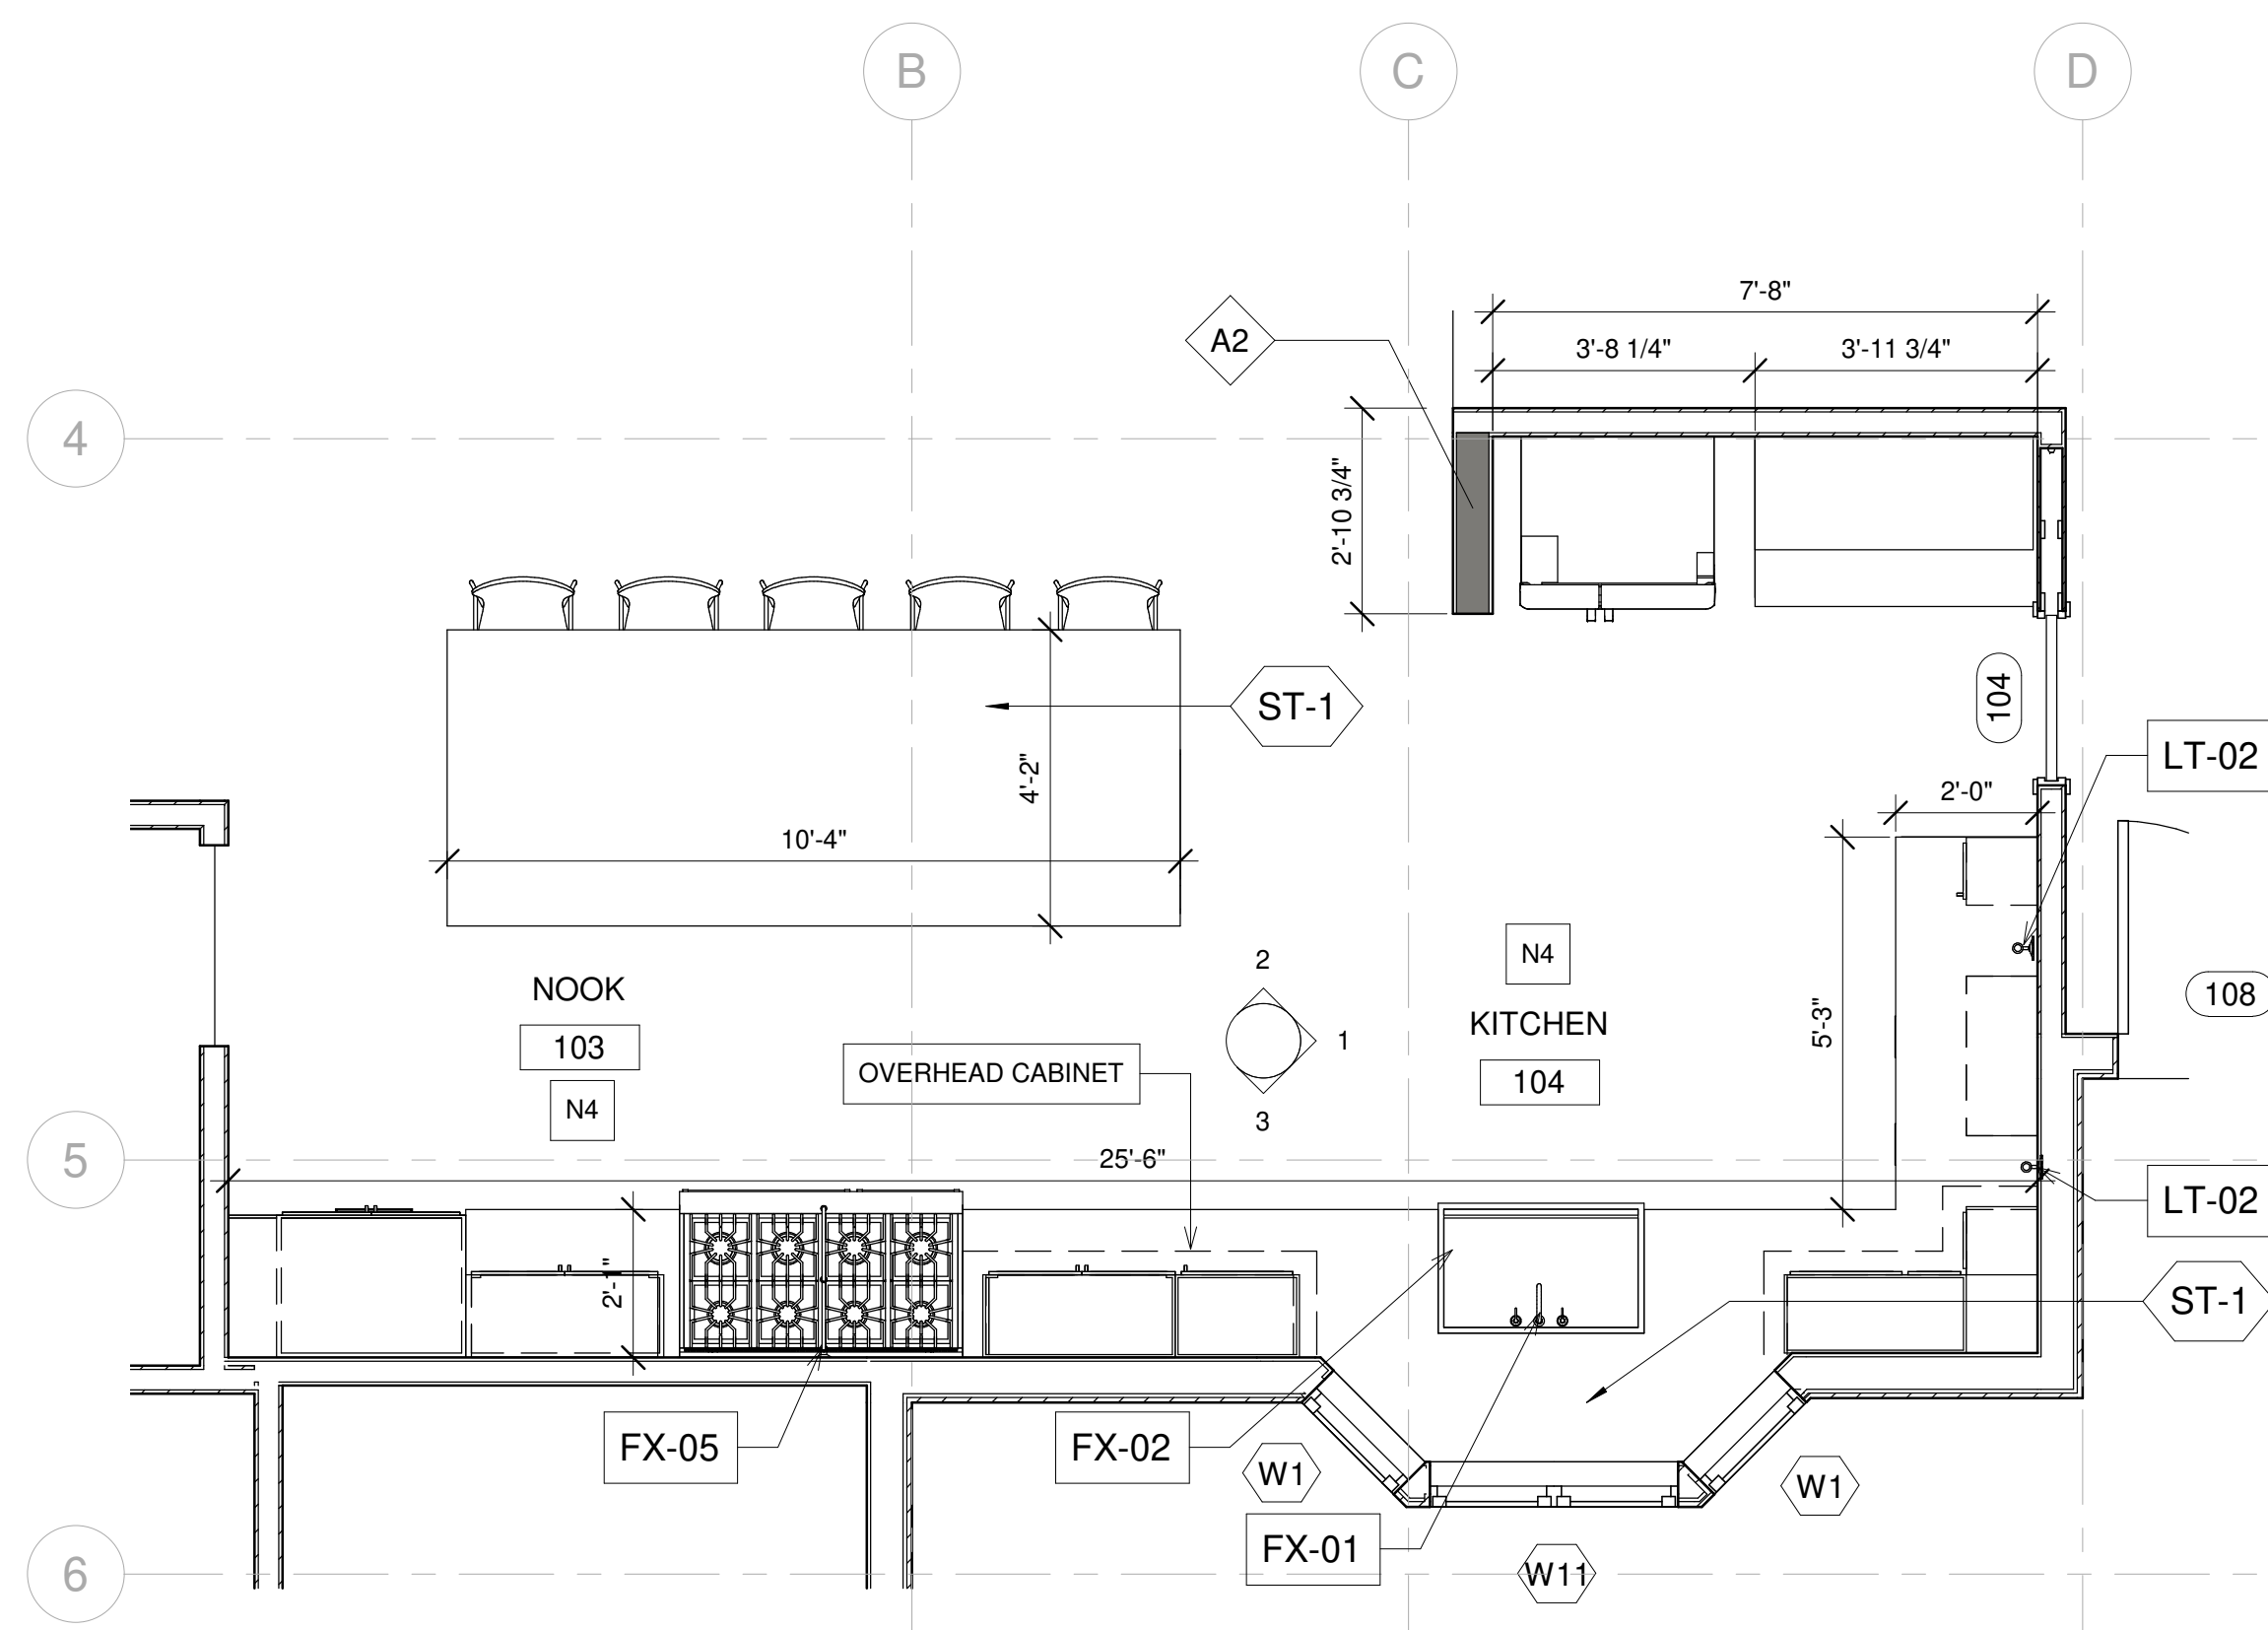

## 1 KITCHEN LAYOUT PLAN

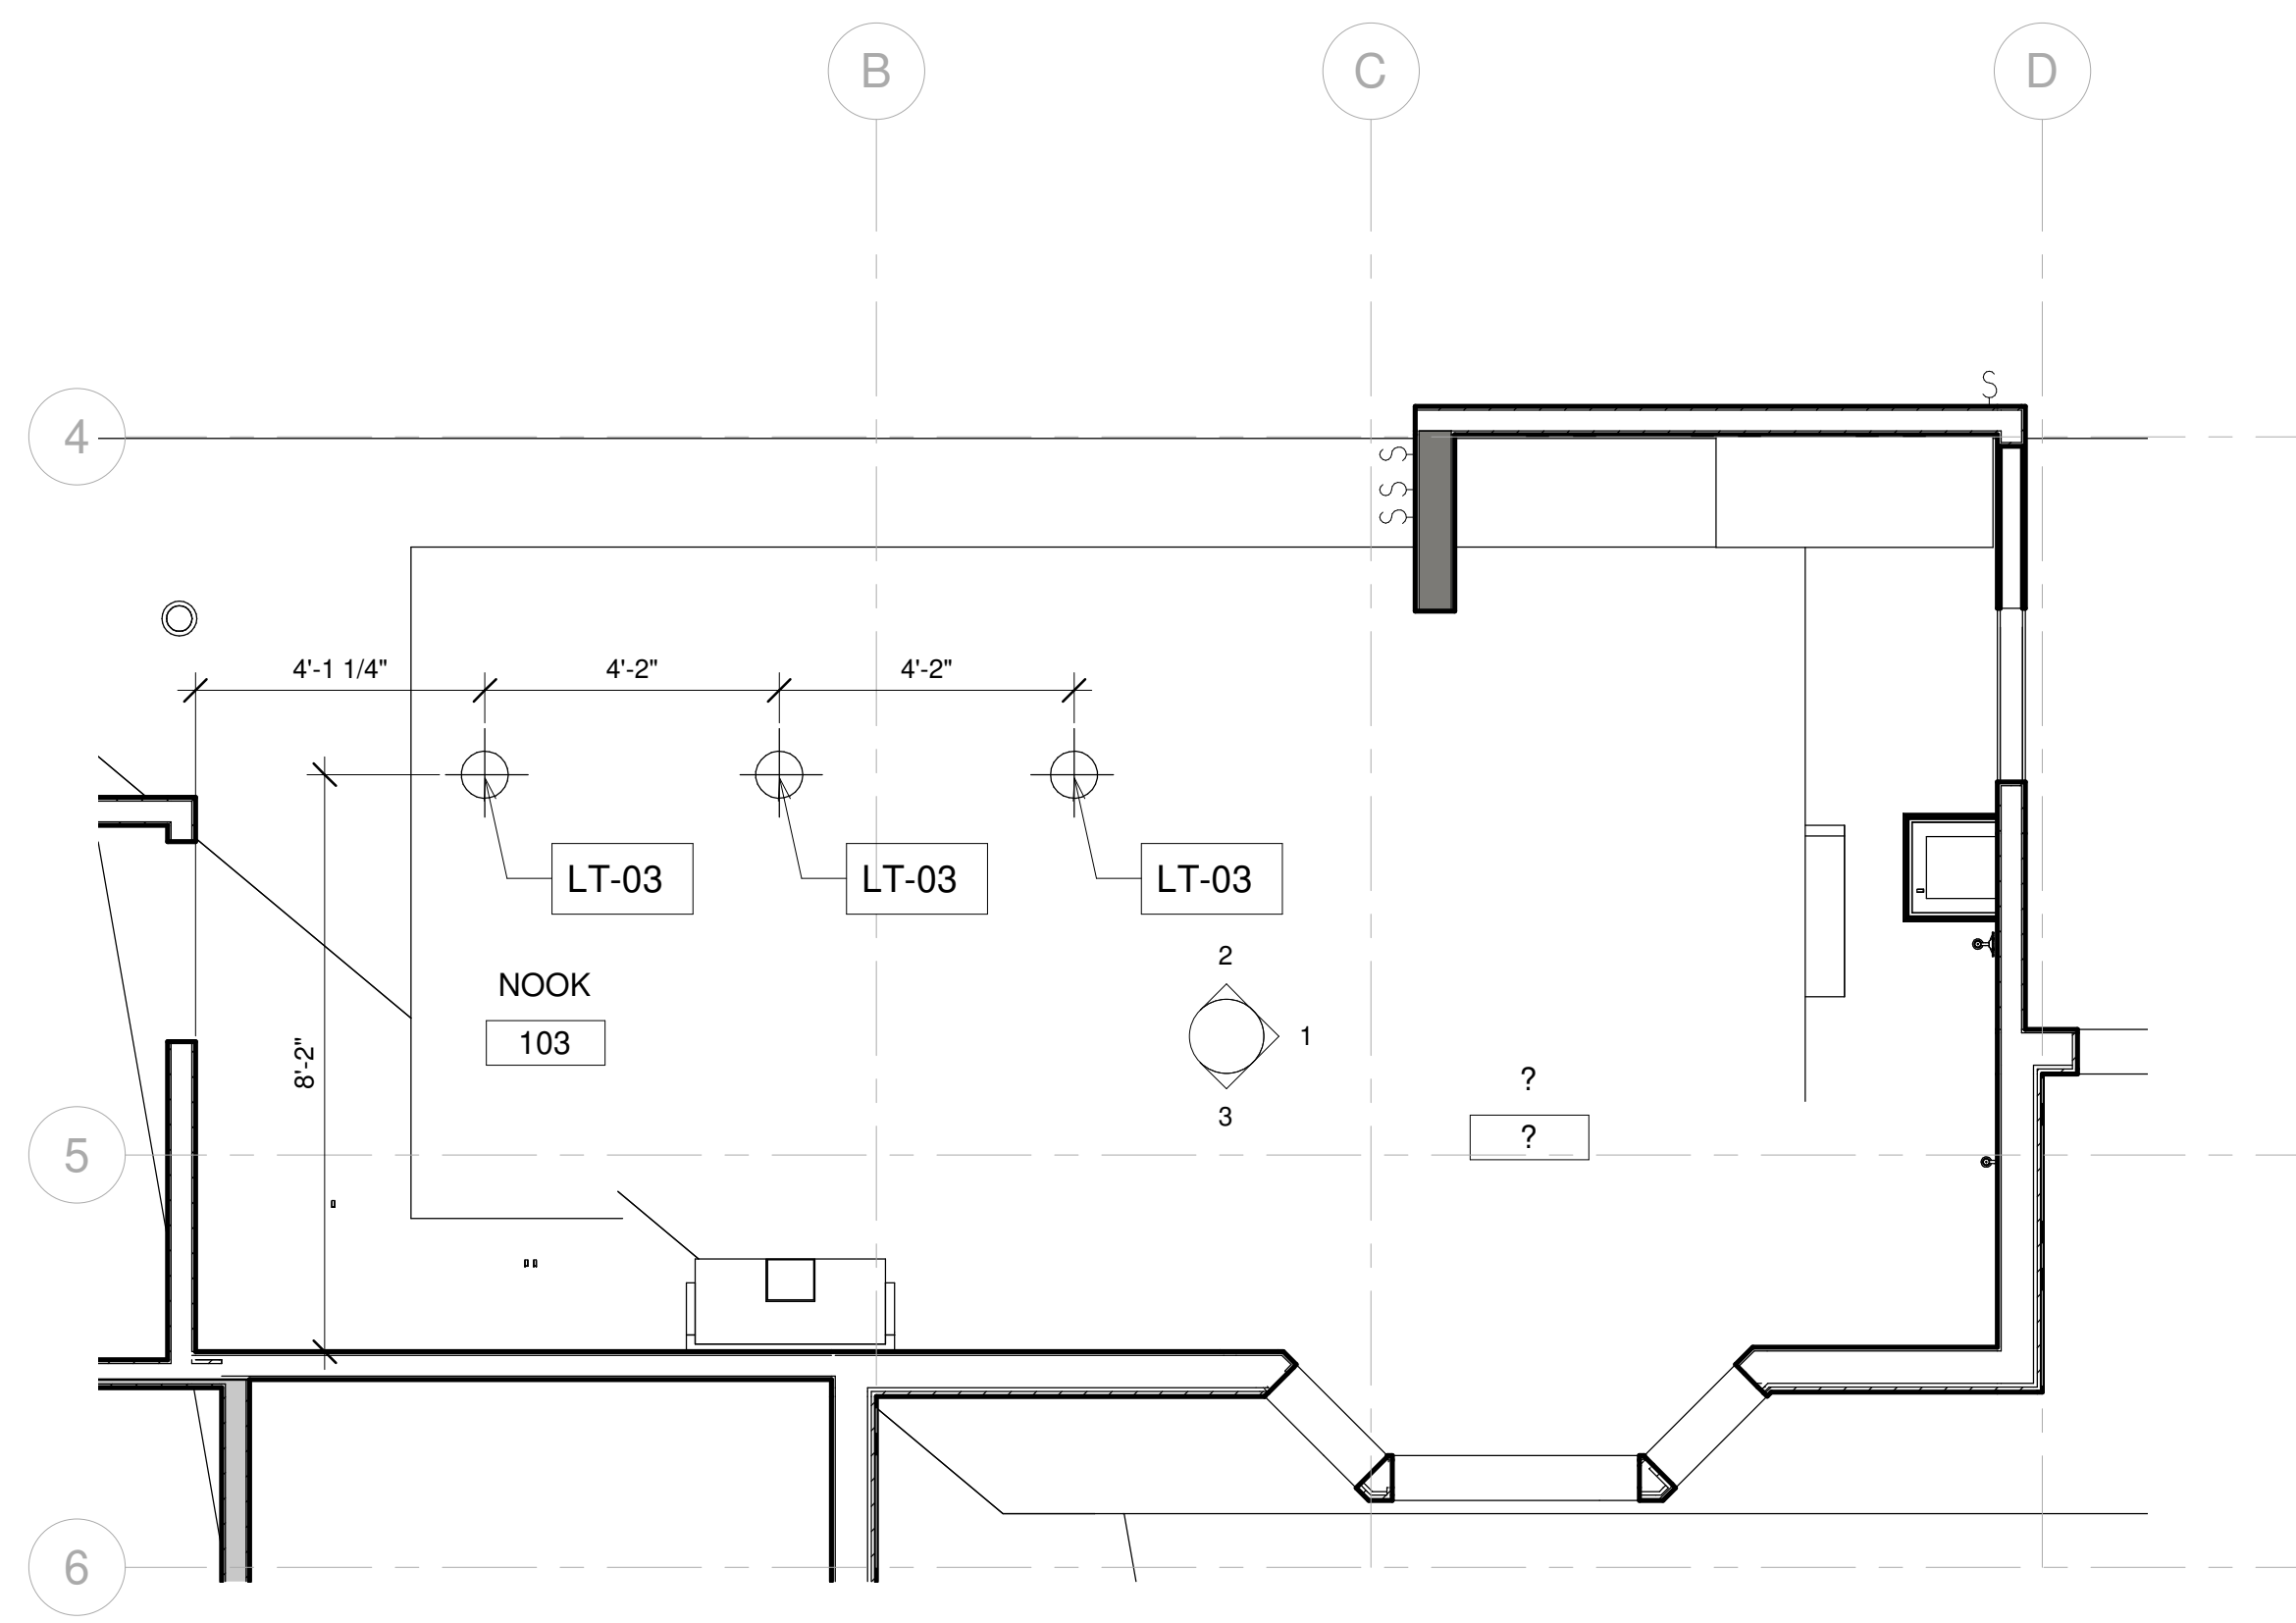

6 KITCHEN RCP  
3/8" = 1'-0"

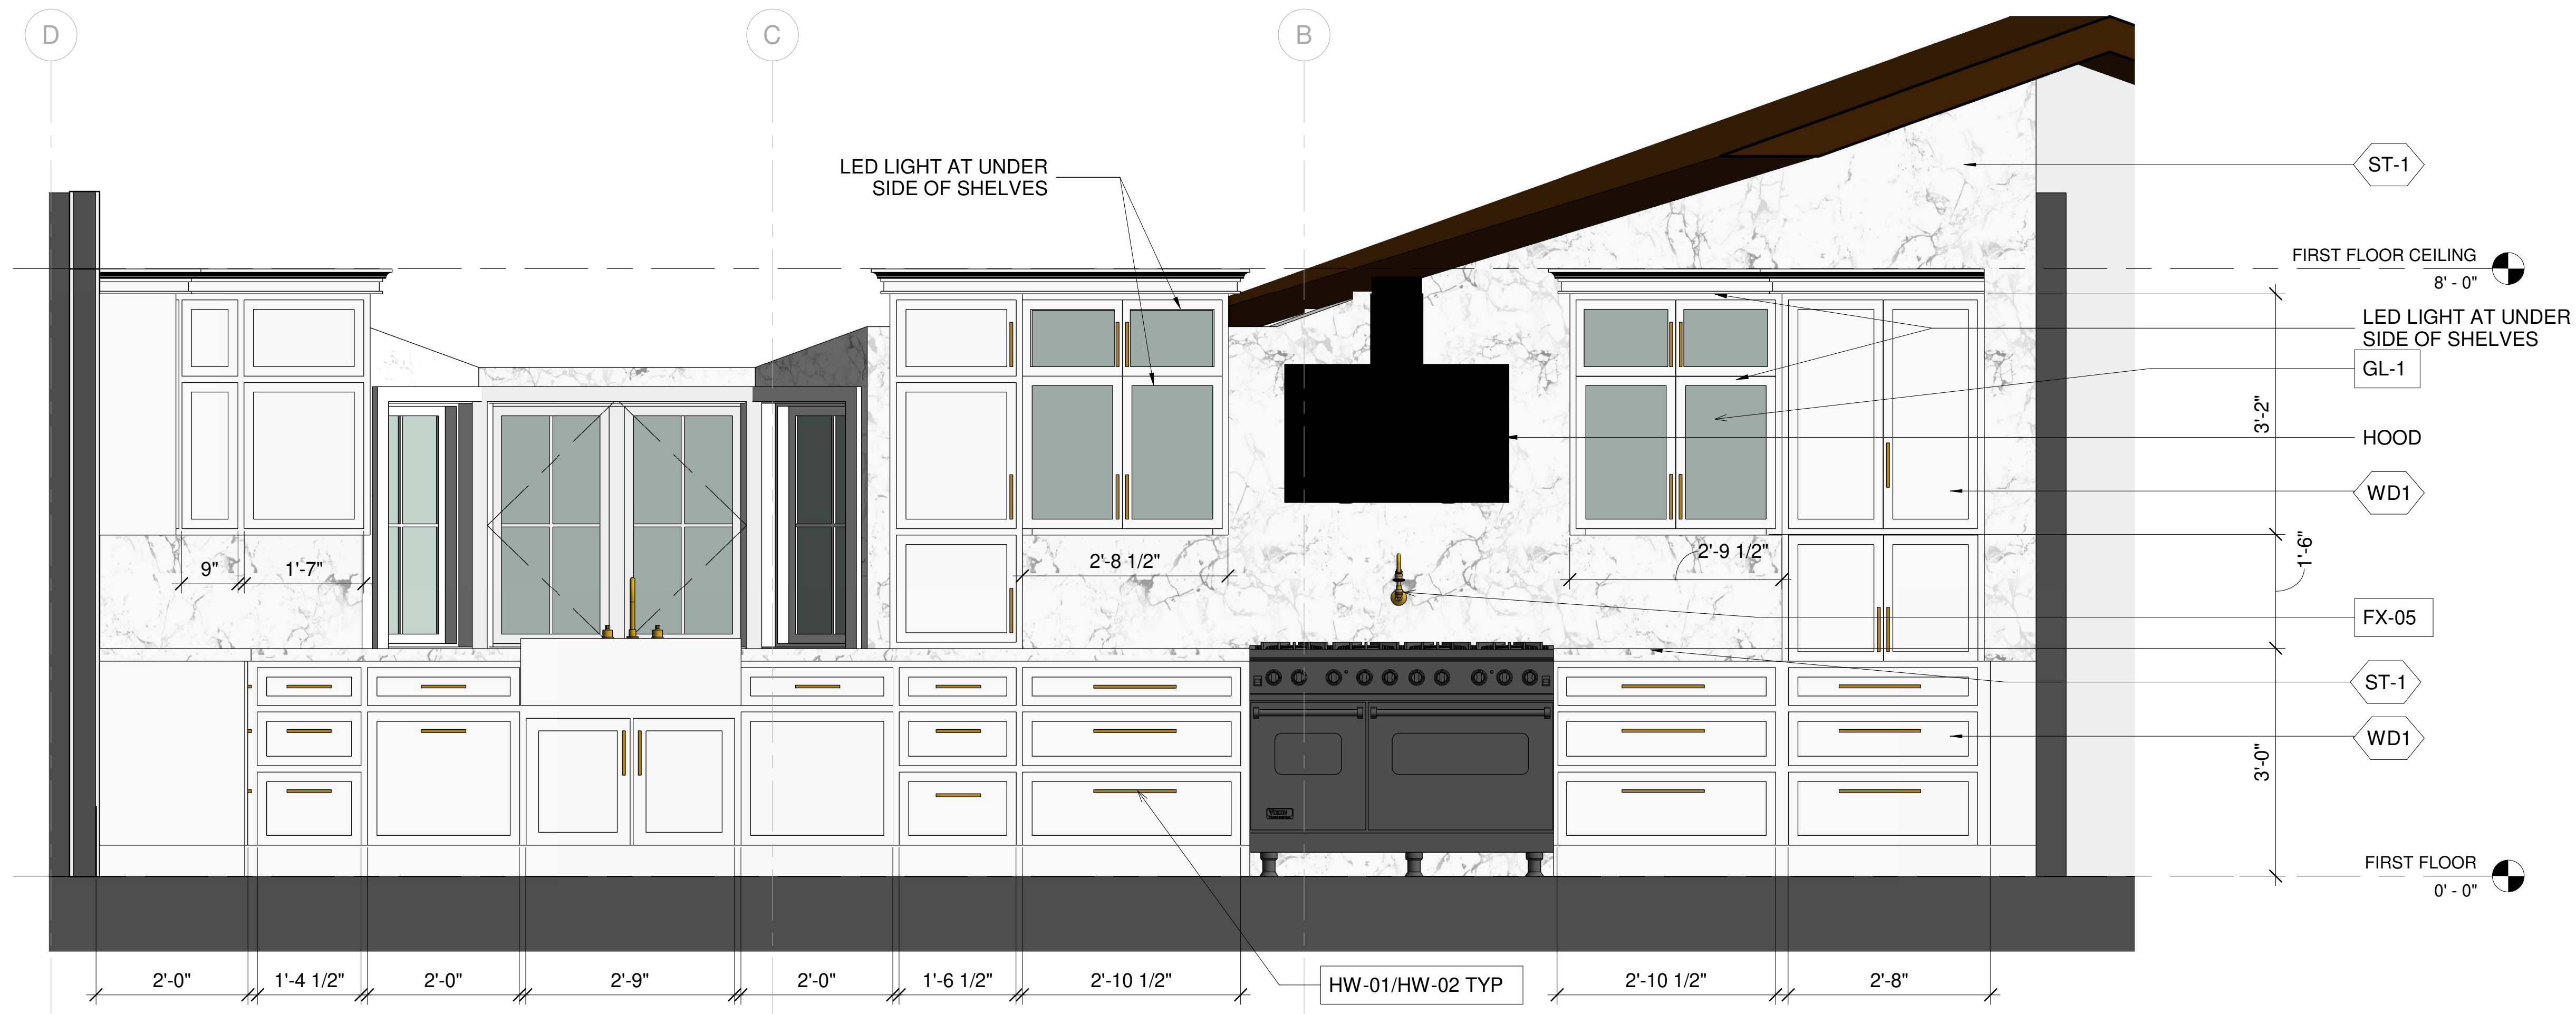



3 KITCHEN 104 ELEVATION-B  
3/4" = 1'-0"

KEY NOTE

N1	ADD GAS TO EXISTING FIRE PLACE
N2	REFURBISH EXISTING FIRE PLACE INTO 2 SIDED FIRE PLACE
N3	OUTDOOR BBQ
N4	NEW FLOORING
N5	REMOVE FLAT CEILING
N6	PROVIDE SKYLIGHT
N7	FLOATING SINK WITH VANITY
N8	NEW TUB
N9	NEW WATER CLOSET
N10	NEW SINK
N11	NEW BIDET
N12	GFCI OUTLET
N13	REFURBISH EXISTING WALL, PREP FOR NEW SHEAR WALL PER STRUCTURAL
N14	18" X 24" ROOF VENT 72 SQ.INCH EACH
E1	EXISTING SKYLIGHT TO REMAIN

## LEGEND

	FIXTURE TAG REFER TO A8.9 & A8.10
	FINISH TAG REFER TO A8.9

**DESIGN EVEREST**  
**CONSULTING ENGINEERS**  
365 FLOWER LANE

PHONE: (888) 311-3015 FAX: (650) 695-1801

## KITCHEN DETAILS

AHMED RENOVATION  
 ALINA AHMED  
 LOT 15

LOS ALTOS, CA 94024

CITY SUBMITTAL

CITY SUBMITTAL

22/09/17

1

[illegible]

TE:

SALE:

## AWN E


PROJECT

OBJECT


DRAW

A.



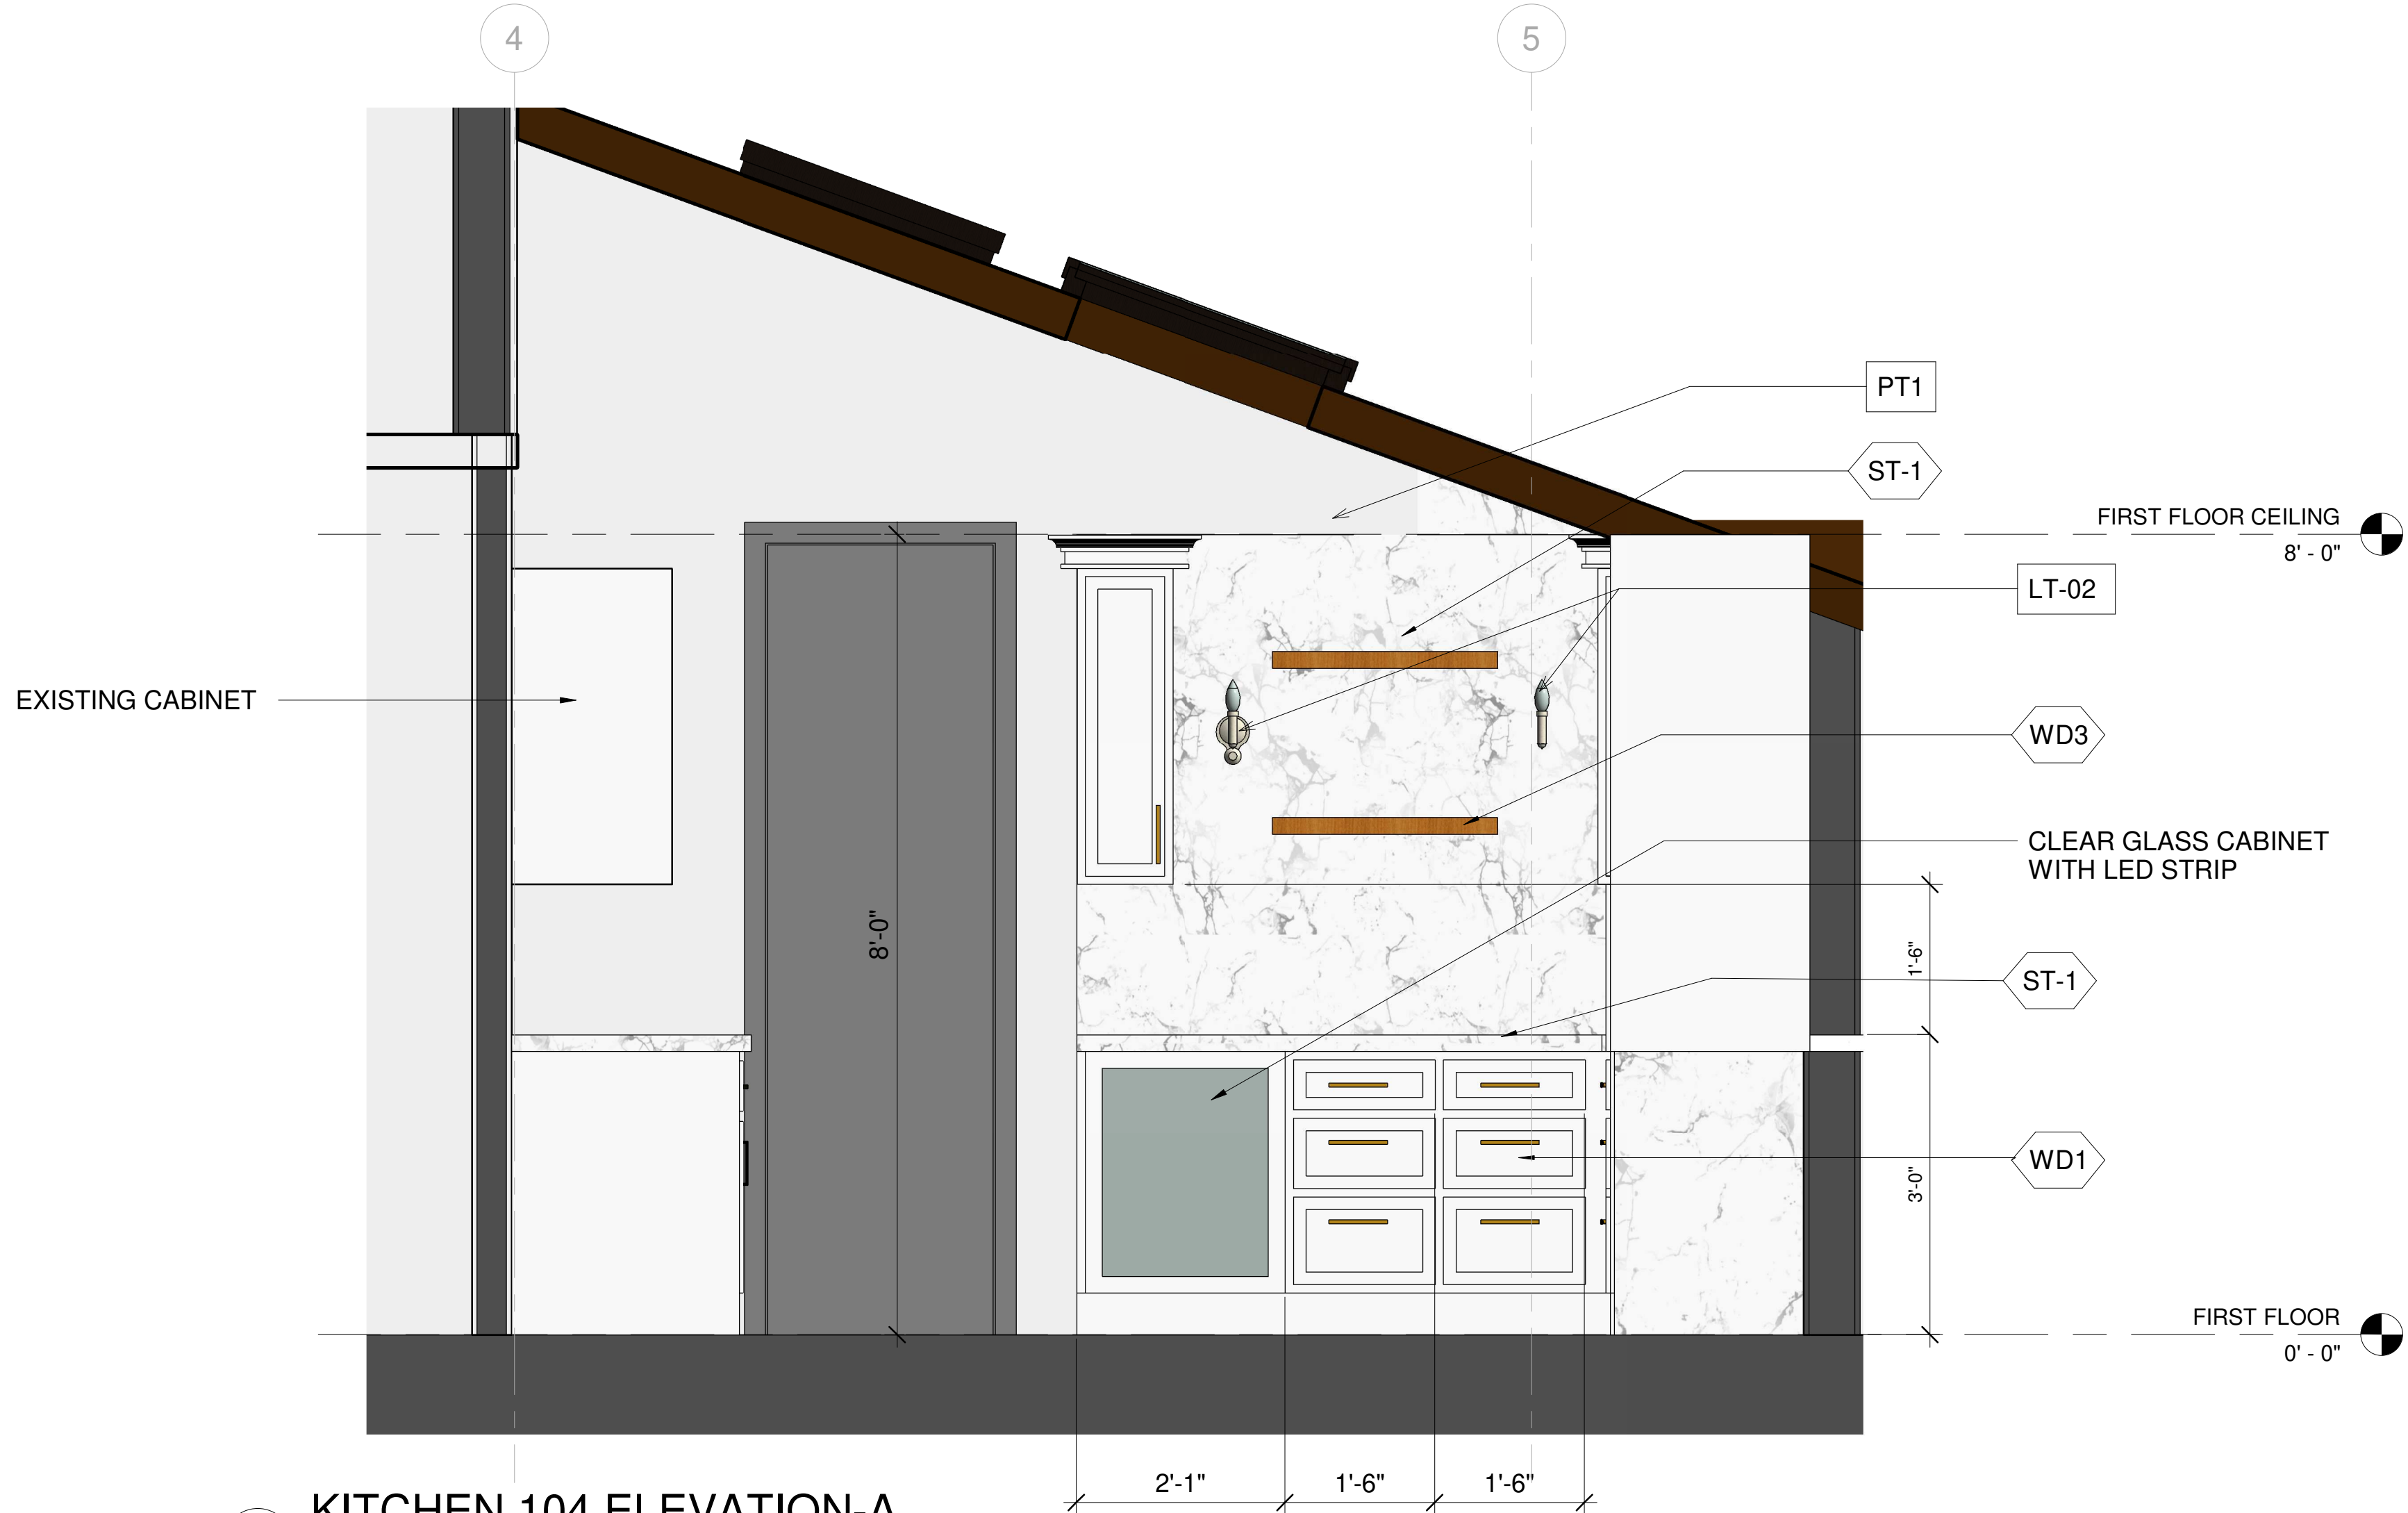

1 KITCHEN 104 ELEVATION-A  
3/4" = 1'-0"

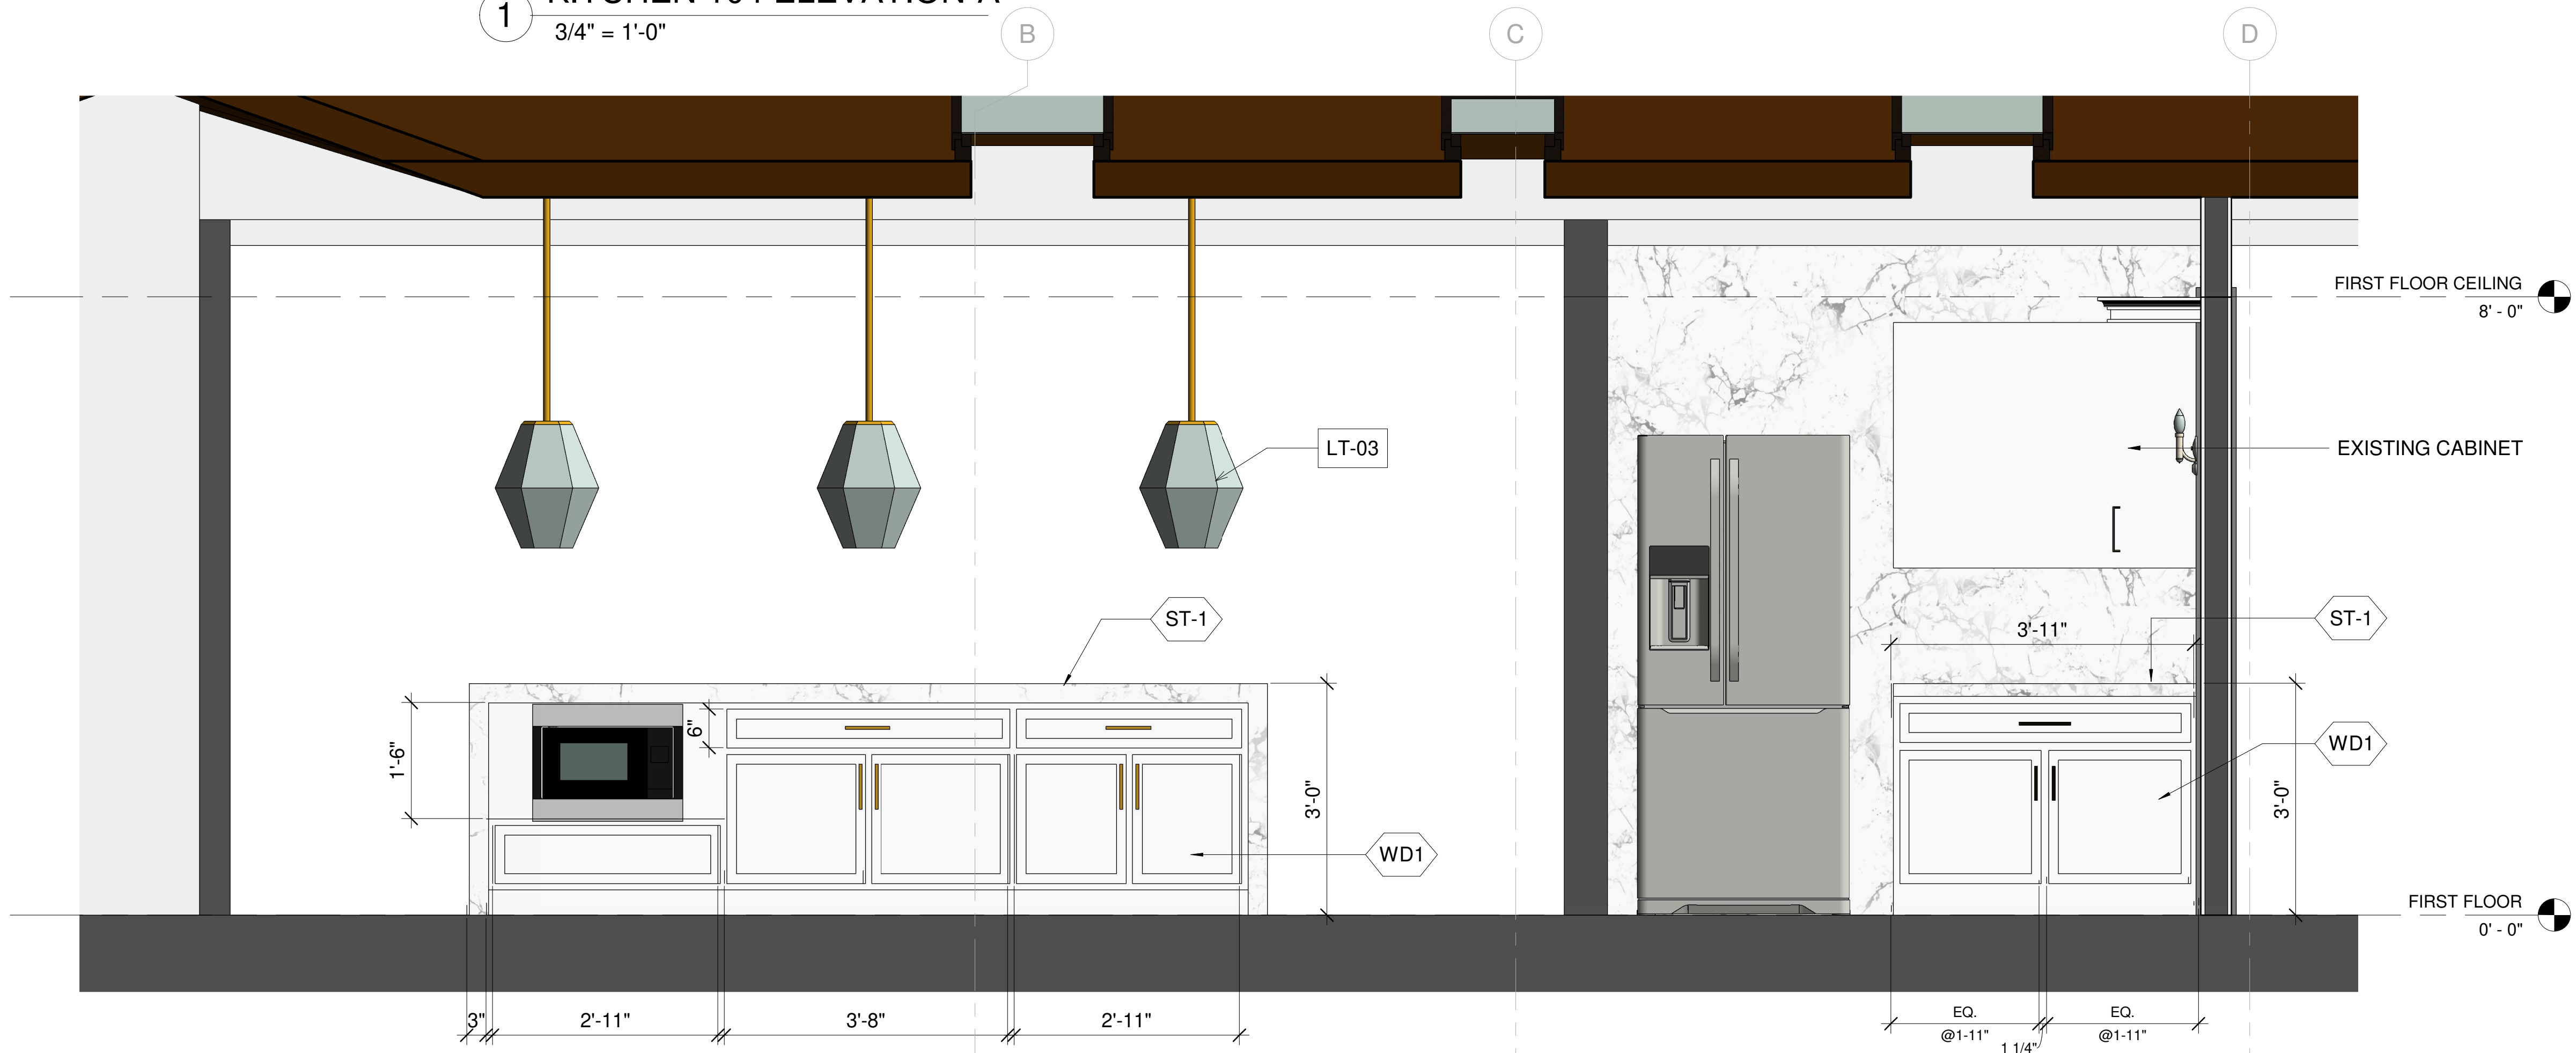

2 KITCHEN 104 ELEVATION-C  
3/4" = 1'-0"

### KEY NOTE


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N2	REFURBISH EXISTING FIRE PLACE INTO 2 SIDED FIRE PLACE
N3	OUTDOOR BBQ
N4	NEW FLOORING
N5	REMOVE FLAT CEILING
N6	PROVIDE SKYLIGHT
N7	FLOATING SINK WITH VANITY
N8	NEW TUB
N9	NEW WATER CLOSET
N10	NEW SINK
N11	NEW BIDET
N12	GFCI OUTLET
N13	REFURBISH EXISTING WALL, PREP FOR NEW SHEAR WALL PER STRUCTURAL
N14	18" X 24" ROOF VENT 72 SQ.INCH EACH
E1	EXISTING SKYLIGHT TO REMAIN

### LEGEND


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	FINISH TAG REFER TO A8.9

DATE:	22/09/17
SCALE:	As indicated
DRAWN BY :	
CKD BY:	
PROJECT :	202107199




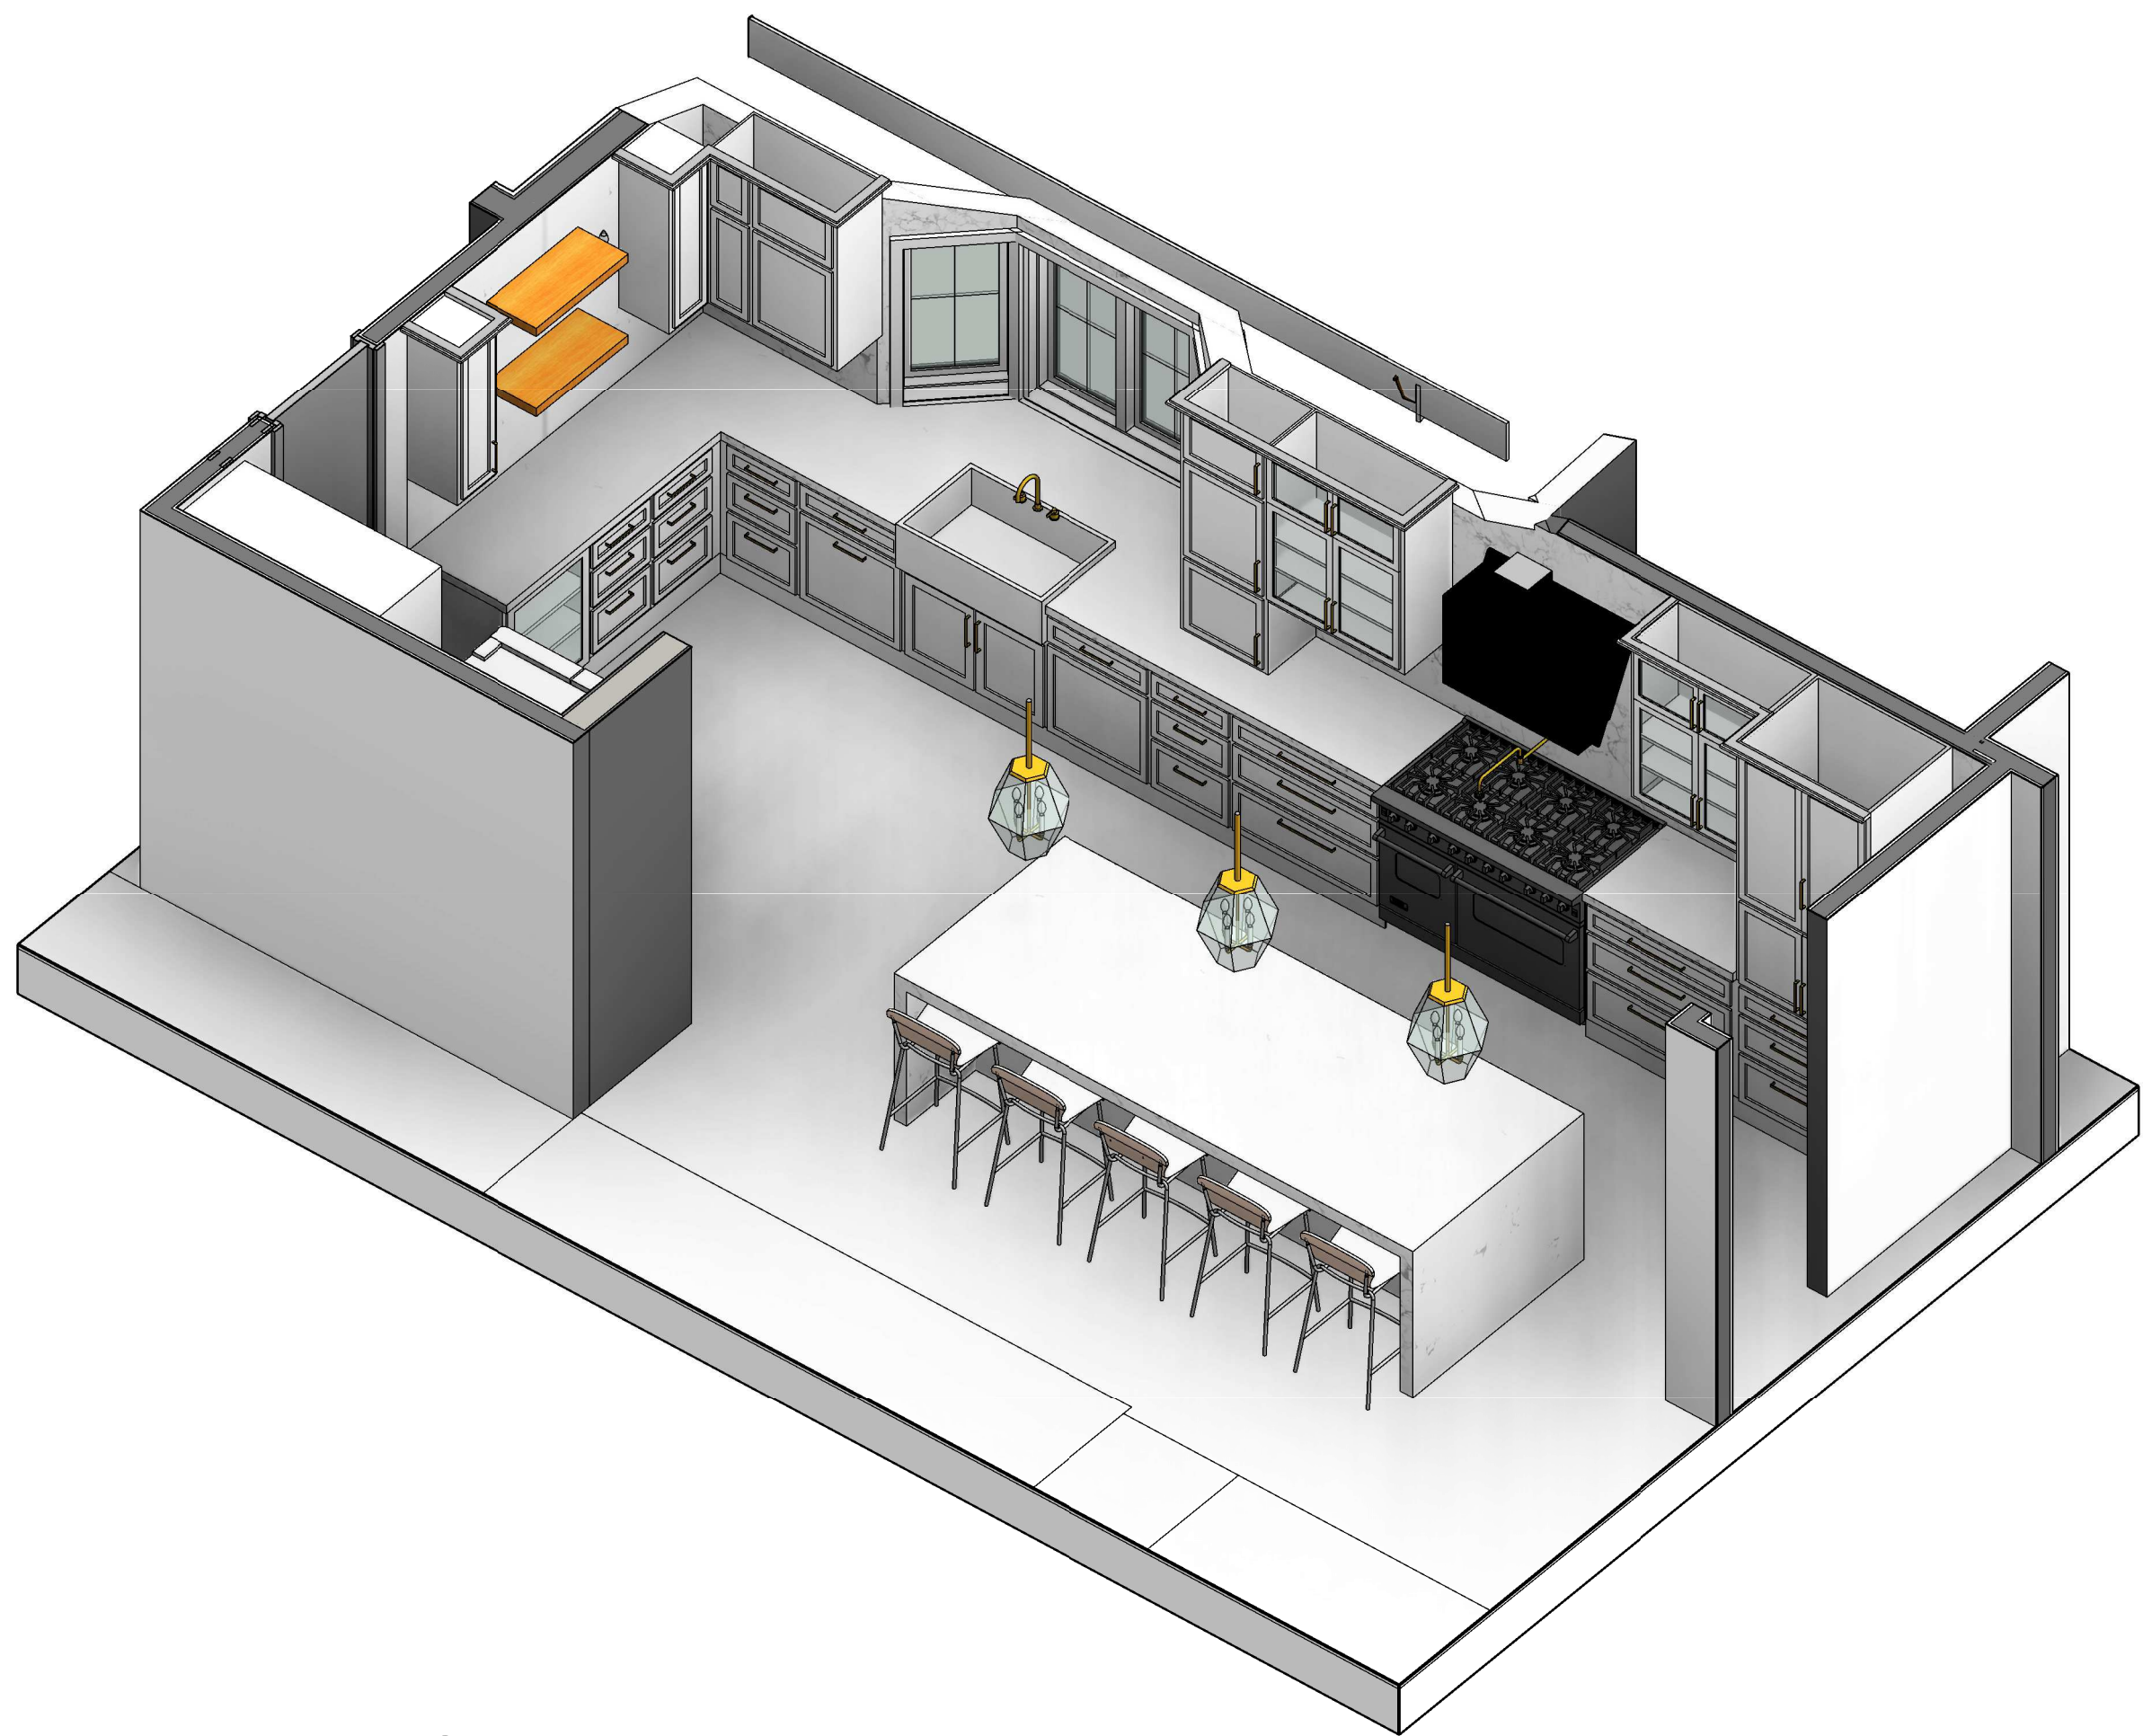


1 KITCHEN VIEW-1

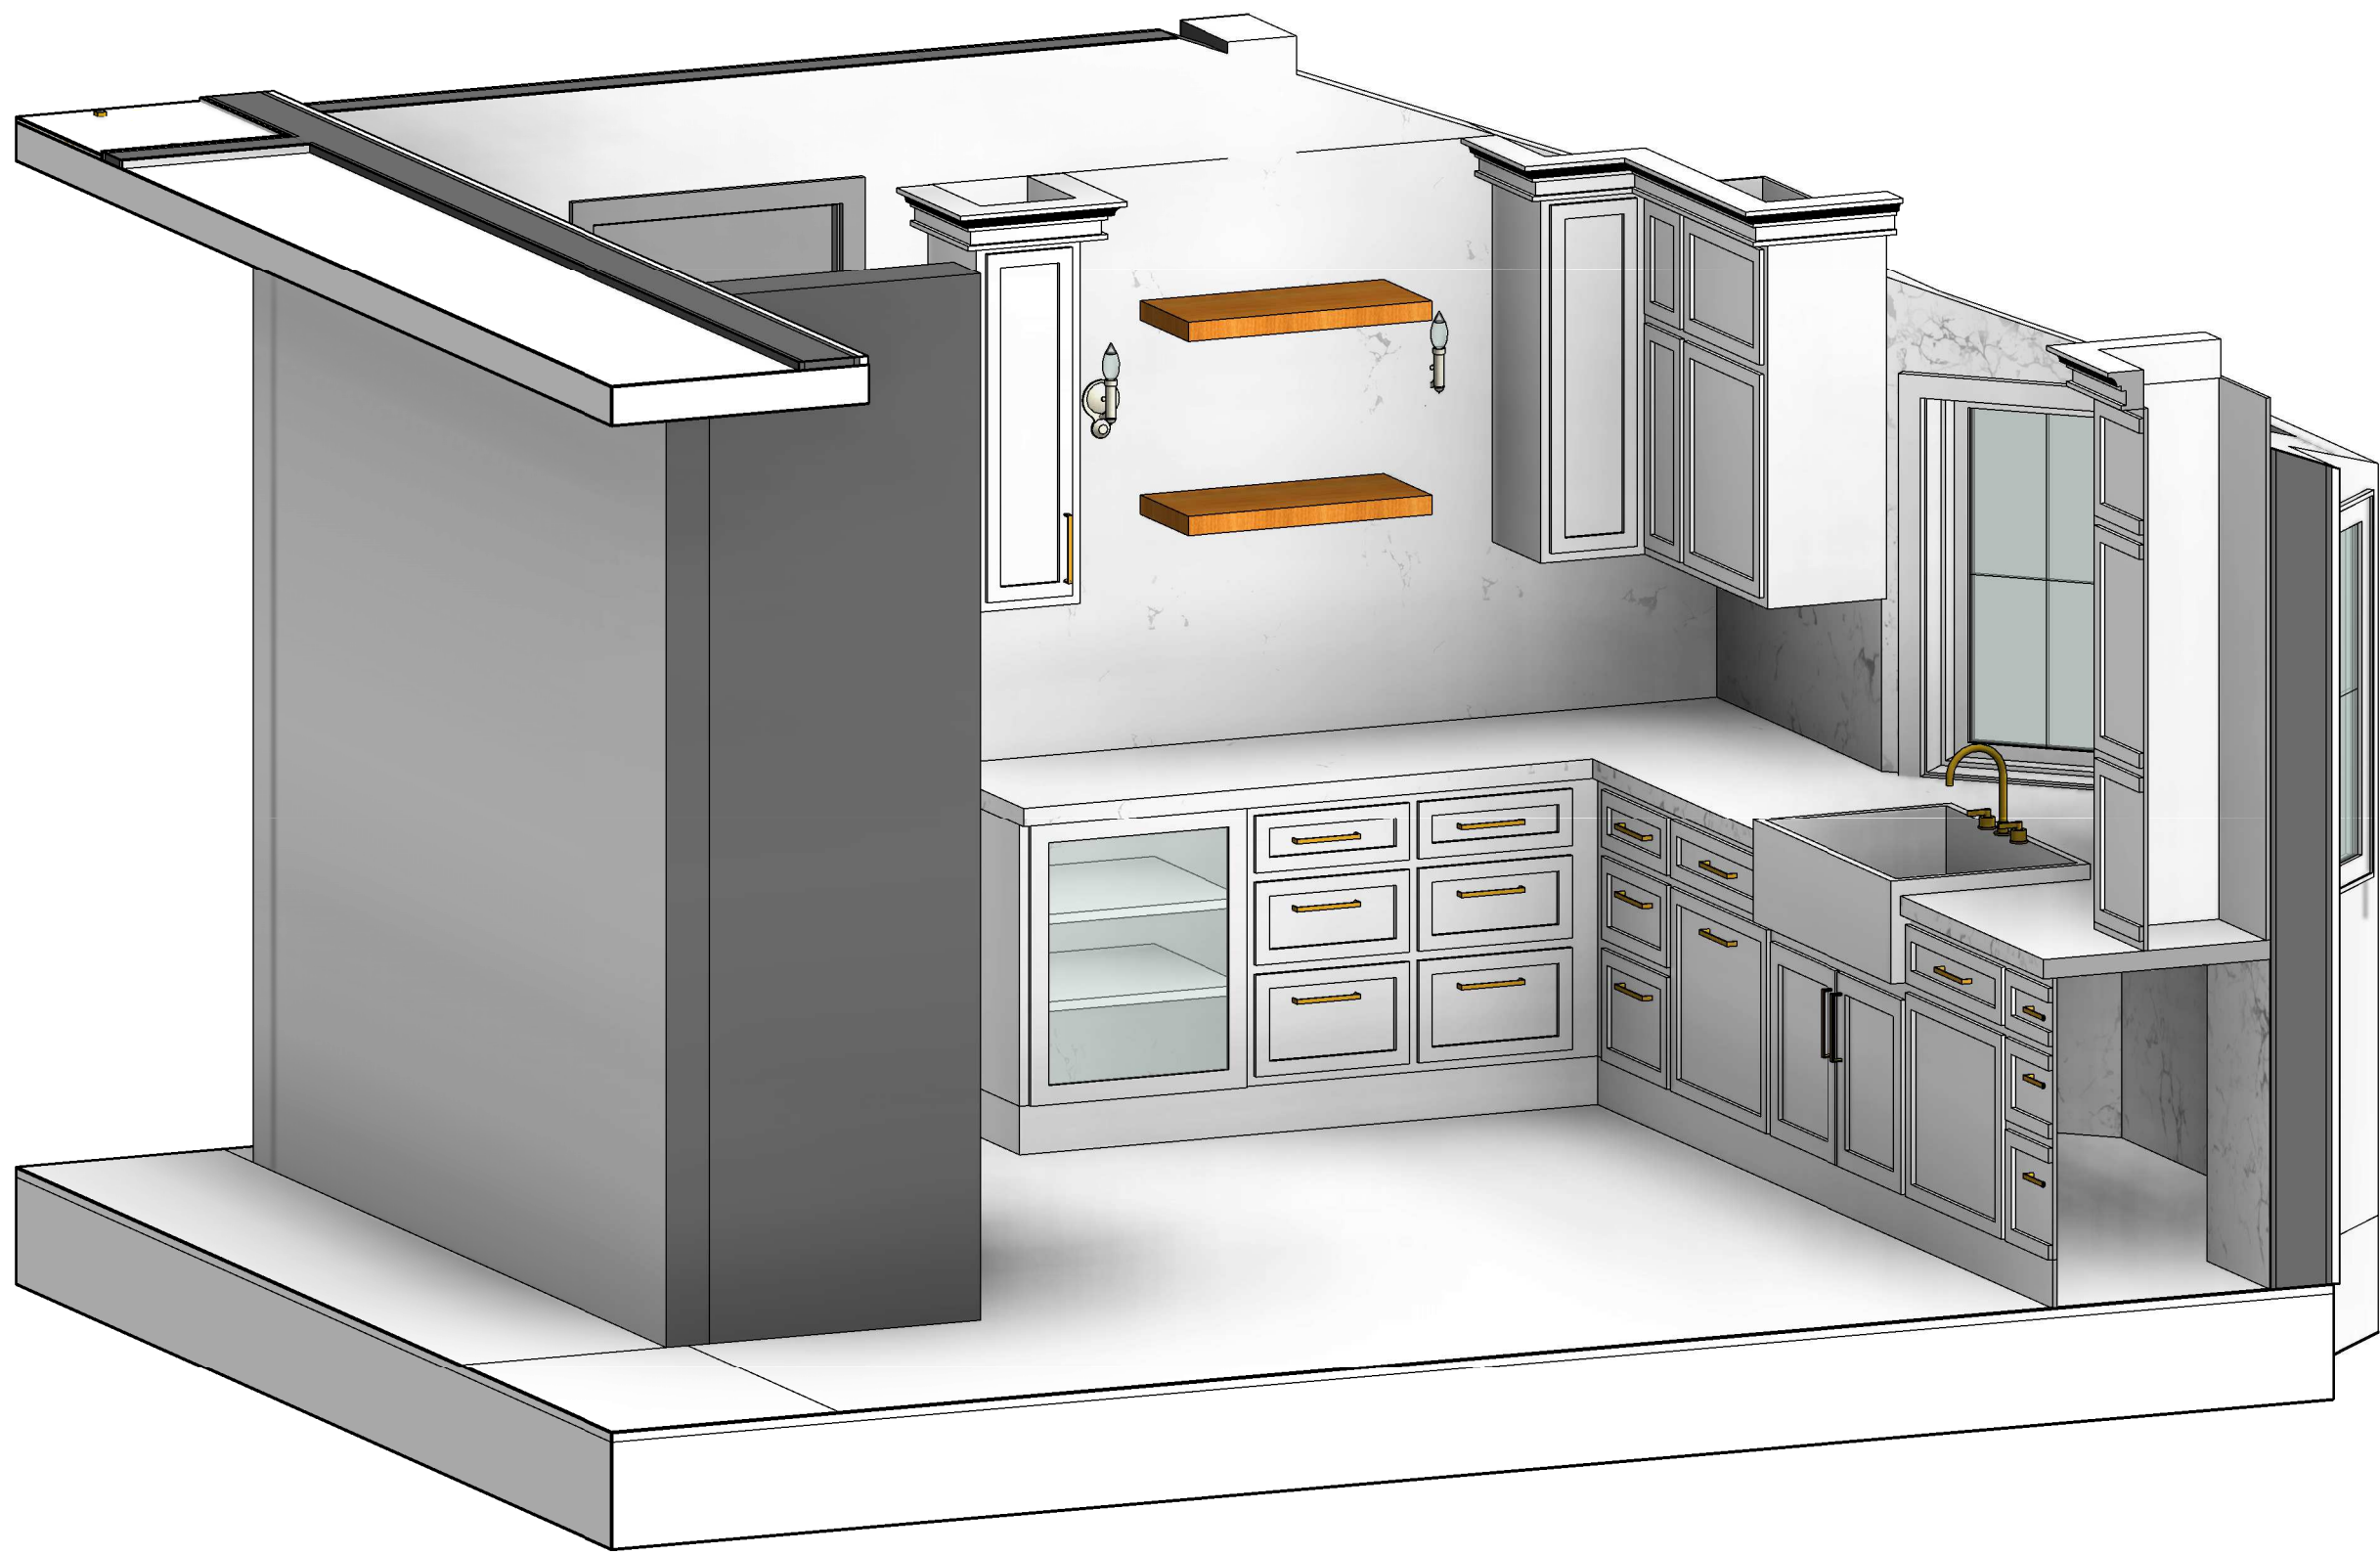

3 KITCHEN VIEW-2

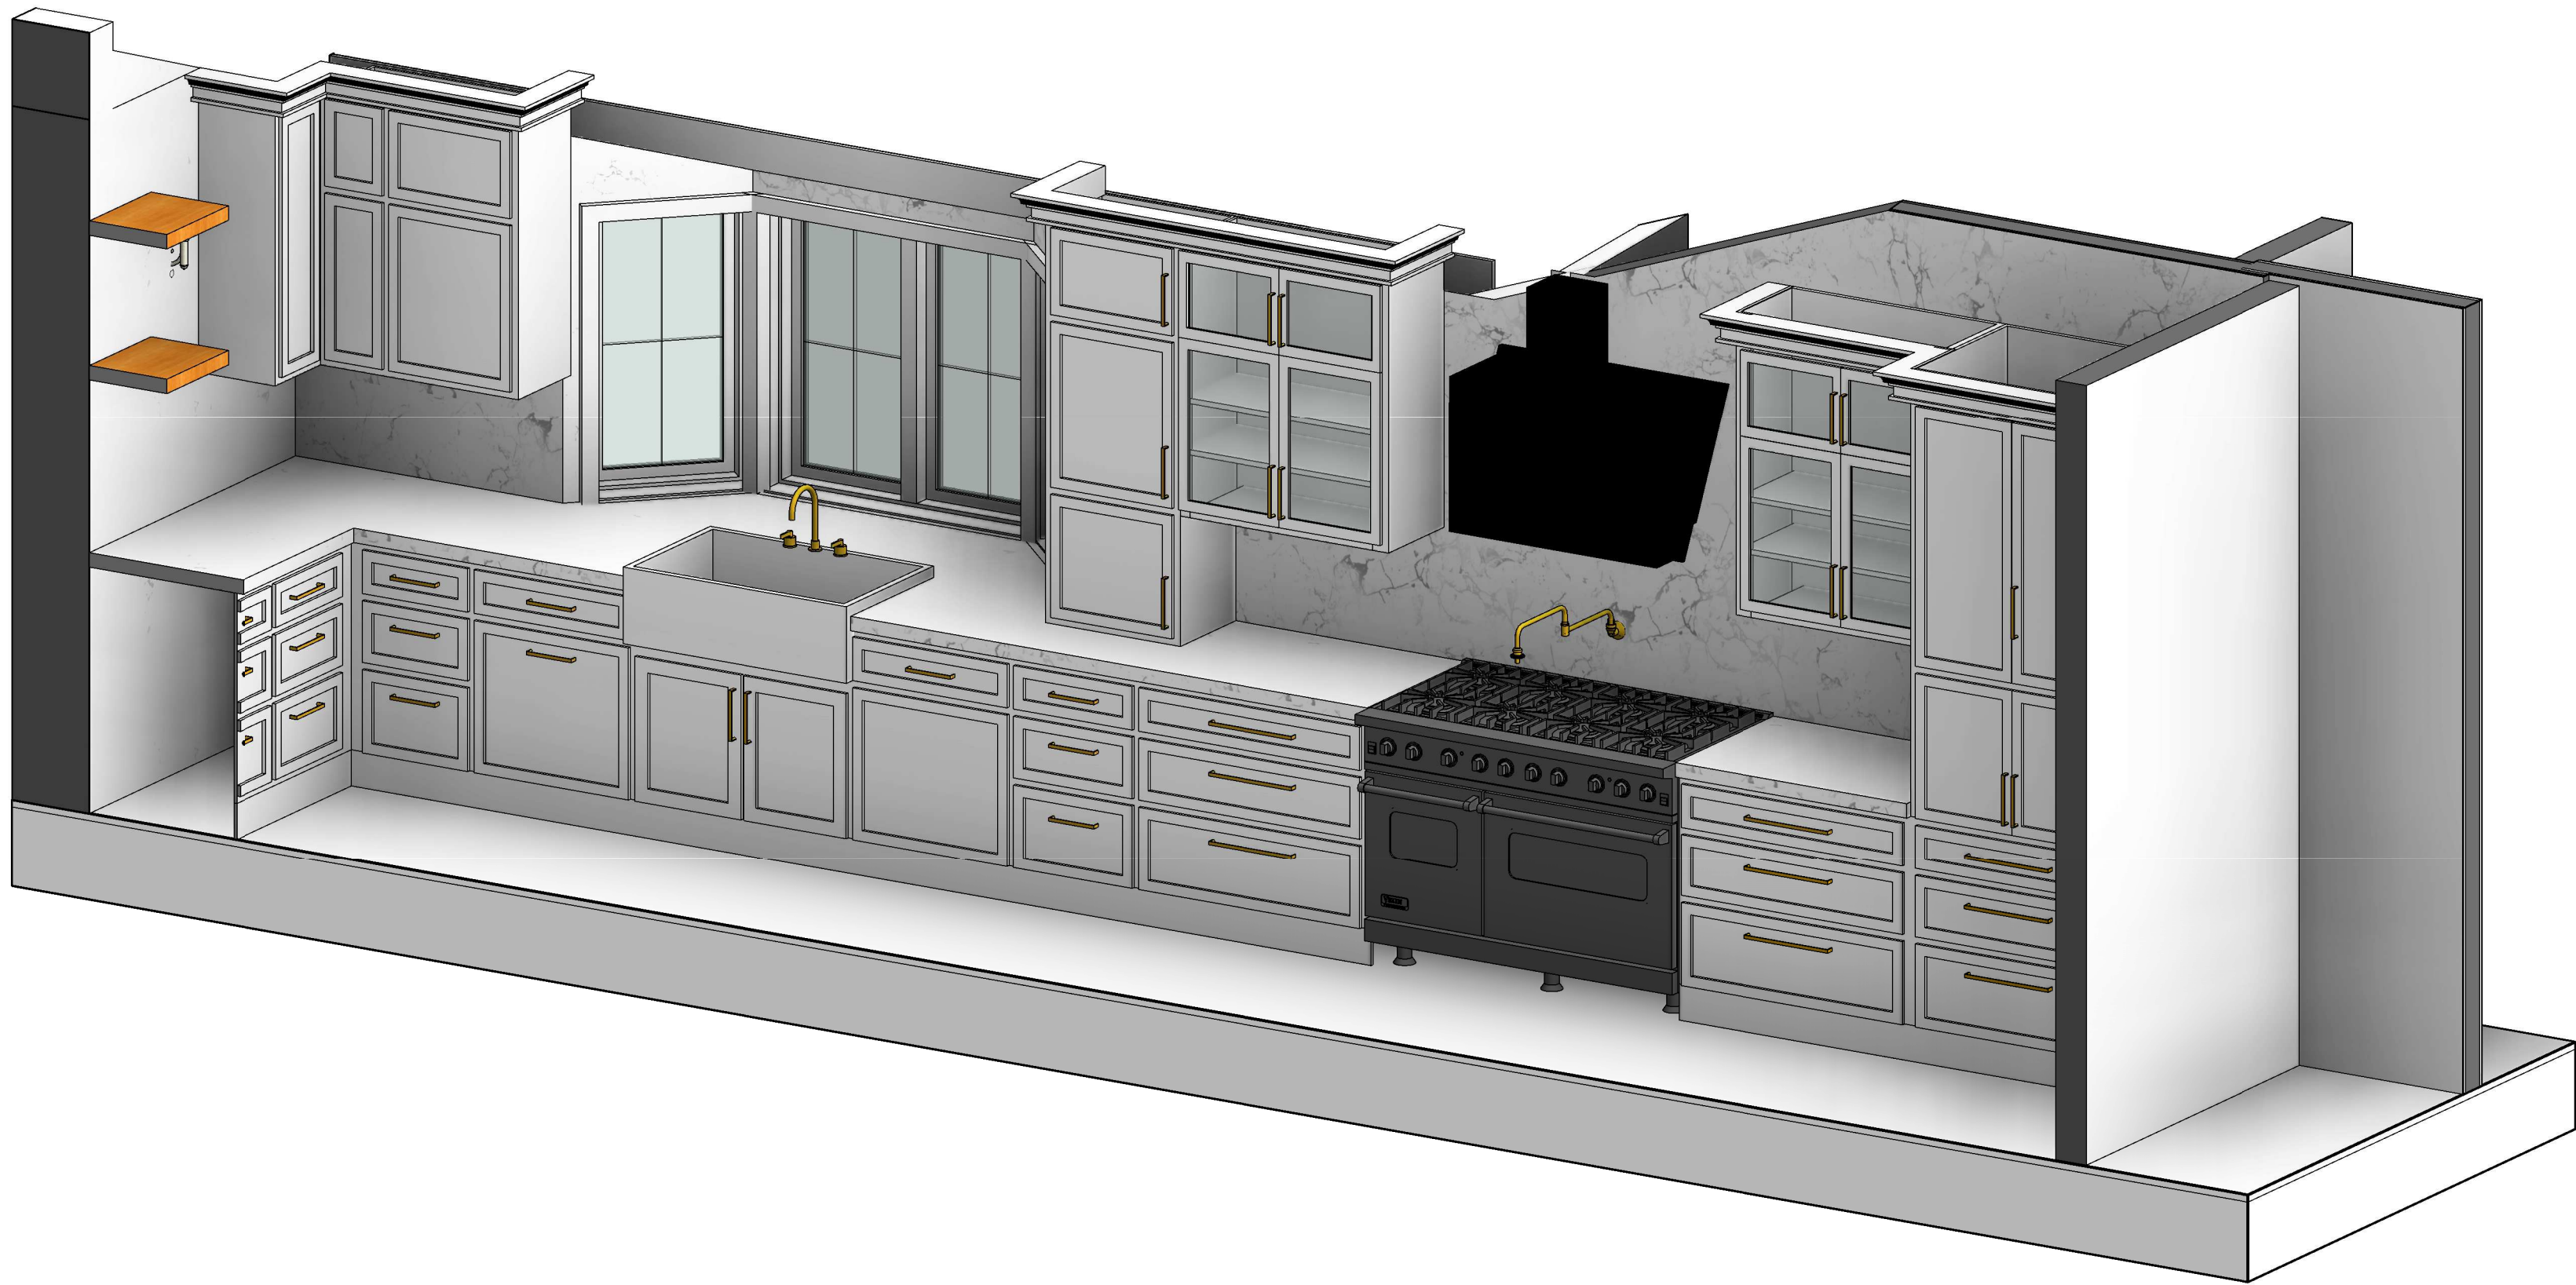

2 KITCHEN VIEW-3

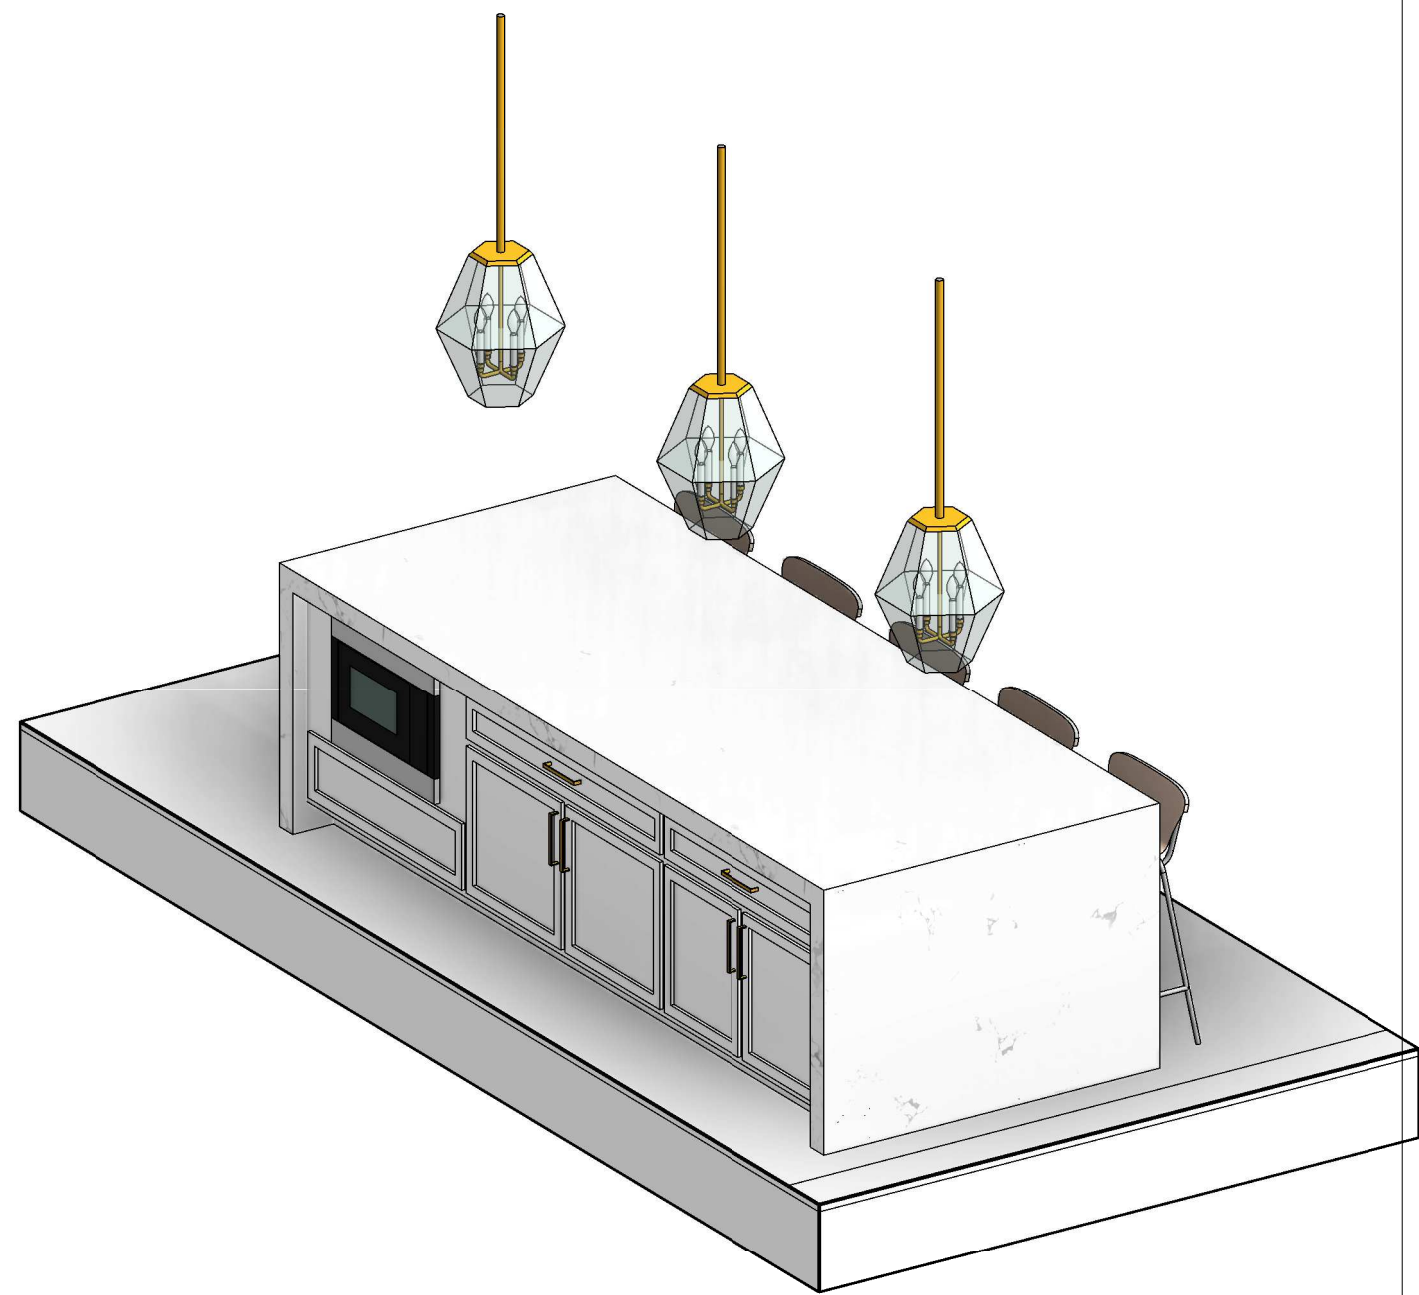

4 KITCHEN VIEW-4


KEY NOTE	
N1	ADD GAS TO EXISTING FIRE PLACE
N2	REFURBISH EXISTING FIRE PLACE INTO 2 SIDED FIRE PLACE
N3	OUTDOOR BBQ
N4	NEW FLOORING
N5	REMOVE FLAT CEILING
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N11	NEW BIDET
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N13	REFURBISH EXISTING WALL, PREP FOR NEW SHEAR WALL PER STRUCTURAL
N14	18" X 24" ROOF VENT 72 SQ.INCH EACH
E1	EXISTING SKYLIGHT TO REMAIN

LEGEND	
	FIXTURE TAG REFER TO A8.9 & A8.10
	FINISH TAG REFER TO A8.9


DELTA DESCRIPTION:	
DATE:	CITY SUBMITTAL
22/09/17	
No.	
1	
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DATE:	22/09/17
SCALE:	3" = 1'-0"
DRAWN BY :	
CKD BY:	
PROJECT :	202107199




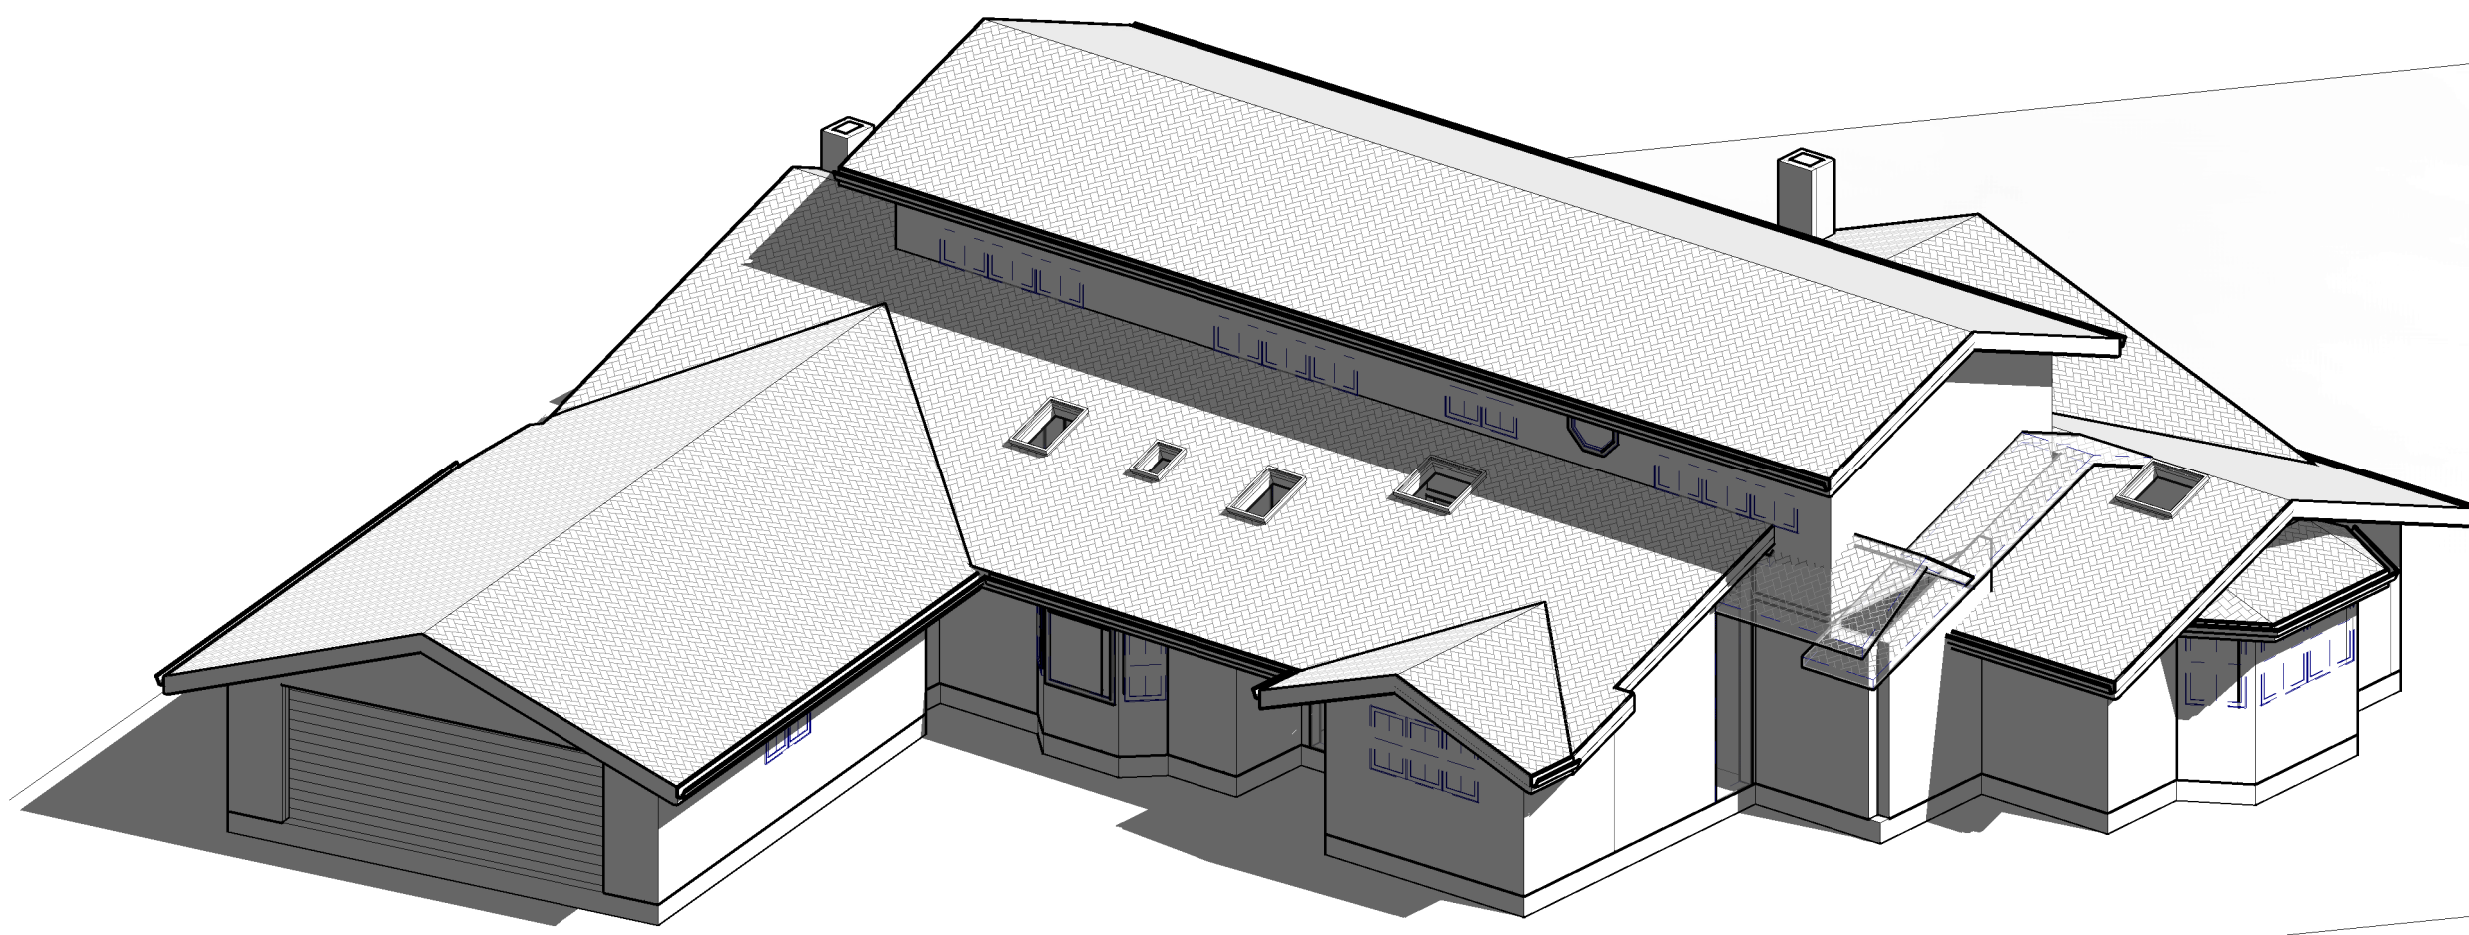


1 EXISTING 3D VIEW-1

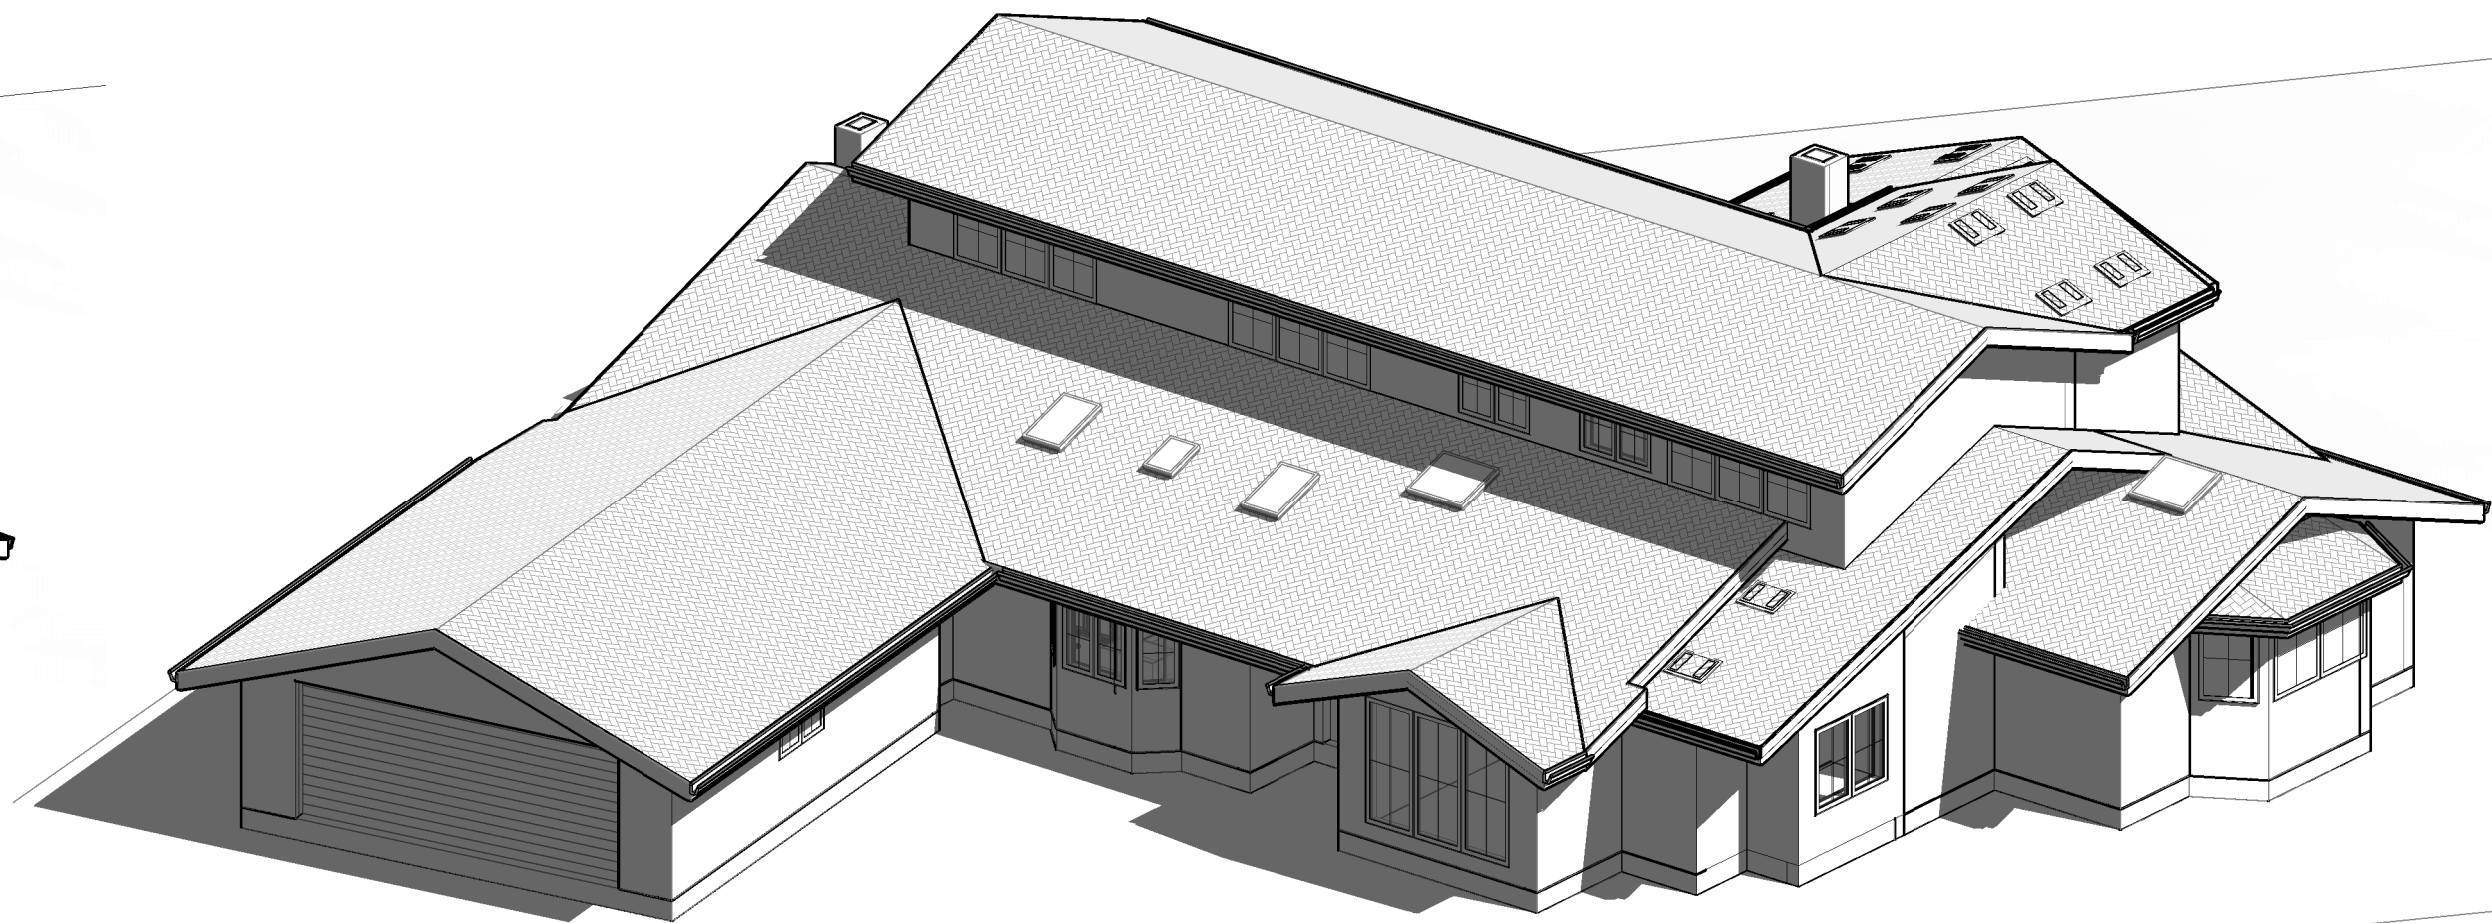

2 PROPOSED 3D VIEW-1

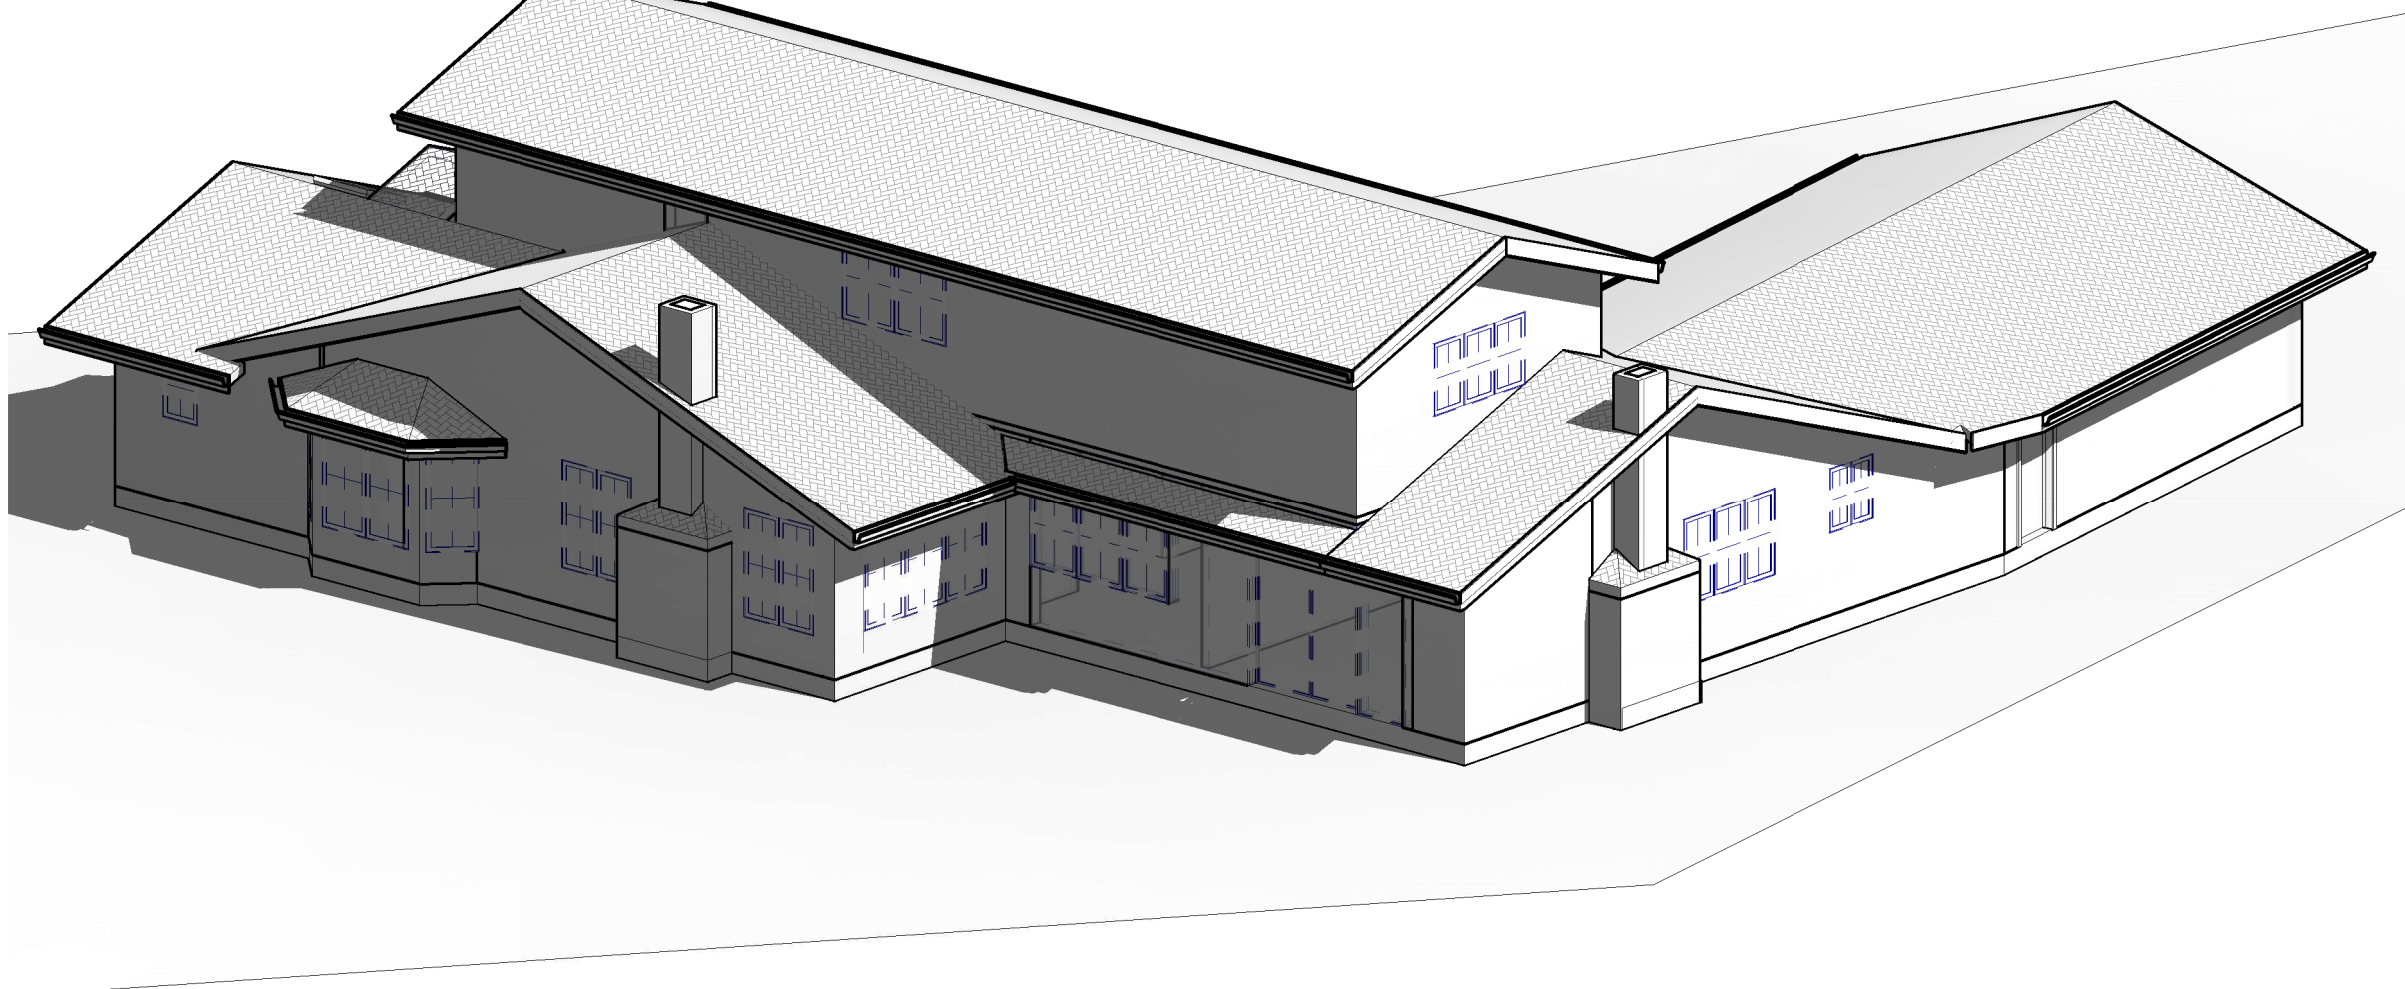

3 EXISTING 3D VIEW-2

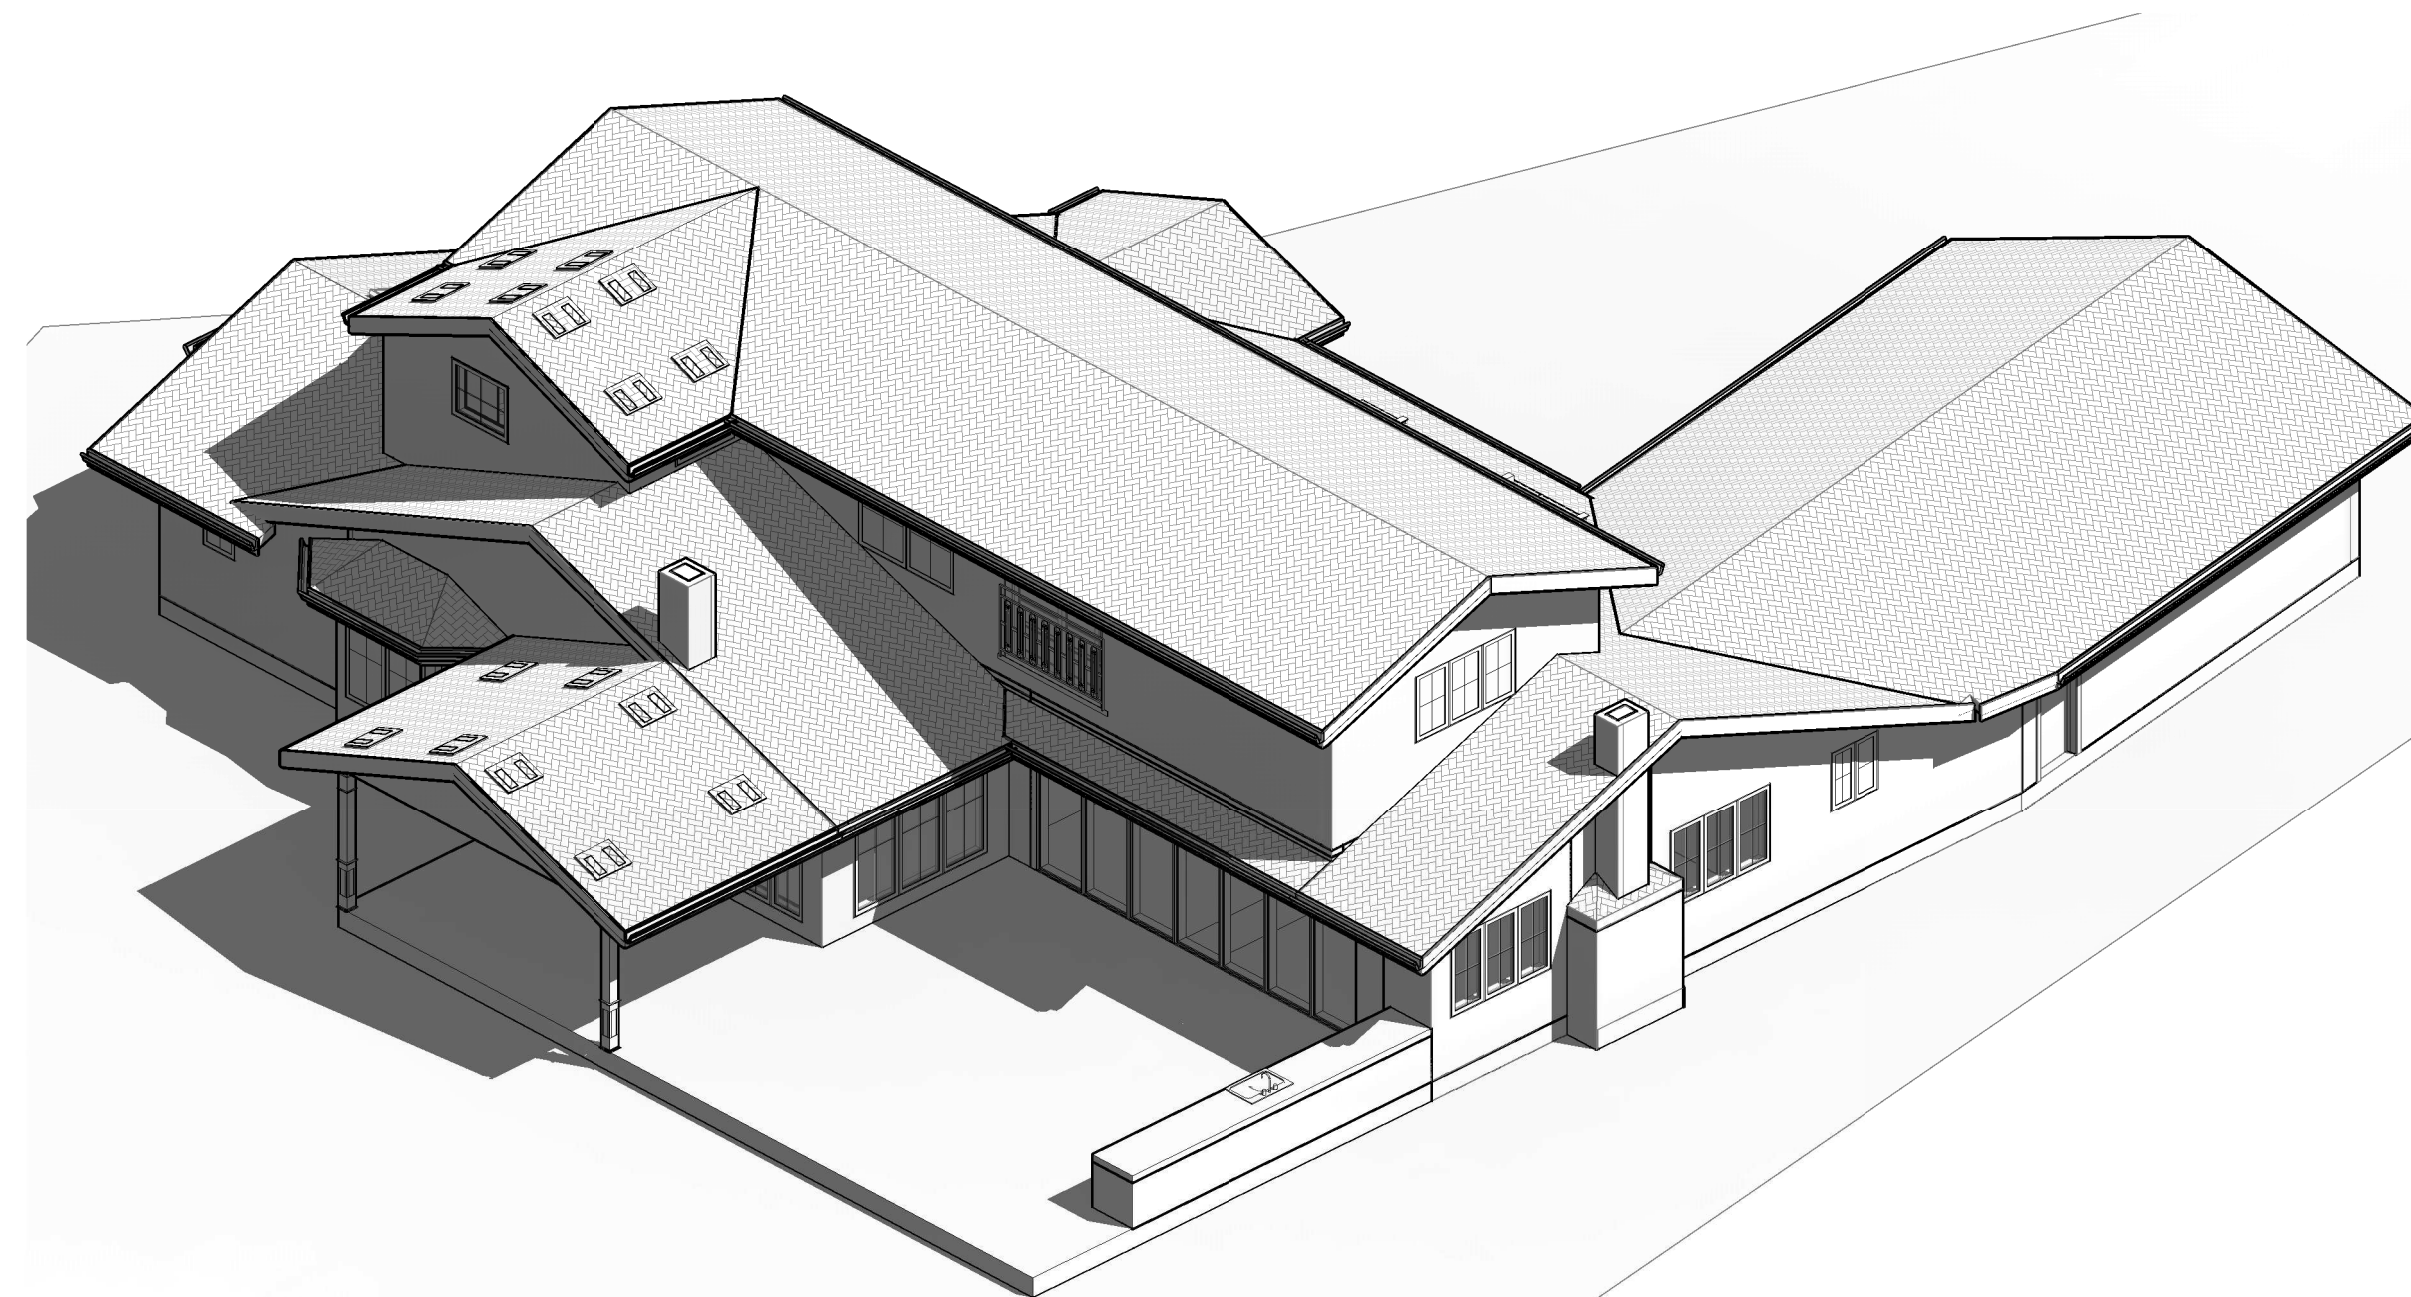


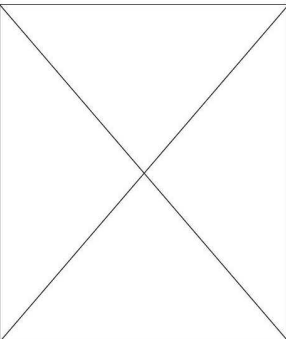
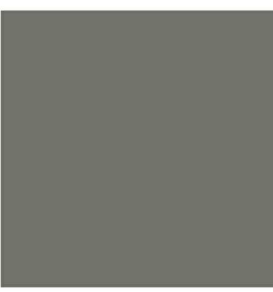

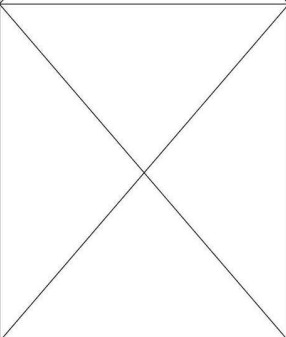



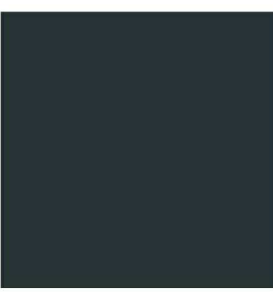












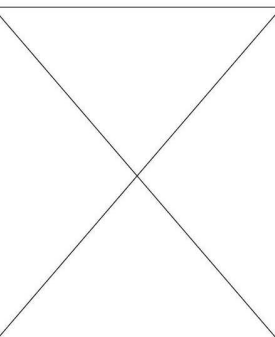
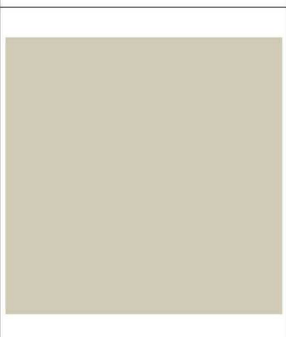
4 PROPOSED 3D VIEW-2

No.	DATE:	DELTA DESCRIPTION:
1	22/09/17	CITY SUBMITTAL
2		
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4		



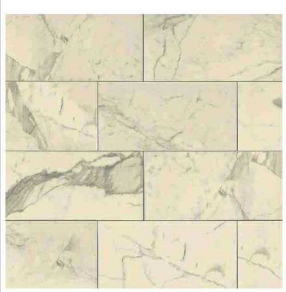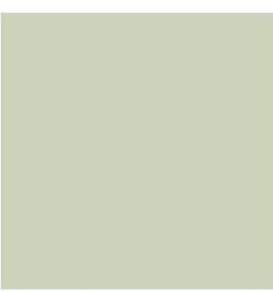

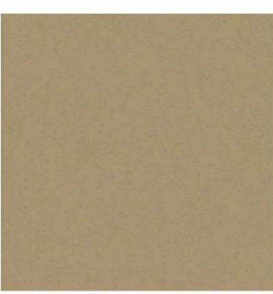DATE:	22/09/17
SCALE:	
DRAWN BY :	
CKD BY:	
PROJECT :	202107199



FINISHES
























ST-1		DESCRIPTION: MARBLE LOCATION: 104 - KITCHEN COUNTERTOPS & BACKSPLASH SOURCE: BY GC STYLE/PATTERN: CALACATTA MARBLE - HONED SIZE: 3 CM @ COUNTERTOP; 2 CM @ BACKSPLASH NOTES: EASED EDGE; APPLY MANUF. RECOMMENDED SEALER; CLIENT TO APPROVE SLAB PRIOR TO PURCHASE	T-4		NOT USED	WD-2		DESCRIPTION: PAINTED WOOD LOCATION: 112 - MASTER BATH VANITY SOURCE: CABINET MAKER COLOR: MATCH SHERWIN WILLIAMS 7066 GRAY MATTERS FINISH: SATIN
ST-2		DESCRIPTION: MARBLE LOCATION: 102 - HALF BATH COUNTERTOP SOURCE: BY GC STYLE/PATTERN: CALACATTA MARBLE - HONED SIZE: 2 CM NOTES: EASED EDGE; APPLY MANUF. RECOMMENDED SEALER; CLIENT TO APPROVE SLAB PRIOR TO PURCHASE	T-5		NOT USED	WD-3		DESCRIPTION: NATURAL WOOD LOCATION: 104 - KITCHEN SHELVES SOURCE: CABINET MAKER SPECIES: OAK COLOR: STAIN TO MATCH WD-5
ST-3		DESCRIPTION: MARBLE LOCATION: 112 - MASTER BATH COUNTERTOP SOURCE: BY GC STYLE/PATTERN: WHITE CARRARA MARBLE - HONED SIZE: 2 CM NOTES: EASED EDGE; APPLY MANUF. RECOMMENDED SEALER; CLIENT TO APPROVE SLAB PRIOR TO PURCHASE	T-6		DESCRIPTION: CALACATTA ORO - CAO LOCATION: 202 -BATH WALL & FLOOR SOURCE: BEDROSIANS STYLE/PATTERN: STPCL2CAO1224 MATTE SIZE: 12" X 24" NOTES: INSTALL IN RUNNING BOND PATTERN PER PLANS; 1/8" GROUT	WD-4		DESCRIPTION: PAINTED WOOD LOCATION: 205 - BATH SOURCE: CABINET MAKER COLOR: MATCH SHERWIN WILLIAMS 7615 SEA SERPENT FINISH: SATIN
ST-4		DESCRIPTION: PORCELAIN LOCATION: 205 - BATH COUNTERTOP SOURCE: BEDROSIANS STYLE/PATTERN: MAGNIFICA ENCORE PORCELAIN STATUARIETTO SIZE: 12 MM	T-6.1		DESCRIPTION: CALACATTA ORO - CAO PORCELAIN TILE LOCATION: 202 -BATH ACCENT WALL SOURCE: BEDROSIANS STYLE/PATTERN: STPCL2CAO26MO MATTE SIZE: 2" X 6" NOTES: INSTALL IN RUNNING BOND PATTERN PER PLANS; 1/8" GROUT	WD-5		DESCRIPTION: ENGINEERED WOOD FLOORING LOCATION: FIELD FLOORING THROUGHOUT U.N.O. SOURCE: MANNINGTON FLOORS STYLE/PATTERN: TIMBERPLUS COLOR: BRANCH TBRP08BRN1 SIZE: 8" WIDE PLANKS
ST-5		DESCRIPTION: PORCELAIN LOCATION: 202 - BATH COUNTERTOP SOURCE: BEDROSIANS STYLE/PATTERN: MAGNIFICA ENCORE PORCELAIN CALACATTA ORO SIZE: 12 MM	T-7		DESCRIPTION: STATUARIETTO CLASSIC PORCELAIN TILE LOCATION: 205 - BATH FLOOR & WALL SOURCE: BEDROSIANS STYLE/PATTERN: STPCLAST1224M MATTE SIZE: 12" X 24" NOTES: INSTALL IN RUNNING BOND PATTERN PER PLANS; 1/8" GROUT	PT-1		DESCRIPTION: PAINT LOCATION: FIELD PAINT THROUGHOUT U.N.O. SOURCE: SHERWIN WILLIAMS COLOR: SW 7005 PURE WHITE CEILING FINISH: FLAT; WALL FINISH: EGGSHELL; MILLWORK FINISH: SEMI-GLOSS NOTES: TWO (2) COATS OF LATEX PAINT OVER ONE (1) COAT OF LATEX PRIMER
T-1		DESCRIPTION: WHITE CARRARA MARBLE TILE W/ HONED FINISH LOCATION: 112 - MASTER BATH WALL & FLOOR SOURCE: BEDROSIANS STYLE/PATTERN: MRBWHTCAR1224H SIZE: 12"X24" NOTES: INSTALL IN RUNNING BOND PATTERN; 1/8" GROUT; APPLY MANUF. RECOMMENDED SEALER	T-8		DESCRIPTION: WHITE CARRARA MOSAIC HONED LOCATION: 112 - MASTER BATH FLOOR @ ACCENT LOCATIONS SOURCE: BEDROSIANS STYLE/PATTERN: 100001415 SIZE: 12 1/8" X 12 1/8" SHEET NOTES: INSTALL PER PLANS; 1/8" GROUT; APPLY MANUF. RECOMMENDED SEALER	F-1		DESCRIPTION: UPHOLSTERY FABRIC LOCATION: 114 - READING ROOM SOURCE: KRAVET / PERIGOLD COLOR: VELVET LIGHT BROWN
T-2		DESCRIPTION: NERO MARQUINA MARBLE TILE HONED LOCATION: 112 - MASTER BATH FLOOR SOURCE: BEDROSIANS STYLE/PATTERN: 100001381 SIZE: 2"X8" NOTES: INSTALL SINGLE LINEAR ROW IN RUNNING BOND PATTERN PER PLANS; 1/8" GROUT; APPLY MANUF. RECOMMENDED SEALER	GL-1		DESCRIPTION: CLEAR GLASS LOCATION: 104 - KITCHEN CABINETS SOURCE: BY GC - MATCH BENDHEIM LOW-IRON CRYSTAL FLAT STYLE/PATTERN: CLEAR LOW-IRON SIZE: 1/4" THICK	WP-1		DESCRIPTION: WALLPAPER LOCATION: 102 - HALF BATH ACCENT WALL SOURCE: WILLIAM MORRIS / ANTHROPOLOGIE STYLE/PATTERN: SIMPLY SEVERN COLOR: IVORY NOTES: GC TO PREP WALL TO LEVEL 5 FINISH
T-3		NOT USED	WD-1		DESCRIPTION: PAINTED WOOD LOCATION: 104 - KITCHEN CABINETS, 102- HALF BATH, 202 - BATH SOURCE: CABINET MAKER COLOR: MATCH SHERWIN WILLIAMS 7044 SNOWBOUND FINISH: SATIN			

HARDWARE & ACCESSORIES








MI-01		DESCRIPTION: RECTANGULAR MIRROR LOCATION: 102 - HALF BATH SOURCE: POTTERY BARN STYLE/PATTERN: WARM BRONZE VINTAGE ROUNDED RECTANGULAR MIRROR 19X23" WITH D-RING MOUNT FINISH: ANTIQUE BRASS	HW-01		DESCRIPTION: DRAWER PULL LOCATION: 104 - KITCHEN DRAWERS SOURCE: SIGNATURE HARDWARE STYLE/PATTERN: STRASBOURG SOLID BRASS CABINET PULL FINISH: POLISHED BRASS SIZE: 8" NOTES: FOR KITCHEN DRAWERS GREATER THAN 2' WIDE
MI-02		DESCRIPTION: DECORATIVE MIRROR LOCATION: 112 - MASTER BATH SOURCE: ANTHROPOLOGIE STYLE/PATTERN: 60461217 APERTURE PORTRAIT MIRROR FINISH: GOLD SIZE: 24" X 40"X 1"D	HW-02		DESCRIPTION: DRAWER PULL LOCATION: 104 - KITCHEN DRAWERS SOURCE: SIGNATURE HARDWARE STYLE/PATTERN: STRASBOURG SOLID BRASS CABINET PULL FINISH: POLISHED BRASS SIZE: 3-3/4" NOTES: FOR KITCHEN DRAWERS LESS THAN 2' WIDE
MI-03		DESCRIPTION: CIRCULAR MIRROR LOCATION: 202 & 205 - BATH VANITY MIRROR SOURCE: SHADES OF LIGHT STYLE/PATTERN: KEYHOLE ROUND METAL MIRROR SKU MW17075 GL FINISH: BRONZED GOLD SIZE: 30.5"H X 25.5"W X 1"D	HW-03		DESCRIPTION: CABINET KNOB LOCATION: 104 - KITCHEN CABINETS SOURCE: SIGNATURE HARDWARE STYLE/PATTERN: STRASBOURG BRASS CABINET KNOB FINISH: POLISHED BRASS SIZE: 1-1/4" DIA. NOTES: FOR KITCHEN CABINETS
MI-03 ALT		DESCRIPTION: CIRCULAR MIRROR LOCATION: 202 & 205 - BATH VANITY MIRROR SOURCE: ANTHROPOLOGIE STYLE/PATTERN: 35418706 HOOP MIRROR FINISH: BRONZE 027 SIZE: 36.5"H X 30"W X 1"D			



PLUMBING FIXTURES

FX-01		DESCRIPTION: KITCHEN FAUCET LOCATION: 104 - KITCHEN SOURCE: HOUSE OF ROHL STYLE/PATTERN: PERRIN & ROWE GEORGIAN ERA BRIDGE KITCHEN FAUCET W/ SIDESPRAY U.4719 FINISH: SATIN ENGLISH GOLD	FX-07.1		DESCRIPTION: POP-UP DRAIN LOCATION: 102 - HALF BATH, 205 - BATH SOURCE: REJUVENATION HARDWARE STYLE/PATTERN: SOFT-TOUCH POP-UP DRAIN #C4668 FINISH: AGED BRASS	FX-14.1		DESCRIPTION: SHOWER HEAD LOCATION: 112 - MASTER BATH SOURCE: REJUVENATION HARDWARE STYLE/PATTERN: ROUND CONTEMPORARY SHOWER HEAD #C104913 FINISH: AGED BRASS
FX-02		DESCRIPTION: KITCHEN SINK LOCATION: 104 - KITCHEN SOURCE: KOHLER STYLE/PATTERN: WHITEHAVEN UNDERMOUNT SINGLE-BOWL FARMHOUSE KITCHEN SINK K-5827 COLOR: 0 WHITE NOTES: CLIENT TO CONFIRM ADDITIONAL ACCESSORIES	FX-08		DESCRIPTION: VESSEL SINK LOCATION: 202 - BATH SOURCE: SIGNATURE HARDWARE STYLE/PATTERN: MILFORDE PORCELAIN SEMI-RECESSED SINK SKU 914433	FX-15		DESCRIPTION: SHOWER SET LOCATION: 205 - BATH SOURCE: REJUVENATION HARDWARE STYLE/PATTERN: ROLLINS PRESSURE BALANCED SHOWER SET W/ HANDSHOWER #C5219 FINISH: AGED BRASS
FX-03		DESCRIPTION: HOT WATER FAUCET LOCATION: 104 - KITCHEN SOURCE: HOUSE OF ROHL STYLE/PATTERN: PERRIN & ROWE GEORGIAN ERA C-SPOUT HOT WATERFAUCET U.1307LS FINISH: SATIN ENGLISH GOLD NOTES: CLIENT TO CONFIRM IF FX-03 OR FX-03 ALT OR NEITHER IS PREFERRED; GC TO COORDINATE FILTER	FX-09		DESCRIPTION: FAUCET LOCATION: 202 - BATH SOURCE: REJUVENATION HARDWARE STYLE/PATTERN: LETA SINGLE-HOLE VESSEL FAUCET W/ POP-UP DRAIN SKU910802 FINISH: POLISHED BRASS	FX-15.1		DESCRIPTION: SHOWER HEAD LOCATION: 205 - BATH SOURCE: REJUVENATION HARDWARE STYLE/PATTERN: ROUND CONTEMPORARY SHOWER HEAD #C104913 FINISH: AGED BRASS
FX-03 ALT		DESCRIPTION: FILTERED WATER FAUCET LOCATION: 104 - KITCHEN SOURCE: HOUSE OF ROHL STYLE/PATTERN: PERRIN & ROWE GEORGIAN ERA C-SPOUT FILTER FAUCET U.1625 FINISH: SATIN ENGLISH GOLD NOTES: CLIENT TO CONFIRM IF FX-03 OR FX-03 ALT OR NEITHER IS PREFERRED; GC TO COORDINATE FILTER	FX-10		DESCRIPTION: TOILET LOCATION: 112 - MASTER BATH SOURCE: KOHLER STYLE/PATTERN: EIR COMFORT HEIGHT K-77795 COLOR: 0 WHITE	FX-16		DESCRIPTION: SHOWER DRAIN LOCATION: 112 - MASTER BATH, 205 - BATH SOURCE: REJUVENATION HARDWARE STYLE/PATTERN: CONTEMPORARY SQUARE GRILLED SHOWER DRAIN ASSEMBLY #C6988 FINISH: AGED BRASS
FX-04		DESCRIPTION: SOAP DISPENSER LOCATION: 104 - KITCHEN SOURCE: HOUSE OF ROHL STYLE/PATTERN: PERRIN & ROWE GEORGIAN ERA DECK MOUNT SOAP DISPENSER U.6695 FINISH: SATIN ENGLISH GOLD	FX-11		DESCRIPTION: TOILET LOCATION: 102, 202, 205 - BATH SOURCE: KOHLER STYLE/PATTERN: MEMOIRS STATELY COMFORT HEIGHT K-6428 COLOR: 0 WHITE	FX-17		DESCRIPTION: SHOWER DRAIN LOCATION: 112 - MASTER BATH SOURCE: REJUVENATION HARDWARE STYLE/PATTERN: CONTEMPORARY SQUARE GRILLED SHOWER DRAIN ASSEMBLY #C6988 FINISH: AGED BRASS
FX-05		DESCRIPTION: POT FILLER LOCATION: 104 - KITCHEN SOURCE: HOUSE OF ROHL STYLE/PATTERN: PERRIN & ROWE WALL MOUNT SWING ARM POT FILLER U.4799LS FINISH: SATIN ENGLISH GOLD	FX-12		DESCRIPTION: FREESTANDING TUB LOCATION: 112 - MASTER BATH SOURCE: KOHLER STYLE/PATTERN: MEMOIRS 66-3/16" 36-7/16" FREESTANDING BATH K-8333 COLOR: 0 WHITE	FX-18		DESCRIPTION: FAUCET LOCATION: 112 - MASTER BATH SOURCE: REJUVENATION HARDWARE STYLE/PATTERN: WEST SLOPE CROSS HANDLE WALL MOUNT FAUCET #C4405 FINISH: AGED BRASS
FX-06		DESCRIPTION: UNDERMOUNT SINK LOCATION: 102 - HALF BATH SOURCE: KOHLER STYLE/PATTERN: MEMOIRS K-2339 FINISH: 0 WHITE	FX-13		DESCRIPTION: FLOOR MOUNTED TUB FAUCET LOCATION: 112 - MASTER BATH SOURCE: REJUVENATION HARDWARE STYLE/PATTERN: WEST SLOPE FLOOR MOUNTED TUB FILLER WITH HANDSHOWER #C6658 FINISH: AGED BRASS	FX-18.1		DESCRIPTION: POP-UP DRAIN LOCATION: 112 - MASTER BATH SOURCE: REJUVENATION HARDWARE STYLE/PATTERN: SOFT-TOUCH POP-UP DRAIN #C4668 FINISH: AGED BRASS
FX-07		DESCRIPTION: WALL MOUNTED FAUCET LOCATION: 102 - HALF BATH, 205 - BATH SOURCE: REJUVENATION HARDWARE STYLE/PATTERN: CAN-2.2-CN4 WIDESPREAD WALL MOUNTED LAVATORY #C100001 FINISH: AGED BRASS	FX-14		DESCRIPTION: SHOWER SET LOCATION: 112 - MASTER BATH SOURCE: REJUVENATION HARDWARE STYLE/PATTERN: WEST SLOPE THERMOSTATIC SHOWER SET WITH HANDSHOWER #C3690 FINISH: AGED BRASS	FX-19		DESCRIPTION: VESSEL SINK LOCATION: 205 - BATH SOURCE: SIGNATURE HARDWARE STYLE/PATTERN: HIBISCUS RECTANGULAR FIRECLAY VESSEL SINK SKU 948624 FINISH: WHITE

LIGHTING

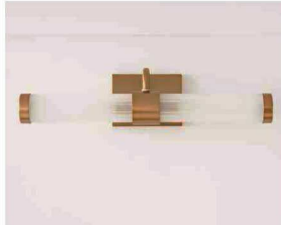LT-01		DESCRIPTION: SCONCE LOCATION: 112 - MASTER BATH SOURCE: CIRCA LIGHTING STYLE/PATTERN: CAMILLE SCONCE SK 2016HAB-L FINISH: HAND-RUBBED ANTIQUE BRASS & LINEN	LT-05		DESCRIPTION: SCONCE LOCATION: 202 - BATH SOURCE: CIRCA LIGHTING STYLE/PATTERN: KATIE SMALL GLOBE SCONCE #TOB 2225HAB/G4-CG FINISH: HAND-RUBBED ANTIQUE BRASS & CLEAR GLASS	OPTIONAL LIGHT AT 202 VERIFY WITH OWNER
LT-02		DESCRIPTION: SCONCE LOCATION: 104 - KITCHEN SOURCE: VISUAL COMFORT & CO. STYLE/PATTERN: TT SINGLE SCONCE SL 2860AN FINISH: HAND-RUBBED ANTIQUE BRASS & LINEN	LT-06		DESCRIPTION: PENDANT LOCATION: 112 - MASTER BATH SOURCE: CIRCA LIGHTING STYLE/PATTERN: LORFORD LARGE SMOKE BELL LANTERN #CHC 2271GI-MG FINISH: GILDED IRON & MERCURY GLASS	OPTIONAL LIGHT AT 112 VERIFY WITH OWNER
LT-03		DESCRIPTION: PENDANT LOCATION: 104 - KITCHEN SOURCE: CIRCA LIGHTING STYLE/PATTERN: RIVERSIDE MEDIUM SQUARE LANTERN #CHC 3439AB-CG FINISH: ANTIQUE BURNISHED BRASS & CLEAR GLASS	LT-07		DESCRIPTION: SCONCE LOCATION: 205 - BATH SOURCE: ANTHROPOLOGIE STYLE/PATTERN: INGRAM VANITY SCONCE 54523295 FINISH: BRASS 027	
LT-04		DESCRIPTION: SCONCE LOCATION: 102 - HALF BATH SOURCE: ANTHROPOLOGIE STYLE/PATTERN: ELISE VANITY SCONCE 59974550 FINISH: BRASS 027				OPTIONAL LIGHT AT 102 VERIFY WITH OWNER

DESIGN EVEREST

CONSULTING ENGINEERS

365 FLOWER LANE  
MOUNTAIN VIEW, CA 64043  
PHONE: (888) 311-3015 FAX: (650) 695-1801

SCHEDULE SHEET

AHMED RENOVATION  
ALINA AHMED  
LOT 15  
1081 NOTTINGHAM WAY  
LOS ALTOS, CA 94024

DELTA DESCRIPTION:  
CITY SUBMITTAL

DATE:  
22/09/17

No.  
A

No.  
A

No.  
A

No.  
A

No.  
A

DATE: 22/09/17

SCALE:

DRAWN BY :

CKD BY:

PROJECT : 202107199

DRAWING NO.

A-8.10



CERTIFICATE OF COMPLIANCE  
Project Name: 1081 Nottingham Way  
Calculation Description: Title 24 Analysis

Calculation Date/Time: 2022-06-22T18:53:32-07:00  
Input File Name: 220341ea\_RD.ribd19x

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GENERAL INFORMATION										
01	Project Name		1081 Nottingham Way							
02	Run Title		Title 24 Analysis							
03	Project Location		1081 Nottingham Way							
04	City		Los Altos			05	Standards Version		2019	
06	Zip code		94024			07	Software Version		EnergyPro 8.3	
08	Climate Zone		4			09	Front Orientation (deg/ Cardinal)		180	
10	Building Type		Single family			11	Number of Dwelling Units		1	
12	Project Scope		AdditionAlteration			13	Number of Bedrooms		4	
14	Addition Cond. Floor Area (ft²)		170			15	Number of Stories		2	
16	Existing Cond. Floor Area (ft²)		3739.27			17	Fenestration Average U-factor		0.35	
18	Total Cond. Floor Area (ft²)		3909.27			19	Glazing Percentage (%)		18.54%	
20	ADU Bedroom Count		n/a			21	ADU Conditioned Floor Area		n/a	
22	Is Natural Gas Available?		Yes							

COMPLIANCE RESULTS	
01	Building Complies with Computer Performance
02	Building does not require field testing or HERS verification
03	Building does not incorporate Special Features

ENERGY USE SUMMARY				
Energy Use (kTDU/ft²-yr)	Standard Design	Proposed Design	Compliance Margin	Percent Improvement
Space Heating	85.15	87.11	-1.96	-2.3
Space Cooling	87.87	83.69	4.18	4.8
IAQ Ventilation	0	0	0	
Water Heating	9.74	9.74	0	0
Self Utilization/Flexibility Credit	n/a	0	0	n/a
Compliance Energy Total	182.76	180.54	2.22	1.2

Registration Number: 422-P010094810A-000-000-0000000-0000  
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CA Building Energy Efficiency Standards - 2019 Residential Compliance

Registration Date/Time: 06/22/2022 21:00  
Report Version: 2019.2.000  
Schema Version: rev 20200901

HERS Provider: CHEERS  
Report Generated: 2022-06-22 18:54:57

CERTIFICATE OF COMPLIANCE  
Project Name: 1081 Nottingham Way  
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CF1R-PRF-01E  
(Page 2 of 13)

REQUIRED SPECIAL FEATURES										
The following are features that must be installed as condition for meeting the modeled energy performance for this computer analysis.										
• NO SPECIAL FEATURES REQUIRED										
HERS FEATURE SUMMARY										
The following is a summary of the features that must be field-verified by a certified HERS Rater as a condition for meeting the modeled energy performance for this computer analysis. Additional detail is provided in the building tables below. Registered CF2Rs and CF3Rs are required to be completed in the HERS Registry										
Building-level Verifications: • -- None -- Cooling System Verifications: • -- None -- Heating System Verifications: • -- None -- HVAC Distribution System Verifications: • -- None -- Domestic Hot Water System Verifications: • -- None --										

01	02	03	04	05	06	07
Project Name	Conditioned Floor Area (ft²)	Number of Dwelling Units	Number of Bedrooms	Number of Zones	Number of Ventilation Cooling Systems	Number of Water Heating Systems
1081 Nottingham Way	3909.27	1	4	4	0	1

01	02	03	04	05	06	07
Zone Name	Zone Type	HVAC System Name	Zone Floor Area (ft²)	Avg. Ceiling Height	Water Heating System 1	Water Heating System 2
Existing 1st Floor Zone	Conditioned	Existing HVAC1	2974.27	8	DHW Sys 1	N/A
Addition 1st Floor Zone	Conditioned	Existing HVAC1	65	8	DHW Sys 1	N/A
Existing 2nd Floor Zone	Conditioned	Existing HVAC1	765	8	DHW Sys 1	N/A
Addition 2nd Floor Zone	Conditioned	Existing HVAC1	105	8	DHW Sys 1	N/A

Registration Number: 422-P010094810A-000-000-0000000-0000  
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01	02	03	04	05	06	07	08	09	10	11
Name	Zone	Construction	Azimuth	Orientation	Gross Area (ft²)	Window and Door Area (ft2)	Tilt (deg)	Wall Exceptions	Status	Verified Existing Condition
North Wall (Existing)	Existing 1st Floor Zone	R-0 Wall	0	Back	576	213.3	90	none	Existing	No
East Wall (Existing)	Existing 1st Floor Zone	R-0 Wall	90	Right	448	25.7	90	none	Existing	No
South Wall (Existing)	Existing 1st Floor Zone	R-0 Wall	180	Front	504	113	90	none	Existing	No
West Wall (Existing)	Existing 1st Floor Zone	R-0 Wall	270	Left	547	104.5	90	none	Existing	No
Northwest Wall (Existing)	Existing 1st Floor Zone	R-0 Wall	315	n/a	16	11.7	90	none	Existing	No
Northeast Wall (Existing)	Existing 1st Floor Zone	R-0 Wall	45	n/a	16	10.7	90	none	Existing	No
Southeast Wall (Existing)	Existing 1st Floor Zone	R-0 Wall	135	n/a	32	16.8	90	none	Existing	No
Southwest Wall (Existing)	Existing 1st Floor Zone	R-0 Wall	225	n/a	16	6.1	90	none	Existing	No
East Wall (New)	Addition 1st Floor Zone	R-15 Wall	90	Right	99	20	90	Extension	New	n/a
South Wall (New)	Addition 1st Floor Zone	R-15 Wall	180	Front	72	0	90	Extension	New	n/a
North Wall (Existing) 2	Existing 2nd Floor Zone	R-0 Wall	0	Back	312	64	90	none	Existing	No
East Wall (Existing) 2	Existing 2nd Floor Zone	R-0 Wall	90	Right	136	0	90	none	Existing	No
South Wall (Existing) 2	Existing 2nd Floor Zone	R-0 Wall	180	Front	458	104.1	90	none	Existing	No
West Wall (Existing) 2	Existing 2nd Floor Zone	R-0 Wall	270	Left	136	20	90	none	Existing	No
North Wall (New)	Addition 2nd Floor Zone	R-15 Wall	0	Back	144	10	90	Extension	New	n/a

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01	02	03	04	05	06	07	08	09	10	11
Name	Zone	Construction	Azimuth	Orientation	Gross Area (ft²)	Window and Door Area (ft2)	Tilt (deg)	Wall Exceptions	Status	Verified Existing Condition
East Wall (New) 2	Addition 2nd Floor Zone	R-15 Wall	90	Right	63	0	90	Extension	New	n/a
West Wall (New)	Addition 2nd Floor Zone	R-15 Wall	270	Left	63	12	90	Extension	New	n/a
Interior Surface	Addition 1st Floor Zone	R-0 Wall1	n/a	n/a	100	0	n/a		New	n/a
Interior Surface 2	Addition 1st Floor Zone	R-0 Wall1	n/a	n/a	100	0	n/a		New	n/a
Interior Surface 3	Addition 2nd Floor Zone	R-0 Wall1	n/a	n/a	100	0	n/a		New	n/a
Roof (Existing) 2	Existing 1st Floor Zone	R-0 Roof Attic	n/a	n/a	2940.27	n/a	n/a		Existing	No
Roof (Existing) 3	Existing 2nd Floor Zone	R-0 Roof Attic	n/a	n/a	765	n/a	n/a		Existing	No
Raised Floor (Existing)	Existing 1st Floor Zone	R-0 Floor Crawlspace	n/a	n/a	2974.27	n/a	n/a		Existing	No
Raised Floor (New)	Addition 1st Floor Zone	R-19 Floor Crawlspace	n/a	n/a	65	n/a	n/a		New	n/a
Interior Surface 4	Existing 2nd Floor Zone	R-0 Floor No Crawlspace	n/a	n/a	765	n/a	n/a		New	n/a
Interior Surface 5	Addition 2nd Floor Zone	R-0 Floor No Crawlspace	n/a	n/a	105	n/a	n/a		New	n/a

01	02	03	04	05	06	07	08	09	10	11	12	13	14
Name	Zone	Construction	Azimuth	Orientation	Area (ft²)	Skylight Area (ft²)	Roof Rise (x in 12)	Roof Reflectance	Roof Emittance	Cool Roof	Status	Verified Existing Condition	Existing Construction
Roof (Existing)	Existing 1st Floor Zone	R-0 Roof Attic1	0	Back	34.1	34	4	0.1	0.85	No	Existing	No	

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01	02	03	04	05	06	07	08	09	10	11	12	13	14
Name	Zone	Construction	Azimuth	Orientation	Area (ft²)	Skylight Area (ft²)	Roof Rise (x in 12)	Roof Reflectance	Roof Emittance	Cool Roof	Status	Verified Existing Condition	Existing Construction
Roof (New)	Addition 1st Floor Zone	R-30 Roof	0	Back	65	0	4	0.1	0.85	No	New	n/a	
Roof (New) 2	Addition 2nd Floor Zone	R-30 Roof	0	Back	105	0	4	0.1	0.85	No	New	n/a	

01	02	03	04	05	06	07	08	09	10	11	12	13	14	15	16
Name	Construction	Type	Roof Rise (x in 12)	Roof Reflectance	Roof Emittance	Radiant Barrier	Cool Roof	Status	Verified Existing Condition						
Attic Existing 1st Floor Zone	Attic RoofExisting 1st Floor Zone	Ventilated	4	0.1	0.85	No	No	Existing	No						
Attic Existing 2nd Floor Zone	Attic RoofExisting 2nd Floor Zone	Ventilated	4	0.1	0.85	No	No	Existing	No						

01	02	03	04	05	06	07	08	09	10	11	12	13	14	15	16
Name	Type	Surface	Orientation	Azimuth	Width (ft)	Height (ft)	Mult.	Area (ft²)	U-factor	U-factor Source	SHGC	SHGC Source	Exterior Shading	Status	Verified Existing Condition
North Window (New)	Window	North Wall (Existing)	Back	0			1	134.3	0.35	NFRC	0.25	NFRC	Bug Screen	New	n/a
North Window (New) 2	Window	North Wall (Existing)	Back	0			1	24	0.35	NFRC	0.25	NFRC	Bug Screen	Altered	No
North Window (New) 3	Window	North Wall (Existing)	Back	0			1	24	0.35	NFRC	0.25	NFRC	Bug Screen	Altered	No
North Window (New) 4	Window	North Wall (Existing)	Back	0			1	25	0.35	NFRC	0.25	NFRC	Bug Screen	Altered	No

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01	02	03	04	05	06	07	08	09	10	11	12	13	14	15	16
Name	Type	Surface	Orientation	Azimuth	Width (ft)	Height (ft)	Mult.	Area (ft²)	U-factor	U-factor Source	SHGC	SHGC Source	Exterior Shading	Status	Verified Existing Condition
North Window (New) 5	Window	North Wall (Existing)	Back	0			1	6	0.35	NFRC	0.25	NFRC	Bug Screen	Altered	No
East Window (New)	Window	East Wall (Existing)	Right	90			1	25.7	0.35	NFRC	0.25	NFRC	Bug Screen	Altered	No
South Window (New)	Window	South Wall (Existing)	Front	180			1	24	0.35	NFRC	0.25	NFRC	Bug Screen	Altered	No
South Window (New) 2	Window	South Wall (Existing)	Front	180			1	48	0.35	NFRC	0.25	NFRC	Bug Screen	Altered	No
West Window (New)	Window	West Wall (Existing)	Left	270			1	48	0.35	NFRC	0.25	NFRC	Bug Screen	Altered	No
West Window (New) 2	Window	West Wall (Existing)	Left	270			1	24	0.35	NFRC	0.25	NFRC	Bug Screen	New	n/a
West Window (New) 3	Window	West Wall (Existing)	Left	270			1	24	0.35	NFRC	0.25	NFRC	Bug Screen	Altered	No
West Window (New) 4	Window	West Wall (Existing)	Left	270			1	8.5	0.35	NFRC	0.25	NFRC	Bug Screen	Altered	No
Northwest Window (New)	Window	Northwest Wall (Existing)		315			1	11.7	0.35	NFRC	0.25	NFRC	Bug Screen	Altered	No
Northeast Window (New)	Window	Northeast Wall (Existing)		45			1	10.7	0.35	NFRC	0.25	NFRC	Bug Screen	Altered	No
Southeast Window (New)	Window	Southeast Wall (Existing)		135			1	6.1	0.35	NFRC	0.25	NFRC	Bug Screen	Altered	No
Southeast Window (New) 2	Window	Southeast Wall (Existing)		135			1	10.7	0.35	NFRC	0.25	NFRC	Bug Screen	Altered	No
Southwest Window (New)	Window	Southwest Wall (Existing)		225			1	6.1	0.35	NFRC	0.25	NFRC	Bug Screen	Altered	No

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FENESTRATION / GLAZING															
01	02	03	04	05	06	07	08	09	10	11	12	13	14	15	16
Name	Type	Surface	Orientation	Azimuth	Width (ft)	Height (ft)	Mult.	Area (ft <sup>2</sup> )	U-factor	U-factor Source	SHGC	SHGC Source	Exterior Shading	Status	Verified Existing Condition
East Window (New) 2	Window	East Wall (New)	Right	90			1	20	0.35	NFRC	0.25	NFRC	Bug Screen	New	n/a
North Window (New) 6	Window	North Wall (Existing) 2	Back	0			1	40	0.35	NFRC	0.25	NFRC	Bug Screen	Altered	No
North Window (New) 7	Window	North Wall (Existing) 2	Back	0			1	24	0.35	NFRC	0.25	NFRC	Bug Screen	Altered	No
South Window (New) 3	Window	South Wall (Existing) 2	Front	180			1	26.7	0.35	NFRC	0.25	NFRC	Bug Screen	Altered	No
South Window (New) 4	Window	South Wall (Existing) 2	Front	180			1	26.7	0.35	NFRC	0.25	NFRC	Bug Screen	Altered	No
South Window (New) 5	Window	South Wall (Existing) 2	Front	180			1	12	0.35	NFRC	0.25	NFRC	Bug Screen	Altered	No
South Window (New) 6	Window	South Wall (Existing) 2	Front	180			1	12	0.35	NFRC	0.25	NFRC	Bug Screen	Altered	No
South Window (New) 7	Window	South Wall (Existing) 2	Front	180			1	26.7	0.35	NFRC	0.25	NFRC	Bug Screen	Altered	No
West Window (New) 5	Window	West Wall (Existing) 2	Left	270			1	20	0.35	NFRC	0.25	NFRC	Bug Screen	Altered	No
North Window (New) 8	Window	North Wall (New)	Back	0			1	10	0.35	NFRC	0.25	NFRC	Bug Screen	New	n/a
West Window (New) 6	Window	West Wall (New)	Left	270			1	12	0.35	NFRC	0.25	NFRC	Bug Screen	New	n/a
Skylight (Existing)	Skylight	Roof (Existing)	Back	0			1	34	1.3	Table 110.6-A	0.73	Table 110.6-B	None	Existing	No

01	02	03	04	05	06
Name	Side of Building	Area (ft <sup>2</sup> )	U-factor	Status	Verified Existing Condition
Solid Core Door	South Wall (Existing)	41	0.2	Altered	No

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01	02	03	04	05	06	07	08	09	10	11	12	13	14	15	16
Name	Type	Design Type	Supply	Return	Supply	Return	Supply	Return	Bypass Duct	Duct Leakage	HERS Verification	Status	Verified Existing Condition	Existing Distribution system	New Ducts 40 ft
											1-hers-dist				

01	02	03	04
Name	Type	Fan Power (Watts/CFM)	Name
HVAC Fan 1	HVAC Fan	0.45	HVAC Fan 1-hers-fan

01	02	03
Name	Verified Fan Watt Draw	Required Fan Efficacy (Watts/CFM)
HVAC Fan 1-hers-fan	Not Required	0

HERS RATER VERIFICATION OF EXISTING CONDITIONS
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01	02	03	04	05	06	07	08
Construction Name	Surface Type	Construction Type	Framing	Total Cavity R-value	Interior / Exterior Continuous R-value	U-factor	Assembly Layers
R-0 Wall	Exterior Walls	Wood Framed Wall	2x4 @ 16 in. O. C.	R-0	None / None	0.361	Inside Finish: Gypsum Board Cavity / Frame: no insul. / 2x4 Exterior Finish: 3 Coat Stucco
R-15 Wall	Exterior Walls	Wood Framed Wall	2x4 @ 16 in. O. C.	R-15	None / None	0.095	Inside Finish: Gypsum Board Cavity / Frame: R-15 / 2x4 Exterior Finish: 3 Coat Stucco
R-0 Roof Attic1	Cathedral Ceilings	Wood Framed Ceiling	2x4 @ 24 in. O. C.	R-0	None / None	0.494	Roofing: Light Roof (Asphalt Shingle) Roof Deck: Wood Siding/sheathing/decking Cavity / Frame: no insul. / 2x4 Inside Finish: Gypsum Board
R-30 Roof	Cathedral Ceilings	Wood Framed Ceiling	2x12 @ 16 in. O. C.	R-30	None / None	0.036	Roofing: Light Roof (Asphalt Shingle) Roof Deck: Wood Siding/sheathing/decking Cavity / Frame: R-30 / 2x12 Inside Finish: Gypsum Board
R-0 Wall1	Interior Walls	Wood Framed Wall	2x4 @ 16 in. O. C.	R-0	None / None	0.277	Inside Finish: Gypsum Board Cavity / Frame: no insul. / 2x4 Other Side Finish: Gypsum Board
Attic RoofExisting 1st Floor Zone	Attic Roofs	Wood Framed Ceiling	2x4 @ 24 in. O. C.	R-0	None / None	0.644	Roofing: Light Roof (Asphalt Shingle) Roof Deck: Wood Siding/sheathing/decking Cavity / Frame: no insul. / 2x4
Attic RoofExisting 2nd Floor Zone	Attic Roofs	Wood Framed Ceiling	2x4 @ 24 in. O. C.	R-0	None / None	0.644	Roofing: Light Roof (Asphalt Shingle) Roof Deck: Wood Siding/sheathing/decking Cavity / Frame: no insul. / 2x4

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DOCUMENTATION AUTHOR'S DECLARATION STATEMENT															
I, I certify that this Certificate of Compliance documentation is accurate and complete.															
Documentation Author Name: Raffi Dar										Documentation Author Signature: Raffi Dar					
Company: Precise Green Consulting Inc.										Signature Date: 06/22/2022					
Address: 3633 Urquidez Ave										CEA/HERS Certification Identification (If applicable):					
City/State/Zip: Glendale, CA 91208										Phone: (818) 446-6563					
RESPONSIBLE PERSON'S DECLARATION STATEMENT															
I certify the following under penalty of perjury, under the laws of the State of California:															
1. I am eligible under Division 3 of the Business and Professions Code to accept responsibility for the building design identified on this Certificate of Compliance.															
2. I certify that the energy features and performance specifications identified on this Certificate of Compliance conform to the requirements of Title 24, Part 1 and Part 6 of the California Code of Regulations.															
3. The building design features or system design features identified on this Certificate of Compliance are consistent with the information provided on other applicable compliance documents, worksheets, calculations, plans and specifications submitted to the enforcement agency for approval with this building permit application.															
Responsible Designer Name: Pisutitsuk Kittipongdaja										Responsible Designer Signature: Pisutitsuk Kittipongdaja					
Company: PK Studio										Date Signed: 06/22/2022					
Address: 1930 Georgia Ct										License:					
City/State/Zip: San Diego, CA 92104										Phone: 7026051913					

Digitally signed by Control Home Energy Efficiency Rating System Services, Inc. (CHEERS). This digital signature is provided in order to secure the content of this registered document, and in no way implies Registration Provider responsibility for the accuracy of the information.

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01	02	03	04	05	06	07	08
Construction Name	Surface Type	Construction Type	Framing	Total Cavity R-value	Interior / Exterior Continuous R-value	U-factor	Assembly Layers
R-0 Floor Crawlspace	Floors Over Crawlspace	Wood Framed Floor	2x12 @ 16 in. O. C.	R-0	None / None	0.216	Floor Surface: Carpeted Floor Deck: Wood Siding/sheathing/decking Cavity / Frame: no insul. / 2x12
R-19 Floor Crawlspace	Floors Over Crawlspace	Wood Framed Floor	2x6 @ 16 in. O. C.	R-19	None / None	0.05	Floor Surface: Carpeted Floor Deck: Wood Siding/sheathing/decking Cavity / Frame: R-19 in 5-1/2 in. (R-18) / 2x6
R-0 Roof Attic	Ceilings (below attic)	Wood Framed Ceiling	2x4 @ 24 in. O. C.	R-0	None / None	0.481	Cavity / Frame: no insul. / 2x4 Inside Finish: Gypsum Board
R-0 Floor No Crawlspace	Interior Floors	Wood Framed Floor	2x12 @ 16 in. O. C.	R-0	None / None	0.196	Floor Surface: Carpeted Floor Deck: Wood Siding/sheathing/decking Cavity / Frame: no insul. / 2x12 Ceiling Below Finish: Gypsum Board

BUILDING ENVELOPE - HERS VERIFICATION			
01	02	03	04
Quality Insulation Installation (QII)	High R-value Spray Foam Insulation	Building Envelope Air Leakage	CFM50
Not Required	Not Required	Not Required	n/a

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01	02	03	04	05	06	07	08	09	10
Name	System Type	Distribution Type	Water Heater Name (#)	Solar Heating System	Compact Distribution	HERS Verification	Status	Verified Existing Condition	Existing Water Heating System
DHW Sys 1	Domestic Hot Water (DHW)	Standard Distribution System	DHW Heater 1 (1)	n/a	None	n/a	Existing	No	

01	02	03	04	05	06	07	08	09	10	11	12	13	14
Name	Heating Element Type	Tank Type	# of Units	Tank Vol. (gal)	Energy Factor or Efficiency	Input Rating or Pilot	Tank Insulation R-value (Int/Ext)	Standby Loss or Recovery Eff	1st Hr. Rating or Flow Rate	NEEA Heat Pump Brand or Model	Tank Location or Ambient Condition	Status	Verified Existing Condition
DHW Heater 1	Gas	Small Storage	1	50	0.58-EF	<= 75 kBtu/hr	0	78	n/a	n/a	n/a	Existing	No

WATER HEATING - HERS VERIFICATION							
01	02	03	04	05	06	07	08
Name	Pipe Insulation	Parallel Piping	Compact Distribution	Compact Distribution Type	Recirculation Control	Central DHW Distribution	Shower Drain Water Heat Recovery
DHW Sys 1 - 1/1	Not Required	Not Required	Not Required	None	Not Required	Not Required	Not Required

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SPACE CONDITIONING SYSTEMS										
01	02	03	04	05	06	07	08	09	10	11
Name	System Type	Heating Unit Name	Cooling Unit Name	Fan Name	Distribution Name	Required Thermostat Type	Status	Verified Existing Condition	Heating Equipment Count	Cooling Equipment Count
Existing HVAC1	Heating and cooling system other	Heating Component 1	Cooling Component 1	HVAC Fan 1	Air Distribution System 1	n/a	Existing	No	1	1

HVAC - HEATING UNIT TYPES			
01	02	03	04
Name	System Type	Number of Units	Heating Efficiency
Heating Component 1	Central gas furnace	1	AFUE-78

HVAC - COOLING UNIT TYPES							
01	02	03	04	05	06	07	08
Name	System Type	Number of Units	Efficiency EER/CEER	Efficiency SEER	Zonally Controlled	Mult-speed Compressor	HERS Verification
Cooling Component 1	Central split AC	1	9.7	14	Not Zonal	Single Speed	Cooling Component 1-hers-cool

HVAC - DISTRIBUTION SYSTEMS															
01	02	03	04	05	06	07	08	09	10	11	12	13	14	15	16
			Duct Ins. R-value		Duct Location		Surface Area								
Name	Type	Design Type	Supply	Return	Supply	Return	Supply	Return	Bypass Duct	Duct Leakage	HERS Verification	Status	Verified Existing Condition	Existing Distribution system	New Ducts 40 ft
Air Distributi on System 1	Unconditioned attic	Non-Verified	R-6	R-6	Attic	Attic	n/a	n/a	No Bypass Duct	Existing (not specified)	Air Distributi on System	Existing	No	n/a	n/a

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DESIGN EVEREST  
CONSULTING ENGINEERS

365 FLOWER LANE  
MOUNTAIN VIEW, CA 64043  
PHONE: (888) 311-3015 FAX: (650) 695-1801

TITLE 24

AHMED RENOVATION  
ALINA AHMED  
LOT 15  
1081 NOTTINGHAM WAY  
LOS ALTOS, CA 94024

DELTA DESCRIPTION:  
CITY SUBMITTAL

DATE:  
22/09/17

No.  
A

A

A

A

A

DATE: 22/09/17

SCALE:

DRAWN BY :

CKD BY:

PROJECT : 202107199

DRAWING NO.

T24-03